

GENERAL NOTES

- THE DRAWINGS AND PROJECT MANUAL TOGETHER CONSTITUTE THE CONTRACT DOCUMENTS FOR CONSTRUCTION. ALL GENERAL REQUIREMENTS ARE TO BE MET AND ALL MATERIALS, FINISHES AND SYSTEMS ARE TO BE INSTALLED AND PERFORM PER SPECIFICATIONS UNLESS OTHERWISE NOTED.
- GENERAL CONTRACTOR SHALL VISIT THE SITE, REVIEW THE BUILDING SHELL DRAWINGS AS SUBMITTED BY THE LANDLORD OR STARBUCKS AND BECOME THOROUGHLY FAMILIAR WITH THE SITE CONDITIONS PRIOR TO CONSTRUCTION.
- GENERAL CONTRACTOR SHALL CONSULT WITH STARBUCKS CONSTRUCTION MANAGER TO RESOLVE ANY CHANGES, OMISSIONS OR PLAN DISCREPANCIES PRIOR TO CONSTRUCTION.
- ALL WORK SHALL BE PERFORMED IN STRICT COMPLIANCE WITH LOCAL, COUNTY, STATE AND FEDERAL CODES AND ORDINANCES.
- GENERAL CONTRACTOR SHALL VERIFY THE LOCATION OF ALL UTILITIES.
- GENERAL CONTRACTOR TO VERIFY ALL DIMENSIONS, INCLUDING CLEARANCES REQUIRED BY OTHER TRADES AND NOTIFY STARBUCKS CONSTRUCTION MANAGER OF ANY DISCREPANCIES PRIOR TO PROCEEDING WITH THE WORK. ALL DIMENSIONS ARE TO THE FACE OF THE FINISHED SURFACE UNLESS NOTED OTHERWISE. ALL DIMENSIONS TO BE TAKEN FROM DESIGNATED DATUM POINT. DO NOT SCALE DRAWINGS.
- GENERAL CONTRACTOR SHALL PATCH AND REPAIR ALL EXISTING WALLS, FLOORS, CEILINGS OR OTHER SURFACES IDENTIFIED TO REMAIN THAT MAY BECOME DAMAGED DURING THE COURSE OF THE WORK.
- THE GENERAL CONTRACTOR IS RESPONSIBLE FOR OBTAINING PERMITS FOR FIRE PROTECTION, PLUMBING, MECHANICAL AND ELECTRICAL SYSTEMS PRIOR TO INSTALLATION OF SUCH SYSTEMS.
- GENERAL CONTRACTOR SHALL RETAIN ONE SET OF PERMIT PLANS ON-SITE TO DOCUMENT ALL CHANGES MADE DURING CONSTRUCTION. THE RECORD DRAWINGS SHALL BE ISSUED TO THE OWNER AT PROJECT CLOSE-OUT AS DESCRIBED IN THE GENERAL REQUIREMENTS OF THE PROJECT MANUAL.
- GENERAL CONTRACTOR IS RESPONSIBLE FOR COORDINATING DELIVERY OF MATERIALS FROM STARBUCKS CONTRACTED THIRD PARTY LOGISTICS DISTRIBUTION SERVICES AND VENDOR DIRECT SHIPMENTS. SEE THE PROJECT MANUAL FOR ADDITIONAL INFORMATION.
- RESPONSIBILITY FOR SUPPLY AND DELIVERY OF MATERIALS AND EQUIPMENT IS IDENTIFIED IN THE DRAWING SCHEDULE SHEETS UNDER THE COLUMN LABELED "RESPONSIBILITY".
- FOR THE PURPOSE OF THE DOCUMENTS, TO "INSTALL" SHALL MEAN TO PROVIDE ALL FASTENERS, MISCELLANEOUS HARDWARE, BLOCKING, ELECTRICAL CONNECTIONS, PLUMBING CONNECTIONS AND OTHER ITEMS REQUIRED FOR A COMPLETE AND OPERATIONAL INSTALLATION, UNLESS NOTED OTHERWISE.
- ALL ITEM SUBSTITUTIONS MUST BE APPROVED BY THE STARBUCKS CONSTRUCTION MANAGER.

PROJECT CONTACTS

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FIXTURE CALCULATION

MIN Number of Plumbing Fixtures:

Occupant Load : 92 Indoor Occupancy
16 Outdoor Seating
92 + 16 = 108 Occupant

Distribution: Men: 54 Women: 54

7TH ED. 2020 FLORIDA PLUMBING CODE:

UNISEX

Water Closets 1 Per 75 Occupants
Lavatories 1 Per 200 Occupants
Urinals 0

Fixture	UNISEX	
	REQ'D	Provided
Water Closets	1	2
Urinals	0	0
Lavatories	1	2
Drinking Fountains	Not Required	

ARCHITECTURAL SYMBOL LEGEND

ABBREVIATIONS

A/C AIR CONDITIONING	FF&E FURNITURE, FIXTURE AND EQUIPMENT	OC ON CENTER
ACT ACOUSTICAL CEILING TILE	FLR FLOOR	O.D. OUTSIDE DIAMETER
ADJ ADJUSTABLE	FOH FRONT OF HOUSE	PIR PASSIVE INFRARED SENSOR
AFF ABOVE FINISHED FLOOR	FT FOOT/FEET	PLC PLACE
AMP AMPERE	G GROUND	R RADIUS
ARCH ARCHITECT	GC GENERAL CONTRACTOR	REF REFERENCE
BOH BACK OF HOUSE	HC HOLLOW CORE	REQ'D REQUIRED
CAB CABINET	HD HARDWARE	REV REVISION
CL CENTER LINE	HM HOLLOW METAL	RND ROUND
CLG CEILING	HORIZ HORIZONTAL	SB STARBUCKS
CM STARBUCKS CONSTRUCTION MANAGER	HR HOUR	SC SOLID CORE
CTR CENTER	HT HEIGHT	SF SQUARE FEET
CX COMMISSIONING	HVAC HEATING, VENTILATING AND AIR CONDITIONING	SHT SHEET
CXA COMMISSIONING AGENT	I.D. INSIDE DIAMETER	SIM SIMILAR
DEG DEGREE	LEED LEADERSHIP IN ENERGY AND ENVIRONMENTAL DESIGN	SPEC SPECIFICATION
DET DETAIL	LL LANDLORD	SQ SQUARE
DIA DIAMETER	MAX MAXIMUM	TEMP TEMPORARY
DIM DIMENSION	MEP MECHANICAL, ELECTRICAL AND PLUMBING	TYP TYPICAL
DM STARBUCKS DESIGN MANAGER	MFR MANUFACTURER	U.O.N UNLESS OTHERWISE NOTED
DN DOWN	MIN MINIMUM	VERT VERTICAL
EA EACH	NIC NOT IN CONTRACT	VIF VERIFY IN FIELD
EL ELEVATION	NL NIGHT LIGHT	
EQ EQUAL	NT NOT TO SCALE	
EXIST EXISTING		
EXT EXTERIOR		

INDEX OF SHEETS

LEGEND: X - SHEET ISSUED
R - SHEET ISSUED FOR REFERENCE AND COORDINATION ONLY
SEE TITLEBLOCK FOR REVISION ISSUE DATE(S)

SHEET	SHEET TITLE	BID SET	PERMIT SET	REVISION 1	REVISION 2	REVISION 3	REVISION 4
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GENERAL

G-001	GENERAL INFORMATION	X	X				
G-002	LIFE SAFETY ACCESSIBILITY PLAN	X	X				
G-002.1	OCCUPANCY LOAD PLAN	X	X				
G-003	ACCESSIBILITY GUIDELINES	X	X				
G-004	FOOD SERVICE PLAN	X	X				
G-005	GREENER STORE INFORMATION	X	X				
G-006	PRE-APPROVED CONST. MATERIALS	X	X				
G-007	PRE-APPROVED CONST. MATERIALS	X	X				

ARCHITECTURAL

A-101	BUILDING FLOOR PLAN	X	X				
A-102	BUILDING FLOOR PENETRATION PLAN	X	X				
A-104	REFLECTED CEILING PLAN	X	X				
A-105	DIMENSIONED CEILING AND LIGHTING PLAN	X	X				
A-501	BUILDING DETAILS	X	X				
A-502	BUILDING DETAILS	X	X				
A-503	BUILDING DETAILS	X	X				
A-504	WORKROOM DETAILS	X	X				
A-505	RESTROOM AND WORKROOM DETAILS	X	X				
A-601	WINDOW AND DOOR SCHEDULES & DETAILS	X	X				
SP-001	LL SITE PLAN	X	X				

INTERIORS

I-101	FF & E PLAN	X	X				
I-101.1	FF & E SCHEDULES	X	X				
I-102	CASEWORK PLAN	X	X				
I-102.1	ADAPTABLE CASEWORK BASE PLAN	X	X				
I-102.2	ADAPTABLE CASEWORK FRAMEWORK PLAN	X	X				
I-102.3	ADAPTABLE CASEWORK CABINET PLAN	X	X				
I-102.4	ADAPTABLE CASEWORK COUNTERTOP PLAN	X	X				
I-103	CASEWORK SCHEDULES	X	X				
I-106	FLOOR FINISH PLAN	X	X				
I-107	WALL FINISH PLAN	X	X				
I-201	INTERIOR FINISH ELEVATIONS	X	X				
I-202	INTERIOR FINISH ELEVATIONS	X	X				
I-203	INTERIOR FINISH ELEVATIONS	X	X				
I-204	INTERIOR FINISH ELEVATIONS	X	X				
I-205	PERSPECTIVE VIEW	X	X				
I-401	ENLARGED RESTROOM PLAN	X	X				
I-401.1	ENLARGED RESTROOM ELEVATIONS	X	X				
I-501	FLOOR FINISH DETAILS	X	X				
I-502	WALL FINISH DETAILS	X	X				
I-503	INTERIOR DETAILS	X	X				
I-504	INTERIOR DETAILS	X	X				
I-505	INTERIOR DETAILS	X	X				
I-506	INTERIOR DETAILS	X	X				
I-507	INTERIOR DETAILS	X	X				
I-508	INTERIOR DETAILS	X	X				
I-509	INTERIOR DETAILS	X	X				
I-510	INTERIOR DETAILS	X	X				
I-511	INTERIOR DETAILS	X	X				
I-601	SCHEDULES	X	X				
I-602	SCHEDULES	X	X				

PLUMBING

P-001	PLUMBING NOTES	X	X				
P-111	PLUMBING SUPPLY PLAN	X	X				
P-112	PLUMBING WASTE PLAN	X	X				
P-113	PLUMBING ISOMETRICS	X	X				
P-501	PLUMBING DETAILS	X	X				
P-601	PLUMBING SCHEDULES	X	X				

MECHANICAL

M-001	MECHANICAL NOTES	X	X				
M-101	MECHANICAL DESIGN PLAN	X	X				
M-601	MECHANICAL SCHEDULES	X	X				

ELECTRICAL

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E-004	ELECTRICAL SITE PLAN	X	X				
E-004.1	ELECTRICAL SITE DETAILS	X	X				
E-101	ELECTRICAL DESIGN PLAN	X	X				
E-102	LIGHTING DESIGN PLAN	X	X				
E-103	ELECTRICAL LOW VOLTAGE PLAN	X	X				
E-501	ELECTRICAL DETAILS	X	X				
E-502	ELECTRICAL DETAILS-EMS	X	X				
E-601	PANEL BOARD SCHEDULES	X	X				
EN-001	ENERGY CALCULATIONS	X	X				

SITE AND OCCUPANCY

PROJECT DESCRIPTION: NEW TENANT IMPROVEMENT

BUILDING HEIGHT: 1 STORY

BUILDING AREA: 2555 SF

BUILDING USE: COFFEE SHOP

ZONING: GNC (GENERAL COMMERCIAL)

TYPE OF USE: COFFEE SHOP

TYPE OF OCCUPANCY: A-2, ASSEMBLY

OCCUPANCY LOAD: BEVERAGE PREP: 489 SF / 200 = 03
BOOTH SEATING: 6 X (4' - 3" LF) / 24" = 13
CAFE/SEATING: 953 SF / 15 = 64
STANDING: 48 SF / 5 = 10
WORKROOM: 517 SF / 300 = 02
TOTAL OCCUPANCY: = 92

TOTAL SQUARE FOOTAGE: 2555 SF

TOTAL INTERIOR SEATS: 53

EXTERIOR SEASONAL SEATING: 16


EXTERIOR SEATING AREA: 360 SF

EXIT CAPACITY: EXIT 1: 72" WIDE
EXIT 2: 36" WIDE
EXIT 3: 42" WIDE
TOTAL EXIT WIDTH PROVIDED: 150 IN.
0.2 X 92 OCCUPANTS = 18.4 IN. REQUIRED

TRAVEL DISTANCE: ALLOWED TRAVEL DISTANCE: 200' - 0"
ACTUAL TRAVEL DISTANCE: 62' - 3"
62' - 3" < 200' - 0" THEREFORE COMPLIES

NUMBER OF EXITS: MIN. NUMBER OF EXITS REQUIRED: 2
NUMBER OF EXITS PROVIDED: 3

VICINITY PLAN

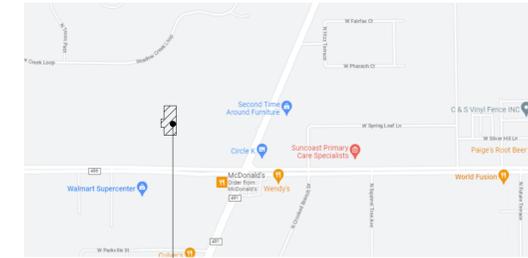

SITE



APPLICABLE CODES

7TH ED. 2020 FLORIDA BUILDING CODES

7TH EDITION 2020 FLORIDA BUILDING CODE: EXISTING BUILDINGS
7TH EDITION 2020 FLORIDA BUILDING CODE: PLUMBING
NFPA 70 - 2017 NATIONAL ELECTRIC CODE
7TH EDITION 2020 FLORIDA BUILDING CODE: ENERGY CONSERVATION
7TH EDITION 2020 FLORIDA BUILDING CODE: MECHANICAL
7TH EDITION 2020 FLORIDA BUILDING CODE: FUEL-GAS
7TH EDITION 2020 FLORIDA FIRE PREVENTION CODE

CODE CLASSIFICATION

A. OCCUPANCY GROUP: A-2, ASSEMBLY
B. CONSTRUCTION CLASSIFICATION TYPE: V-B. NON-SPRINKLERED
C. AUTOMATIC FIRE SUPPRESSION SYSTEM INSTALLED: NO
D. ZONING: GNC (GENERAL COMMERCIAL)
E. JURISDICTION/ COUNTY: CITRUS COUNTY

SCOPE OF WORK

INTERIOR TENANT IMPROVEMENT OF EXISTING SHELL BUILDING. SCOPE INCLUDES, BUT IS NOT LIMITED TO: PARTITIONS, EQUIPMENT, FINISHES, MECHANICAL, PLUMBING AND ELECTRICAL.

LANDLORD SHELL PERMIT NUMBER IS: BLD202217961

Reviewed for Code Compliance Building
Samuel C. Acosta

FOR CONSTRUCTION



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STARBUCKS TEMPLATE VERSION: I2022-11-17

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PROJECT NAME:
LECANTO HWY & NORVELL BRYANT

PROJECT ADDRESS:
**3159 W NORVELL BRYANT HWY
LECANTO, FL 34461**

STORE #: 78366
PROJECT #: 97107-001
ISSUE DATE: 09/06/2023
DESIGNER: RAI MONTERO
PRODUCTION DESIGNER: ANDY MCLOUD
CHECKED BY: DONALD RETHMAN

Revision Schedule

Rev	Date	By	Description

SHEET TITLE:
GENERAL INFORMATION

SCALE: NO SCALE

SHEET NUMBER:
G-001

BLD202323715

INDOOR SEATING			
TYPE	DESCRIPTION	NUMBER OF ITEMS	TOTAL SEATS
CAFE HEIGHT	TABLE TOP, ROUND	09	19
CAFE HEIGHT	TABLE TOP, SQUARE	02	04
CAFE HEIGHT	TABLE TOP, OBLONG, ADA	02	02
CAFE HEIGHT	COMMUNITY TABLE, ADA	01	08
SEAT	BANQUETTE SEATING	06	12
SEAT	SOFT SEATING	08	08

OUTDOOR SEATING			
TYPE	DESCRIPTION	NUMBER OF ITEMS	TOTAL SEATS
CAFE HEIGHT	TABLE TOP, RECTANGLE, ADA	02	04
CAFE HEIGHT	TABLE TOP, ROUND	04	08
SEAT	SOFT SEATING	04	04

EGRESS CALCULATION	
EXIT WIDTH REQUIRED - 92 OCC X 0.2	= 18.4 IN.
EXIT WIDTH PROVIDED	= 150 IN.
EXITS	= 72 IN. PRIMARY ENTRY, 36 IN. SECONDARY ENTRY, 42 IN. WORKROOM ENTRY
EXITS REQUIRED	= 02
EXITS PROVIDED	= 03
MAXIMUM ALLOWABLE TRAVEL DISTANCE	= 200 FT.
MAXIMUM TRAVEL DISTANCE PROVIDED	= 62 FT. 3 IN.
MINIMUM EXIT SEPARATION	= 60 FT. 6 IN. (MAXIMUM DIAGONAL) / 2 = 30 FT. 3 IN.
EXIT SEPARATION PROVIDED	= 54 FT. 0 IN.

PLUMBING FIXTURE CALCULATION					
CHAPTER 29-29023 (FOR REFERENCE ONLY)					
OCCUPANCY	MALE	FEMALE	TOTAL		
	54 OCC	54 OCC	108 OCC		
FIXTURES	WATERCLOSETS		URINALS	LAVATORIES	WATER FOUNTAIN
	ADD EQUATION PER AHJ		ADD EQUATION PER AHJ	ADD EQUATION PER AHJ	ADD EQUATION PER AHJ
	REQUIRED:	01 WC PER 75 M / 01 WC PER 75 F	00 U PER M	01 LAV PER 200 M / 01 LAV PER 200 F	NOT REQUIRED
	PROVIDED:	01 WC PER 54 M / 01 WC PER 54 F	00 U PER M	01 LAV PER 54 M / 01 LAV PER 54 F	NOT REQUIRED

OCCUPANCY	
BEVERAGE PREP: 489 SQ. FT. / 200 SQ. FT. / OCC	03 OCC
BOOTH SEATING: 6 X (4' - 3" LF / 24") / OCC	13 OCC
CAFE/SEATING: 953 SQ. FT. / 15 SQ. FT. / OCC	64 OCC
STANDING AREA: 48 SQ. FT. / 5 SQ. FT. / OCC	10 OCC
WORKROOM: 517 SQ. FT. / 300 SQ. FT. / OCC	02 OCC
TOTAL INTERIOR OCCUPANCY:	92 OCC
TOTAL EXTERIOR OCCUPANCY:	16 OCC
TOTAL OCC LOAD:	108 OCC

ROOM SCHEDULE

NAME	AREA (SF)
BEVERAGE PREP	489
BOOTH SEATING	48
CAFE/SEATING	953
RESTROOMS/UNOCCUPIABLE AREA	500
STANDING AREA	48
WORKROOM	517
GRAND TOTAL	2555

OCCUPANCY NOTES

OCCUPANCY CLASSIFICATION: A-2, ASSEMBLY
 TOTAL OCCUPANTS: 92

ACCESSIBLE SEATING

INTERIOR SEATING:
 53 SEATS X 5% = 03 ADA REQUIRED (03 PROVIDED)


EXTERIOR SEATING:
 16 SEATS X 5% = 01 ADA REQUIRED (02 PROVIDED)

KEYED NOTES

- THRESHOLDS TO BE BARRIER FREE COMPLIANT PER ALL APPLICABLE CODES.
- BARRIER-FREE PATH OF TRAVEL.
- 30" (760 MM) X 48" (1220 MM) CLEAR FOR WHEELCHAIR ACCESS.
- 60" (1525 MM) DIAMETER MINIMUM TURN RADIUS FOR WHEELCHAIR ACCESS.
- 32" (815 MM) MINIMUM CLEAR AT RESTROOM DOOR.
- SEE ENLARGED RESTROOM PLAN AND ELEVATIONS SHEET(S) FOR ADDITIONAL INFORMATION ON ACCESSIBLE RESTROOM CLEARANCES.
- POS TRANSACTION PLANE, CONDIMENT CART TOP AND HAND-OFF PLANE ARE 34 INCHES (860 MM) ABOVE THE FINISHED FLOOR FOR WHEELCHAIR ACCESSIBILITY.
- PROVIDE BARRIER-FREE SIGNAGE AT ADA RESTROOMS PER ALL APPLICABLE CODES.
- PROVIDE TACTILE "EXIT" SIGNAGE.
- PROVIDE INTERNATIONAL SYMBOL OF ACCESSIBILITY SIGN.

MEANS OF EGRESS NOTES

- EVERY ROOM OR SPACE THAT IS ASSEMBLY OCCUPANCY SHALL HAVE THE OCCUPANT LOAD OF THE ROOM OR SPACE POSTED IN A CONSPICUOUS PLACE, NEAR THE MAIN EXIT ACCESS DOORWAY. POSTED SIGNS SHALL BE OF AN APPROVED LEGIBLE PERMANENT DESIGN AND SHALL BE MAINTAINED BY THE OWNER AUTHORIZED AGENT.
- EGRESS SHALL NOT PASS THROUGH KITCHENS, STORAGE ROOMS, CLOSETS OR SIMILAR SPACES.
- PANIC AND FIRE EXIT HARDWARE, WHERE INSTALLED ON DOORS IN THIS BUILDING SHALL SATISFY THE FOLLOWING:
 - THE ACTUATION PORTION OF THE RELEASING DEVICE SHALL EXTEND AT LEAST ONE-HALF OF THE DOOR LEAF WIDTH.
 - THE MAXIMUM UNLATCHING FORCE DOES NOT EXCEED 15 POUNDS (6.8 KG).
 - PIVOTED OR BALANCED DOORS SHALL BE OF THE PUSH-PAD TYPE WHERE PANIC HARDWARE IS REQUIRED AND THE PAD SHALL NOT EXTEND ACROSS MORE THAN ONE-HALF OF THE DOOR WIDTH, MEASURED FROM THE LATCH SIDE.
 - PANIC HARDWARE LISTED IN ACCORDANCE WITH UL 305.
 - FIRE EXIT HARDWARE LISTED IN ACCORDANCE WITH UL 10C AND UL 305.
- STRUCTURAL ELEMENTS, FIXTURES OR FURNISHINGS SHALL NOT PROJECT HORIZONTALLY FROM EITHER SIDE MORE THAN 4 INCHES (100 MM) OVER ANY WALKING SURFACE BETWEEN 27 INCHES (685 MM) AND 80 INCHES (2030 MM) ABOVE THE WALKING SURFACE. EXCEPTION: HANDRAILS SERVING STAIRS AND RAMPS ARE PERMITTED TO PROTRUDE 4 1/2 INCHES (115 MM) FROM THE WALL. ES (1120 MM).
- THE PATH OF EGRESS TRAVEL EXITS AND WITHIN EXITS IN THIS BUILDING SHALL BE IDENTIFIED BY EXIT SIGNS CONFORMING TO THE REQUIREMENTS OF SECTION 1011 AND AS NOTED BELOW:
 - EXIT SIGNS SHALL BE READILY VISIBLE FROM ANY DIRECTION OF EGRESS TRAVEL.
 - EXIT SIGNS SHALL BE LOCATED AS NECESSARY TO CLEARLY INDICATE THE DIRECTION OF EGRESS TRAVEL.
 - NO POINT IN A CORRIDOR SHALL BE MORE THAN 100 FT (30.5 M) OR THE LISTED VIEWING DISTANCE FOR THE SIGN, WHICHEVER IS LESS, FROM THE NEAREST VISIBLE EXIT SIGN.
- WHERE KEY OPERATED LOCKING DEVICES ARE USED, POST A SIGN ON OR ADJACENT TO THE REQUIRED MAIN EXIT DOOR WITH 1 INCH (25 MM) LETTERING STATING THAT "THIS DOOR TO REMAIN UNLOCKED WHEN BUILDING IS OCCUPIED".
- EGRESS DOORS OR GATES SHALL BE OPENABLE FROM THE EGRESS SIDE WITHOUT THE USE OF A KEY, SPECIAL KNOWLEDGE OR EFFORT. DOOR HANDLES, PULLS, LATCHES, LOCKS AND OTHER OPERATING DEVICES SHALL BE INSTALLED 34 INCHES (860 MM) TO 48 INCHES (1220 MM) ABOVE FINISHED FLOOR. MANUALLY OPERATED FLUSH BOLTS OR SURFACE BOLTS ARE NOT PERMITTED. THE UNLATCHING OF ANY DOOR OR LEAF SHALL NOT REQUIRE MORE THAN ONE OPERATION.
- LANDINGS SHALL BE PROVIDED ON EACH SIDE OF DOORS AND SUCH LANDING SHALL BE AT THE SAME ELEVATION ON EACH SIDE OF THE DOOR. LANDINGS SHALL HAVE A WIDTH NOT LESS THAN THE WIDTH OF THE DOOR AND LENGTH MEASURED IN THE DIRECTION OF TRAVEL OF NOT LESS THAN 44 INCHES (1120 MM).

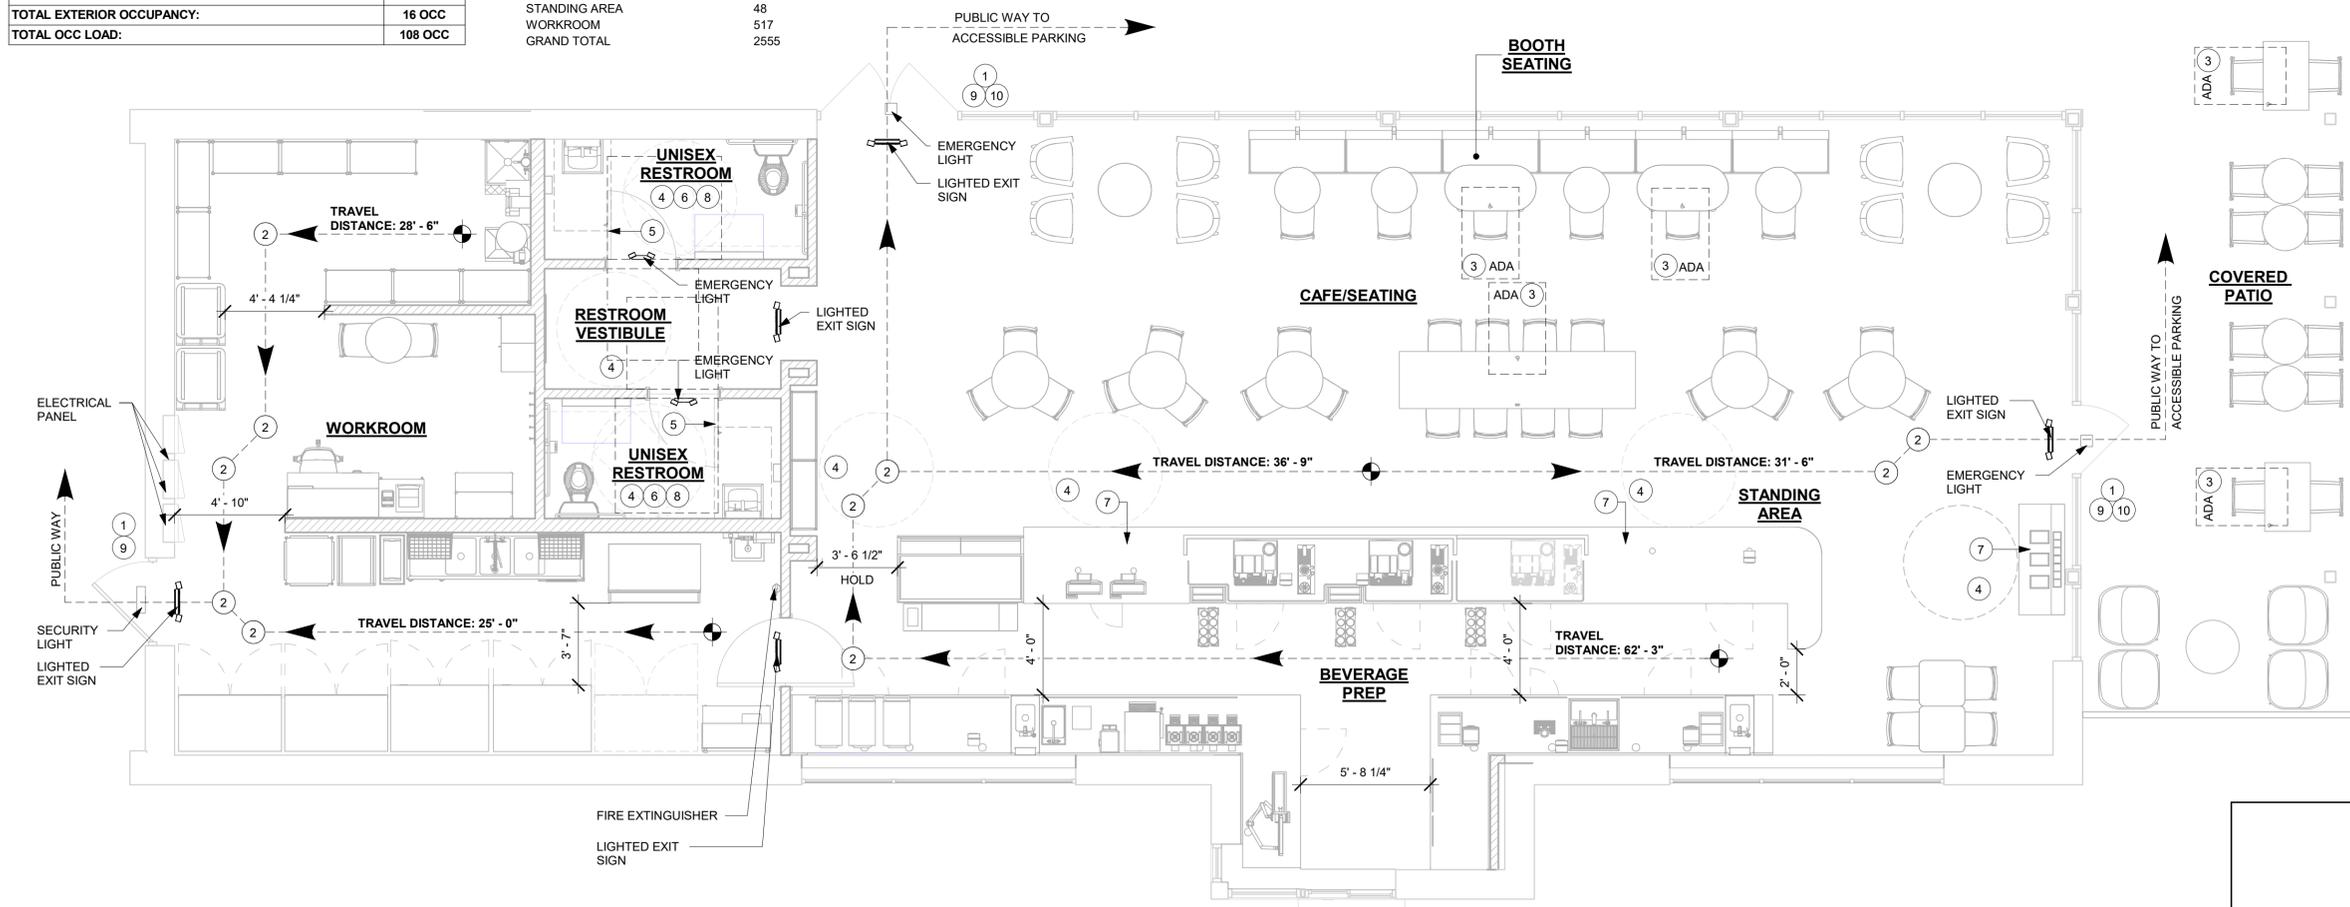

1 LIFE SAFETY ACCESSIBILITY PLAN
 Scale: 1/4" = 1'-0"



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FOR CONSTRUCTION

PROJECT NAME:
LECANTO HWY & NORVELL BRYANT

PROJECT ADDRESS:
**3159 W NORVELL BRYANT HWY
 LECANTO, FL 34461**

STORE #: 78366
 PROJECT #: 97107-001
 ISSUE DATE: 09/06/2023
 DESIGNER: RAI MONTERO
 PRODUCTION DESIGNER: ANDY MCLLOUD
 CHECKED BY: DONALD RETHMAN

Revision Schedule			
Rev	Date	By	Description

SHEET TITLE:
LIFE SAFETY ACCESSIBILITY PLAN
 SCALE: 1/4" = 1'-0"

SHEET NUMBER:
G-002


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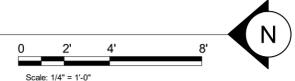
AREA COLOR LEGEND

- BOOTH SEATING
- STANDING AREA
- CAFE/SEATING
- BEVERAGE PREP.
- WORKROOM
- EGRESS / UNOCCUPIABLE

AREA - OCCUPANT LOAD CALCS			
NAME	Area (SF)	LOAD FACTOR	OCCUPANT LOAD
BEVERAGE PREP	489	200	3
BOOTH SEATING	6 X (4' - 3" LF)	1/24"	13
CAFE/SEATING	953	15	64
EGRESS - UNOCCUPIABLE	500	0	0
STANDING AREA	48	5	10
WORKROOM	517	300	2
GRAND TOTAL	2555		92



1 OCCUPANCY LOAD PLAN
Scale: 1/4" = 1'-0"

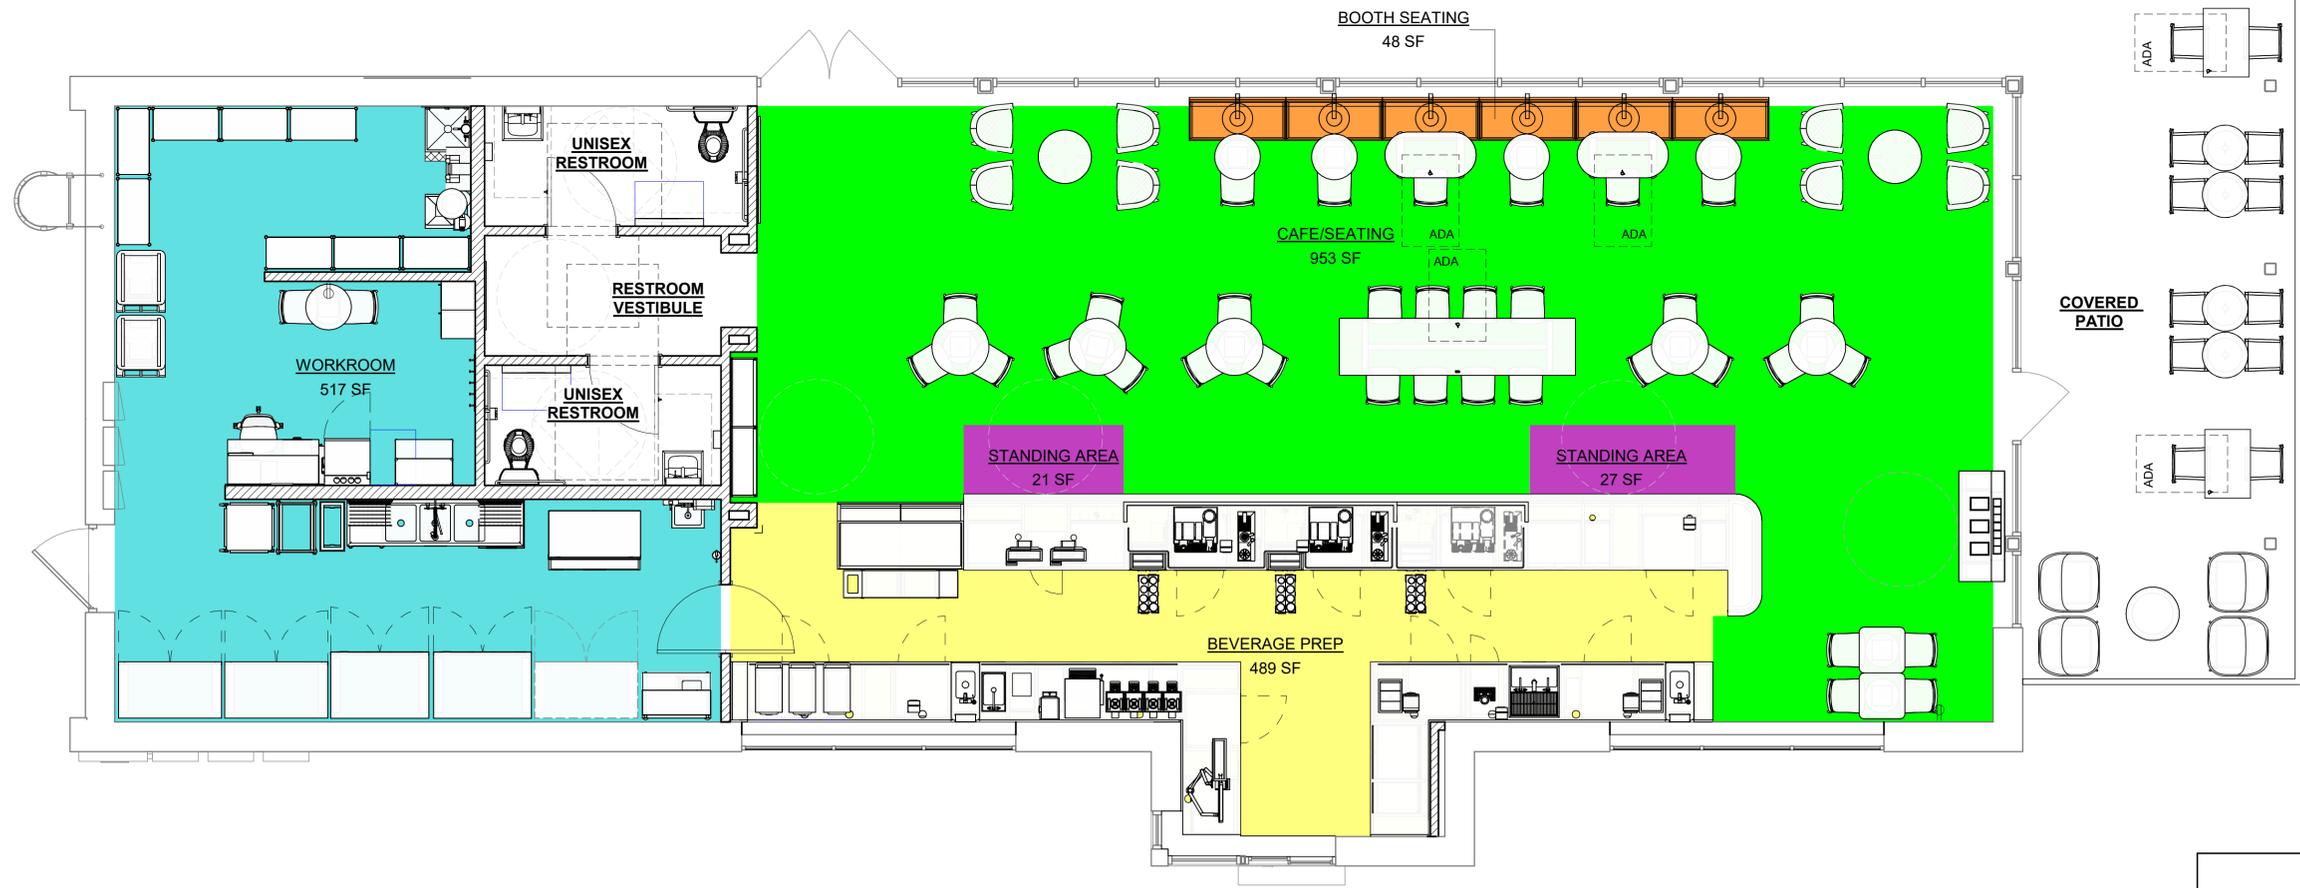

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FOR CONSTRUCTION

PROJECT NAME:
LECANTO HWY & NORVELL BRYANT

PROJECT ADDRESS:
**3159 W NORVELL BRYANT HWY
LECANTO, FL 34461**

STORE #: 78366
PROJECT #: 97107-001
ISSUE DATE: 09/06/2023
DESIGNER: RAI MONTERO
PRODUCTION DESIGNER: ANDY MCLOUD
CHECKED BY: DONALD RETHMAN

Revision Schedule			
Rev	Date	By	Description


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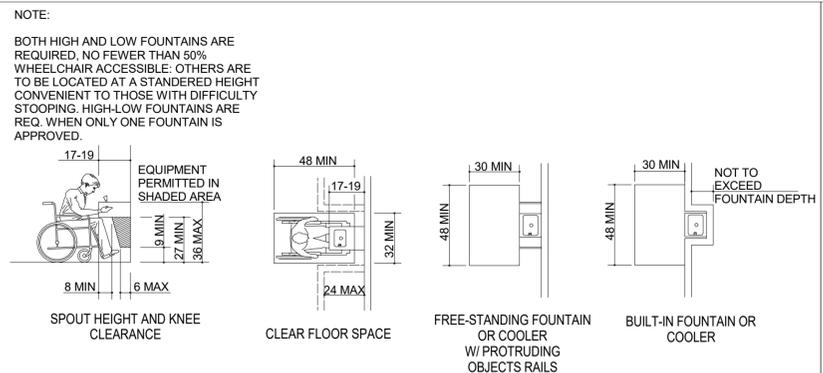
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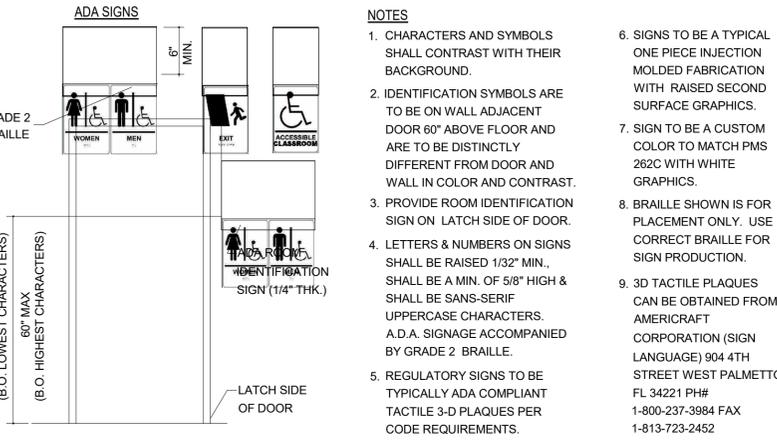
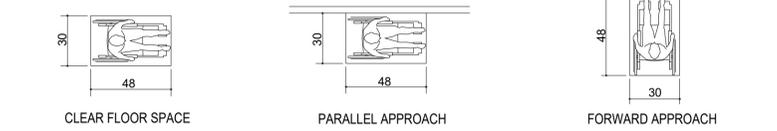
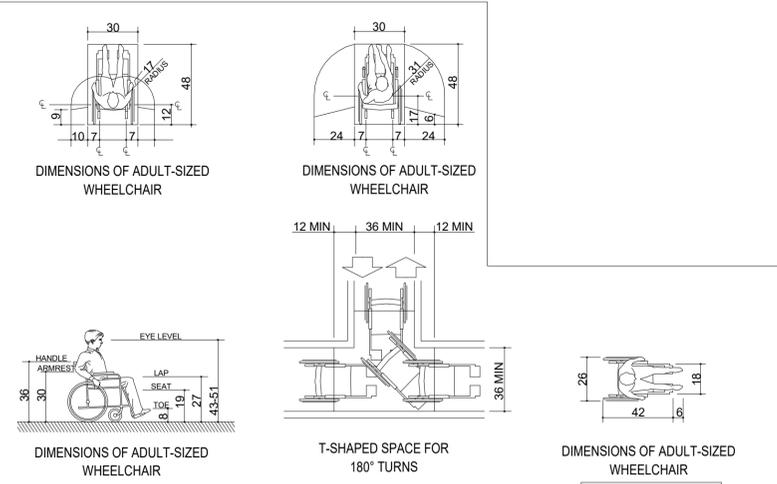
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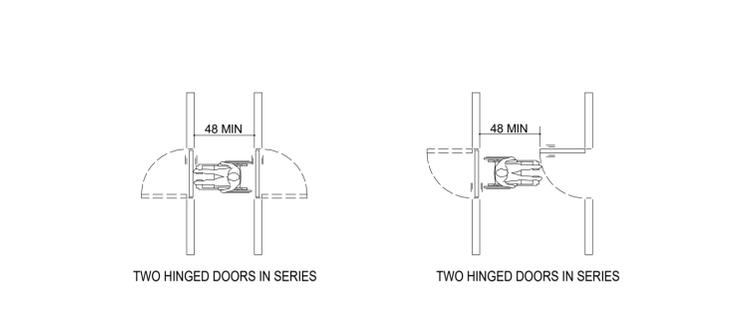
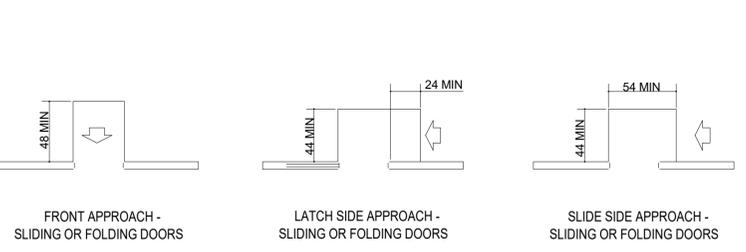
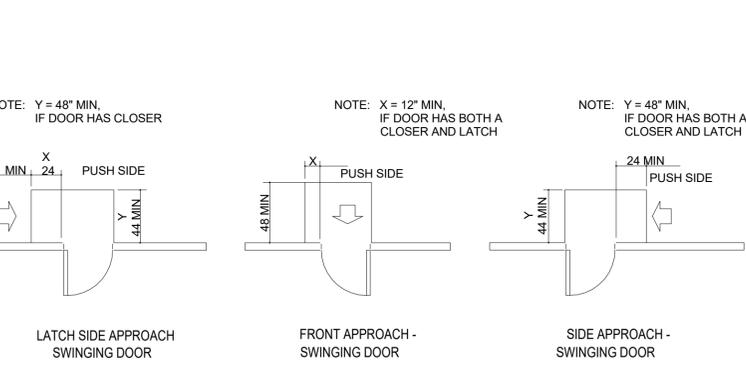
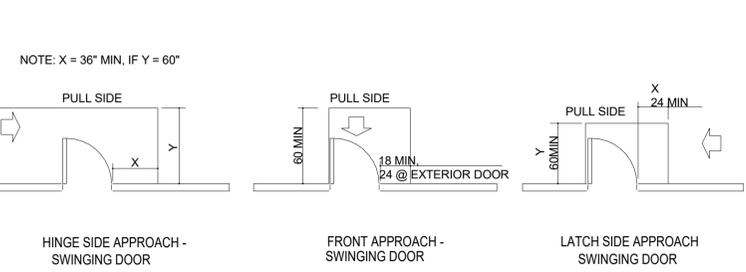
CANE TECHNIQUE



SECTION 4.15 DRINKING FOUNTAINS




SECTION 4.3 ACCESSIBLE ROUTE


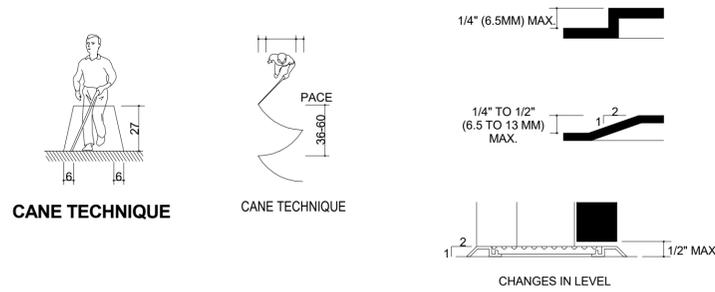


SECTION 4.13 DOORS

SECTION 4.18 URINALS



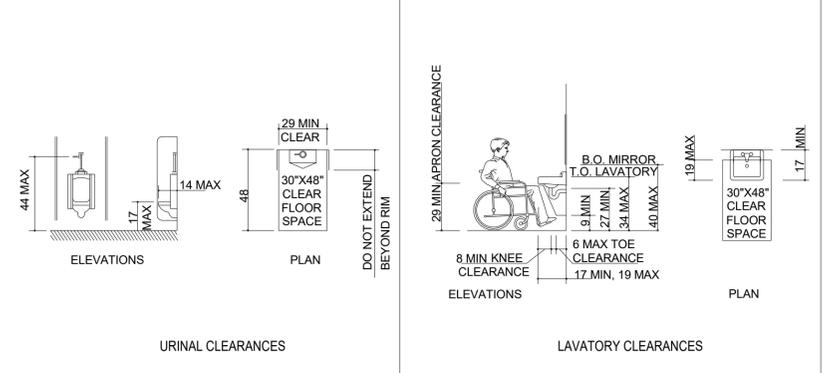


SECTION 4.19 LAVATORIES & MIRRORS

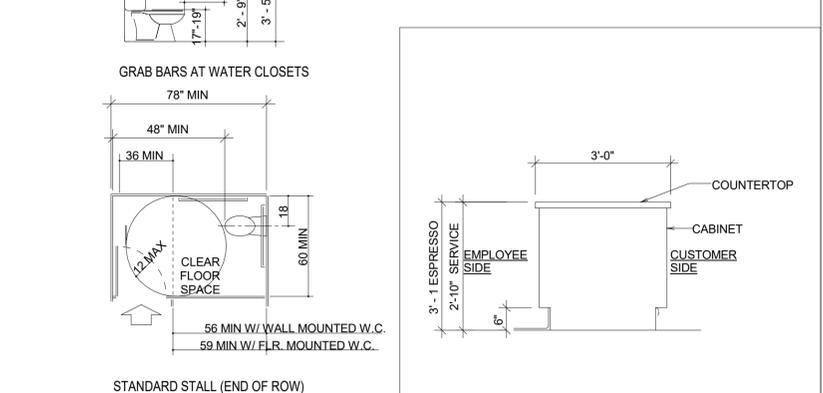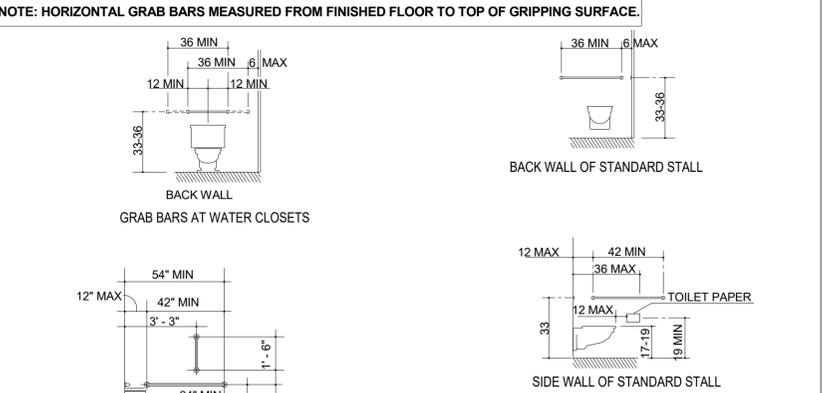

SECTION 4.17 TOILET STALLS

TYP SECTION @ COUNTER

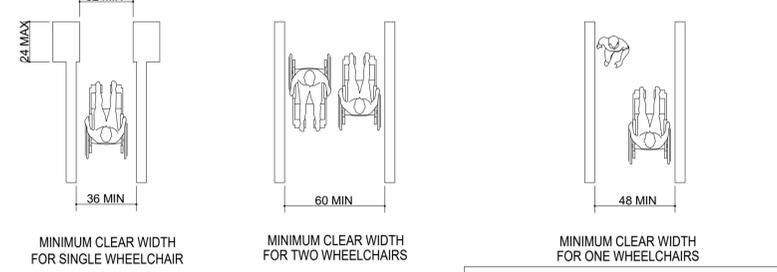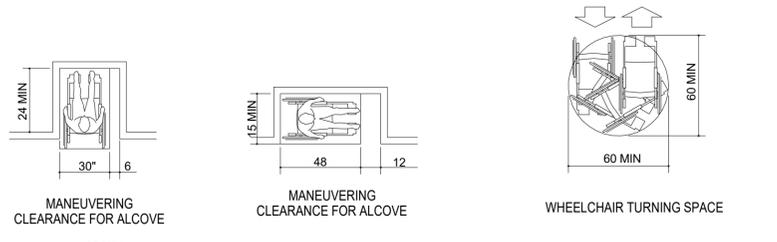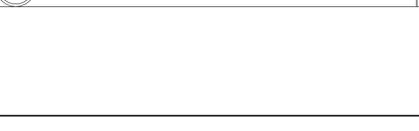

SECTION 4.2 SPACE ALLOWANCES



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STORE #: 78366
PROJECT #: 97107-001
ISSUE DATE: 09/06/2023
DESIGNER: RAI MONTERO
PRODUCTION DESIGNER: ANDY MCLLOUD
CHECKED BY: DONALD RETHMAN

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ACCESSIBILITY GUIDELINES
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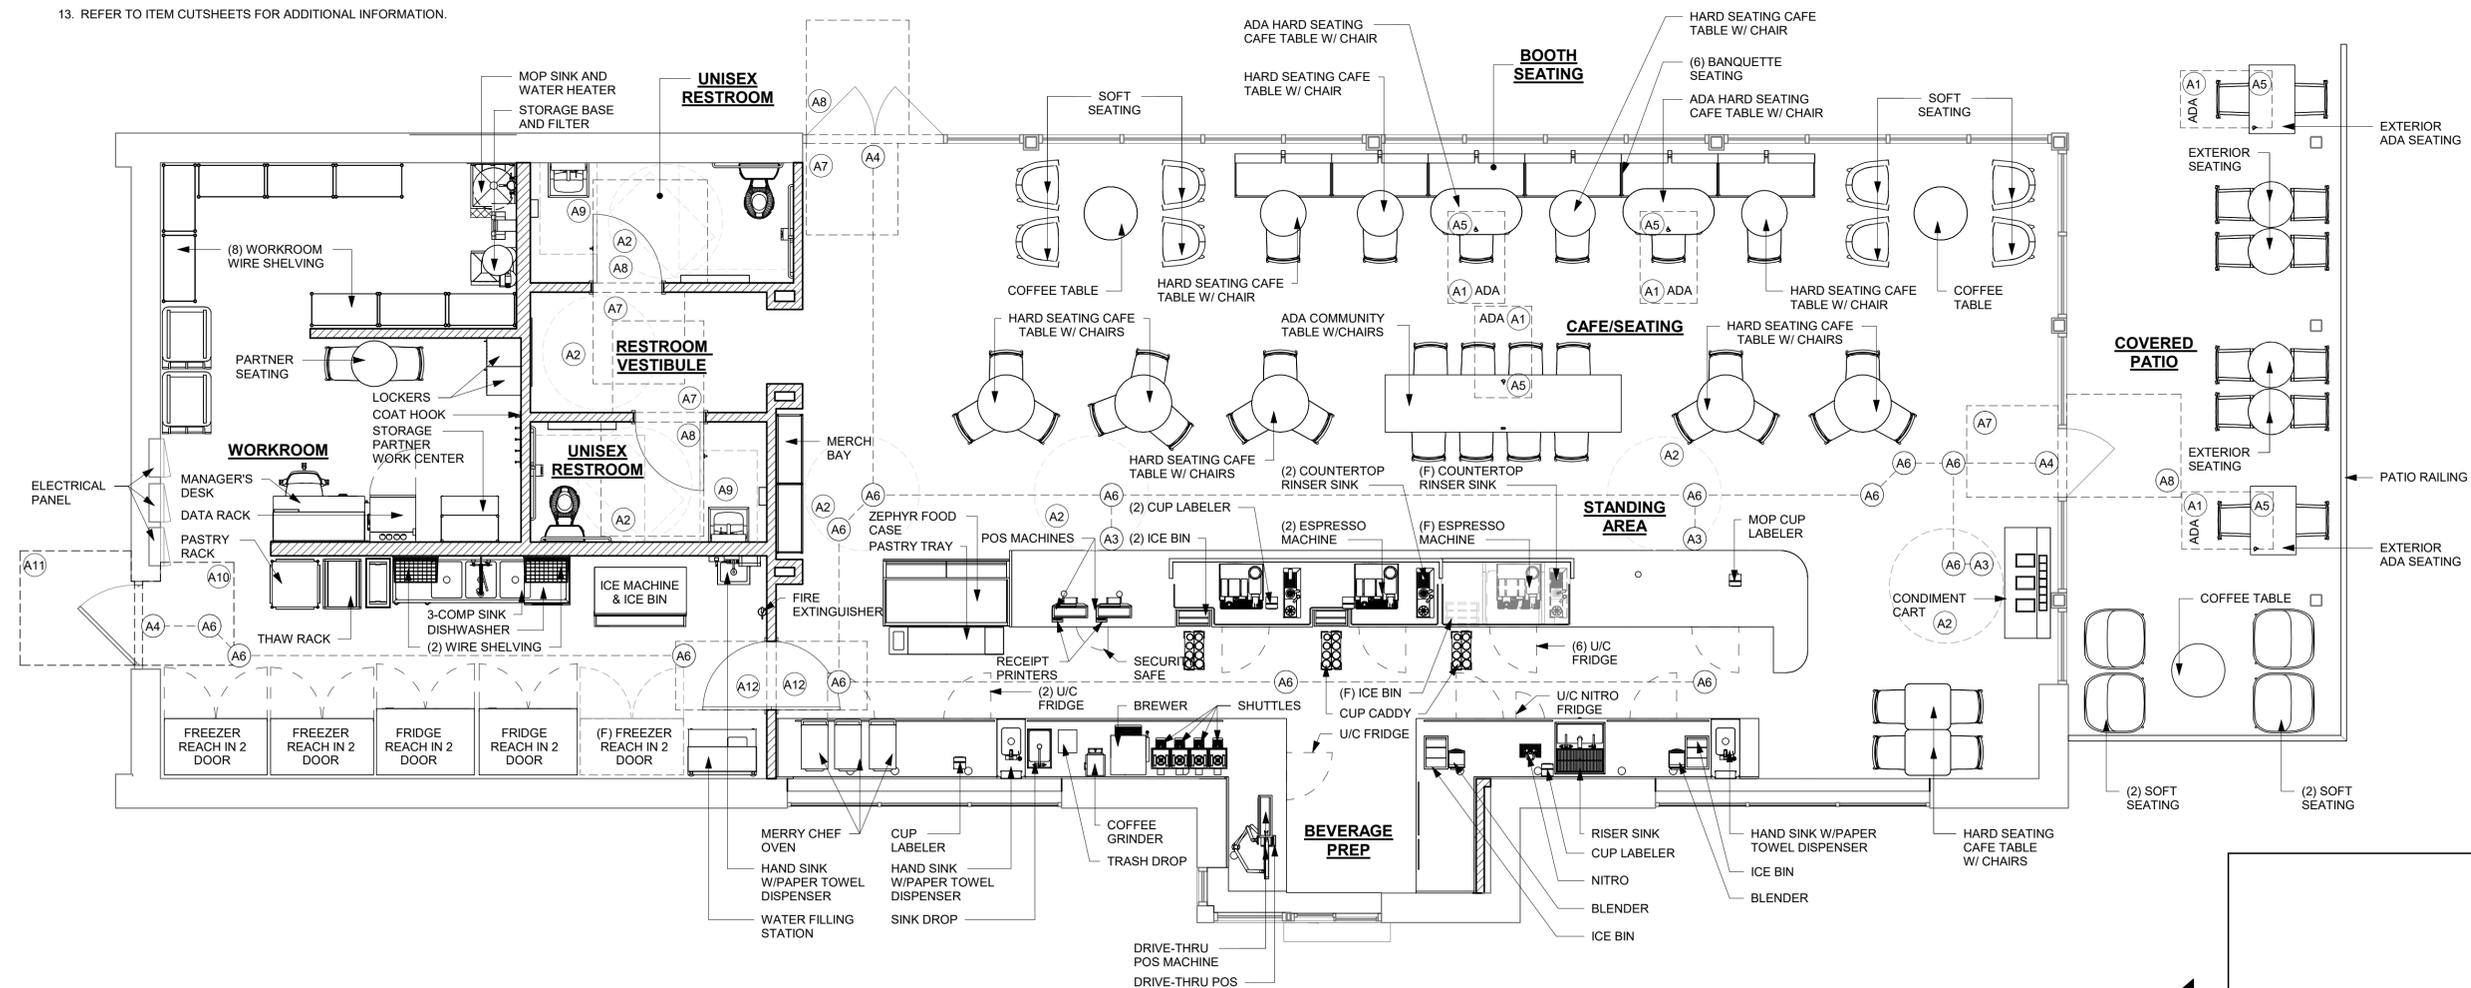
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GENERAL NOTES

- GENERAL CONTRACTOR SHALL VISIT THE SITE, REVIEW THE BUILDING SHELL DRAWINGS AS SUBMITTED BY THE LANDLORD OR STARBUCKS SITE SURVEYOR AND BECOME THOROUGHLY FAMILIAR WITH THE SITE CONDITIONS PRIOR TO BIDDING OR CONSTRUCTION.
- GENERAL CONTRACTOR SHALL CONSULT WITH STARBUCKS CONSTRUCTION MANAGER TO RESOLVE ANY CHANGES, OMISSIONS OR PLAN DISCREPANCIES PRIOR TO BIDDING OR CONSTRUCTION.
- ALL WORK SHALL BE PERFORMED IN STRICT COMPLIANCE WITH LOCAL, COUNTY, STATE AND FEDERAL CODES AND ORDINANCES.
- GENERAL CONTRACTOR SHALL VERIFY THE LOCATION OF ALL UTILITIES.
- GENERAL CONTRACTOR TO VERIFY ALL DIMENSIONS, INCLUDING CLEARANCES REQUIRED BY OTHER TRADES AND NOTIFY STARBUCKS CONSTRUCTION MANAGER OF ANY DISCREPANCIES PRIOR TO PROCEEDING WITH THE WORK. ALL DIMENSIONS ARE TO THE FACE OF THE FINISHED SURFACE UNLESS OTHERWISE NOTED. ALL DIMENSIONS TO BE TAKEN FROM DESIGNATED DATUM POINT. DO NOT SCALE DRAWINGS.
- GENERAL CONTRACTOR SHALL PATCH AND REPAIR ALL EXISTING WALLS, FLOORS, CEILINGS OR OTHER SURFACES IDENTIFIED TO REMAIN THAT MAY BECOME DAMAGED DURING THE COURSE OF THE WORK.
- THE GENERAL CONTRACTOR IS RESPONSIBLE FOR OBTAINING PERMITS FOR FIRE PROTECTION, PLUMBING, MECHANICAL AND ELECTRICAL SYSTEMS PRIOR TO INSTALLATION OF SUCH SYSTEMS.
- GENERAL CONTRACTOR SHALL RETAIN ONE SET OF THE PLANS TO NOTE AND DOCUMENT ALL CHANGES DURING CONSTRUCTION. THIS SET SHALL BE A PART OF THE GENERAL CONTRACTOR'S 'STORE CLOSE-OUT PACKAGE' AS DESCRIBED IN THE CONSTRUCTION MANAGEMENT AGREEMENT.
- GENERAL CONTRACTOR IS RESPONSIBLE FOR COORDINATING DELIVERY OF MATERIALS FROM STARBUCKS CONTRACTED THIRD PARTY LOGISTICS DISTRIBUTION SERVICES AND VENDOR DIRECT SHIPMENTS. REFER TO CONSTRUCTION MANAGEMENT AGREEMENT FOR METHODS AND LEAD TIMES.
- RESPONSIBILITY FOR SUPPLY AND DELIVERY OF MATERIALS AND EQUIPMENT IS IDENTIFIED IN THE DRAWING SCHEDULE SHEETS UNDER THE COLUMN LABELED "RESPONSIBILITY".
- FOR THE PURPOSE OF THE DOCUMENTS, TO "INSTALL", SHALL MEAN TO PROVIDE ALL FASTENERS, MISCELLANEOUS HARDWARE, BLOCKING, ELECTRICAL CONNECTIONS, PLUMBING CONNECTIONS, AND OTHER ITEMS REQUIRED FOR A COMPLETE AND OPERATION INSTALLATION, UNLESS OTHERWISE NOTED.
- ALL ITEM SUBSTITUTIONS MUST BE APPROVED BY THE STARBUCKS DESIGN MANAGER.
- REFER TO ITEM CUTSHEETS FOR ADDITIONAL INFORMATION.

SHEET NOTES

- 30" X 48" CLEAR FOR WHEELCHAIR ACCESS.
- 60" DIAMETER CLEAR FOR WHEELCHAIR ACCESS.
- POS, HAND-OFF PLANE AND CONDIMENT CART COUNTERTOP ARE 2'-10" (MAX.) AFF FOR WHEELCHAIR ACCESSIBILITY.
- ALL THRESHOLDS TO BE ADA COMPLIANT PER ALL APPLICABLE CODES.
- ADA TABLE TOPS SHALL BE 28" MINIMUM AND 34" MAXIMUM IN HEIGHT ABOVE THE FLOOR. KNEE CLEARANCE SHALL BE A MINIMUM OF 27" IN HEIGHT ABOVE THE FLOOR AND 30" MINIMUM IN WIDTH.
- BARRIER FREE PATH OF TRAVEL.
- ADA MANEUVERING CLEARANCE AT DOORS; FRONT APPROACH, PUSH SIDE, DOOR PROVIDED WITH CLOSER: 48" MIN. BY 48" MIN.
- ADA MANEUVERING CLEARANCE AT DOORS; FRONT APPROACH, PULL SIDE, DOOR PROVIDED WITH CLOSER: 54" MIN. BY 60" MIN.
- HAND SINKS AND LAVATORIES TO BE 2'-10" AFF AND 30" X 48" CLEAR FOR WHEELCHAIR ACCESSIBILITY.
- ADA MANEUVERING CLEARANCE AT DOORS; FRONT APPROACH, PUSH SIDE, DOOR PROVIDED WITH CLOSER: 48" MIN. BY 54" MIN.
- ADA MANEUVERING CLEARANCE AT DOORS; FRONT APPROACH, PULL SIDE, DOOR PROVIDED WITH CLOSER: 60" MIN. BY 60" MIN.
- ADA MANEUVERING CLEARANCE AT DOORS; FRONT APPROACH, PULL SIDE, DOOR PROVIDED WITH CLOSER: 36" MIN BY 48" MIN.



1 FOOD SERVICE PLAN
Scale: 1/4" = 1'-0"



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DESIGNER: RAI MONTERO
PRODUCTION DESIGNER: ANDY MCLOUD
CHECKED BY: DONALD RETHMAN

Revision Schedule			
Rev	Date	By	Description

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FOOD SERVICE PLAN

SCALE: 1/4" = 1'-0"

SHEET NUMBER:
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GC REQUIREMENTS FOR STARBUCKS GREENER STORES

☑ PRE-CHECKED ITEMS ARE LEED PREREQUISITES FOR NEW AND RELOCATED COMPANY OWNED STORES. PLEASE REFER TO THE LEED SCORECARD TO VERIFY TARGETED CREDITS.

BEFORE CONSTRUCTION

- TALK TO WASTE HAULER TO MAKE SURE THEY CAN RECYCLE AT LEAST 50% OF YOUR CONSTRUCTION WASTE.
 - YOU WILL NEED TO SUBMIT DUMP TICKETS AND DIVERSION RATES SHOWING AT LEAST 50% WAS RECYCLED.
- CONFIRM CO-MINGLED RECYCLER CAN PROVIDE A DIVERSION RATE BASED ON WEIGHT OF INDIVIDUAL RECYCLABLES (WOOD, METAL, ADC, CONCRETE ETC.). DIVERSION RATE CAN BE BY CONTAINER OR A FACILITY WIDE AVERAGE (MONTHLY OR ANNUAL). VISUAL CLASSIFICATION IS NOT ACCEPTABLE.
- SOURCE-SEPARATED RECYCLABLES DO NOT NEED A PUBLISHED DIVERSION RATE AND CAN BE ASSUMED TO BE 100%.
- REVIEW IAQ MANAGEMENT PLAN WITH PROJECT TEAM (FOUND IN THE GC ADMINISTRATION HANDBOOK).
- REVIEW PRE-APPROVED PRODUCT LIST WITH PROJECT TEAM (FOUND IN THE GC ADMINISTRATION HANDBOOK).
- ENSURE THAT THE ENTIRE CONSTRUCTION TEAM, INCLUDING SUB-CONTRACTORS, ARE AWARE OF THEIR LEED ROLES AND RESPONSIBILITIES.

DURING CONSTRUCTION

- INSTALL LOW-FLOW TOILETS AND AERATORS (1.28 GPF OR BETTER, 0.5 GPM AERATORS, 1.2 GPM PRE-RINSE SPRAY VALVE).
- KEEP TRACK OF DUMP TICKETS.
- KEEP TRACK OF ADHESIVES, SEALANTS, PAINTS AND OTHER EQc4 PRODUCTS USED.
- POST IAQ MANAGEMENT PLAN ON THE JOB SITE.
- POST PRE-APPROVED PRODUCT LIST.
- COMPLETE 2 SITE INSPECTION CHECKLISTS TO VERIFY BEST PRACTICES USED FOR MAINTAINING GOOD INDOOR AIR QUALITY DURING CONSTRUCTION. PHOTOS CAN HELP DOCUMENT THESE:
 - CLEAN WORK SITE AT BEGINNING OR END OF EACH DAY TO CONTROL DUST.
 - MAKE SURE DUCT WORK IS DELIVERED WITH ENDS COVERED.
 - PROTECT DUCTWORK BY SEALING OPENINGS IMMEDIATELY AFTER INSTALLATION.
 - IF THE USE OF THE PERMANENT HVAC EQUIPMENT IS UNAVOIDABLE DURING CONSTRUCTION, INSTALL A TEMPORARY MERV 8 FILTER ON ALL SUPPLY AND RETURN GRILLES AND OPENINGS. TO BE REPLACED WITH NEW MERV 8 FILTERS BEFORE TAB WORK AND FINAL SYSTEM COMMISSIONING.
 - USE WALK-OFF MATS AT ENTRIES FOR DUST CONTROL.
 - USE FAN OR OTHER METHOD OF CLEARING DUST FROM AIR DURING CONSTRUCTION.
 - KEEP DELIVERED BUT NOT-YET-INSTALLED EQUIPMENT/MATERIALS COVERED IN PLASTIC AND RAISED OFF OF THE GROUND TO PREVENT MOISTURE DAMAGE.
 - DO NOT INSTALL CONTAMINATED MATERIALS.
 - POST NO SMOKING SIGN.
 - USE LOW VOC PRODUCTS, AS PER PRE-APPROVED LIST, OR VERIFIED VIA MSD SHEETS.
 - USE ELECTRIC TOOLS WITH VACUUM-ASSIST, NOT GAS-POWERED TOOLS.
 - CUT AND FABRICATE MATERIALS OUTSIDE WHENEVER POSSIBLE.

AT END OF CONSTRUCTION

- SUBMIT:**
- TAB REPORT, WITH ACTUAL OUTSIDE AIR VOLUMES INDICATED AND BALANCED AS PER DESIGN CFM ON DRAWINGS.
 - TWO IAQ SITE INSPECTION CHECKLISTS.
 - SIGNED EQc4 AFFIDAVIT -OR- FILL OUT EQc4 REPORT IF USED NON-PREAPPROVED PRODUCTS FOR LOW-EMITTING MATERIALS: PAINTS, COATINGS, ADHESIVES, SEALANTS, CEILINGS, WALLS AND COMPOSITE WOOD PRODUCTS.
 - CONSTRUCTION WASTE MANAGEMENT REPORT.
 - PROOF OF CONSTRUCTION WASTE DIVERSION RATE VIA DUMP TICKETS, SUMMARY REPORT OR RECYCLING FACILITY DIVERSION RATE.
- VERIFY:**
- ENSURE LOW-FLOW FIXTURES ARE INSTALLED:
 - TOILETS: 1.28 GPF OR BETTER
 - HAND SINKS: 0.5 GPM AERATORS
 - PRE-RINSE SPRAY VALVE: 1.2 GPM
 - BICYCLE RACK IS INSTALLED
 - ENSURE A COMBINATION OF OVERHANGS AND/OR BLINDS ARE INSTALLED FOR ALL WINDOWS TO MITIGATE SOLAR HEAT GAIN AND GLARE.

CONTRACTOR RESPONSIBILITIES FOR BUILDING COMMISSIONING

CONTRACTOR SHALL PROVIDE SUPPORT AND WORKS AS SPECIFIED, NEEDED AND REQUIRED TO CONDUCT AND FACILITATE STARBUCKS STAFF BUILDING COMMISSIONING EFFORTS. THIS WORK WILL BE COMPRISED OF THREE DISTINCT EFFORTS:

1. SUPPORT STARBUCKS COMMISSIONING AGENT (CXA) DURING INSTALLATION VERIFICATION AND CORRECT DISCLOSED DEFICIENCIES;
2. PERFORM TESTING, ADJUSTING, BALANCING AND SYSTEM STARTUP AND SUPPORT FUNCTIONAL PERFORMANCE TESTING BY STARBUCKS CXA. 3) CORRECT DEFICIENCIES DISCLOSED BY FUNCTIONAL PERFORMANCE TESTING AND SUBMIT REPORTS. CONTRACTOR SHALL PERFORM AND PROVIDE THE FOLLOWING:
 - A. SYSTEMS SUBJECT TO COMMISSIONING MAY INCLUDE, BUT ARE NOT LIMITED TO, DOMESTIC HOT WATER GENERATION, HVAC SYSTEMS, ROOFTOP UNITS, EXHAUST FANS, HVAC CONTROLS, LIGHTING CONTROLS, AIR CURTAINS, BUILT-IN REFRIGERATION EQUIPMENT AND RENEWABLE ENERGY SYSTEMS.
 - B. CONTRACTOR SHALL INCLUDE COMMISSIONING ACTIVITIES IN PROJECT SCHEDULE AND SHOW INTERVALS FOR PERFORMANCE OF WORK FOR WHICH CONTRACTOR IS RESPONSIBLE AND INTERVALS FOR WORK PERFORMED BY STARBUCKS CXA. CONTRACTOR SHALL SHOW RESOURCES FOR PERFORMING ALL WORK RELATED TO COMMISSIONING ACTIVITIES ON A LINE ITEM IN THE SCHEDULE OF VALUES.
 - C. CONTRACTOR SHALL INSTALL EQUIPMENT IN ACCORDANCE WITH THE MANUFACTURER'S REQUIREMENTS AND ALL CONTRACT DOCUMENTS. ENSURE THAT ALL EQUIPMENT IS INSTALLED TOTALLY COMPLETE AND ACCESSIBLE TO STARBUCKS CXA FOR INSTALLATION VERIFICATION AND FUNCTIONAL PERFORMANCE TESTING PRIOR TO THE SCHEDULED START OF INSTALLATION VERIFICATIONS.
 - D. INSTALLATION VERIFICATION SHALL BE PERFORMED BY STARBUCKS' CXA. CONTRACTOR SHALL SUPPORT STARBUCKS CXA INSTALLATION VERIFICATION EFFORTS AS NECESSARY. PROVIDE ALL ACCESS AND EQUIPMENT NECESSARY FOR STARBUCKS STAFF TO VERIFY THAT THE EQUIPMENT IS INSTALLED CORRECTLY.
 - E. CONTRACTOR SHALL BE READILY AVAILABLE DURING INSTALLATION VERIFICATION TO CORRECT ANY DEFICIENCIES OR DEFECTS DISCLOSED BY THE INSTALLATION VERIFICATION PROCESS. CORRECTIONS SHALL BE MADE IN A TIMELY MANNER WITHOUT DISRUPTION OF THE CONSTRUCTION SCHEDULE.
 - F. ALL HVAC, EXHAUST FAN AND AIR CURTAIN EQUIPMENT SHALL BE TESTED, ADJUSTED AND BALANCED BY THE CONTRACTORS TESTING, ADJUSTING AND BALANCE AGENT (SEE TESTING, ADJUSTING AND BALANCING) AFTER THE SYSTEM IS VERIFIED TO BE COMPLETE AND CORRECT BY STARBUCKS CXA, IN ACCORDANCE WITH THE REQUIREMENTS OF THESE DOCUMENTS. ALL HVAC CONTROL SYSTEMS SHALL BE TESTED TO ENSURE THAT CONTROL DEVICES, COMPONENTS, EQUIPMENT AND SYSTEMS ARE CALIBRATED, ADJUSTED AND OPERATE IN ACCORDANCE WITH THESE PLANS AND SPECIFICATIONS. SEQUENCES OF OPERATION CALIBRATED, ADJUSTED AND OPERATE IN ACCORDANCE WITH THESE PLANS AND SPECIFICATIONS. SEQUENCES OF OPERATION SHALL BE TESTED TO ENSURE THAT THEY OPERATE IN ACCORDANCE WITH THE CONTRACT REQUIREMENTS. DELIVERABLES: PRELIMINARY, WRITTEN TESTING AND AIR BALANCE REPORT CONFORMING TO THE REQUIREMENTS SPECIFIED HEREIN. DOCUMENTING THE INFORMATION SPECIFIED, ETC. TO THE STARBUCKS CXA IMMEDIATELY UPON COMPLETION OF THE WORK.
 - G. CONTRACTOR SHALL INFORM STARBUCKS CXA WHEN EQUIPMENT IS READY FOR FUNCTIONAL PERFORMANCE TESTING. ALL EQUIPMENT SHALL BE READY FOR FUNCTIONAL PERFORMANCE TESTING PRIOR TO STARTING TESTING. CONTRACTOR SHALL OPERATE EQUIPMENT FOR STARBUCKS CXA AND VERIFY BY DEMONSTRATION THE CORRECT OPERATION OF EQUIPMENT, RESPONSE OF SENSORS AND PROPER EXECUTION OF HVAC CONTROL AND LIGHTING SEQUENCES, INCLUDING BUT NOT LIMITED TO AIR MOVEMENT, TEMPERATURE, SOUND AND CONTROL RESPONSE. PROVIDE ANY SECURITY ACCESS, HARDWARE, SOFTWARE OR OTHER SUPPORT AS NEEDED FOR THE STARBUCKS CXA TO EFFICIENTLY WITNESS AND DOCUMENT ALL EQUIPMENT TESTING. STARBUCKS CXA WILL RECORD TED EQUIPMENT OPERATION AND RESPONSE TO TESTING SEQUENCES AND PREPARE A LIST OF ANY DEFICIENCIES DISCLOSED BY THE FUNCTIONAL PERFORMANCE TESTS FOR CORRECTION BY THE CONTRACTOR. EQUIPMENT INCLUDES BUT IS NOT LIMITED TO, AIR HANDLING UNITS, ROOFTOP AND SPLIT TYPE, CONDENSING UNITS, EXHAUST FANS, LIGHTING CONTROLS, ETC. DELIVERABLES: PROVIDE COMPLETED COPIES OF ALL START UP REPORTS, FILLED OUT ON THE MANUFACTURERS FORMS, TO THE STARBUCKS CXA.
 - H. CONTRACTOR IS RESPONSIBLE FOR CORRECTING ANY ISSUES OR DEFICIENCIES DISCLOSED DURING THE FUNCTIONAL PERFORMANCE TESTING PROCESS. CORRECTIONS SHOULD BE MADE IN A TIMELY MANNER WITHOUT DISRUPTION TO THE SYSTEM AND CONSTRUCTION SCHEDULE.
 - I. CONTRACTOR SHALL BE READILY BE AVAILABLE FOR ANY RE-TESTING OF EQUIPMENT DEEMED NECESSARY BY STARBUCKS CXA DURING INSTALLATION VERIFICATION AND FUNCTIONAL PERFORMANCE TESTING. CONTRACTOR IS RESPONSIBLE FOR CORRECTING ANY ISSUES OR DEFICIENCIES FOUND IN THE SYSTEM DURING ANY AND ALL RETESTING. CORRECTIONS SHOULD E MADE IN A TIMELY MANNER WITHOUT DISRUPTION TO THE SYSTEM AND CONSTRUCTION SCHEDULE. DELIVERABLES: FINAL BALANCE REPORT, DEFICIENCIES LIST NOTING CORRECTIVE ACTIONS PERFORMED BY CONTRACTOR IN RESPONSE TO INSTALLATION VERIFICATION AND FUNCTIONAL PERFORMANCE TEST RESULTS.
 - J. CONSTRUCTION AND POST CONSTRUCTION TESTING: ADDITIONAL TESTING MAY BE REQUIRED BY LEED AND OTHER PROCESSES THAT MAY OCCUR OUT OF SEQUENCE WITH COMMISSIONING SERVICE. CONTRACTOR SHALL CONDUCT, DOCUMENT, SUPPORT AND SCHEDULE THIS TESTING AS DIRECTED BY STARBUCKS CXA.



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G-005

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PRE-APPROVED LIST FOR LOW EMMITING MATERIALS

MANUFACTURER - PRODUCT VOC CONTENT	
ABS WELDING ADHESIVE	LIMIT 325 g/L
IPS CORPORATION - WELD-ON 2771 AND 2773 - ABS PIPE CEMENT	325 g/L
IPS CORPORATION - WELD-ON 773 - ABS PIPE CEMENT	<325 g/L
OATEY - LO-VOC ABS BLACK SOLVENT CEMENT	325 g/L
CARPET ADHESIVE	LIMIT 50 g/L
HB FULLER - TEC 749 RELEASE PRESS	0 g/L
MAPEI - ULTRABOND ECO 120	43 g/L
MAPEI - ULTRABOND ECO 800	0 g/L
ROBERTS - 6700 SUPERIOR	0 g/L
CERAMIC TILE ADHESIVE	LIMIT 65 g/L
DUPONT SURFACES - CORIAN SOLID SURFACES JOINT ADHESIVE	<50 g/L
LATICRETE - 252 SILVER	0 g/L
LATICRETE - 254 PLATINUM	0.5 g/L
LATICRETE - 255 MULTIMAX	0 g/L
LATICRETE - 317 THIN SET	2.5 g/L
MAPEI - KERABOND	0 g/L
MAPEI - KERASET	0 g/L
MAPEI - PLANIPATCH	0 g/L
MAPEI - PLANIPATCH PLUS	53 g/L
MAPEI - TYPE 1	60 g/L
MAPEI - ULTRAFLEX 1	0 g/L
MAPEI - ULTRAFLEX 2	0 g/L
MAPEI - ULTRAFLEX S2 MONO	<12 g/L
MAPEI - ULTRAMASTIC ECO	57 g/L
RAECO - R-2000 BONDING AGENT	2.5 g/L
CONTACT ADHESIVE	LIMIT 80 g/L
3M - FASTBOND CONTACT ADHESIVE	77 g/L
HENKEL - LEPAGE CONTACT CEMENT	<10 g/L
HENKEL - LEPAGE PRES-TITE GREEN CONTACT CEMENT	<10 g/L
CPVC ADHESIVE	LIMIT 490 g/L
OATLEY - HEAVY DUTY CPVC ORANGE SOLVENT CEMENT	77 g/L
OATLEY - FLOWGUARD GOLD ALL WEATHER 1 STEP SOLVENT CEMENT	<10 g/L
DRYWALL AND PANEL ADHESIVE	LIMIT 50 g/L
DATENBLATT_A814 - PART A AND B	0 g/L
FRANKLIN INTERNATIONAL - MARLITE C-551	2.6 g/L
FRANKLIN INTERNATIONAL - TITEBOND SOLVENT FREE FAST GRAB	2.6 g/L
LIQUID NAILS - FRP - 310	34 g/L
GREEN GLUE COMPANY - GREEN GLUE	<5 g/L
ROMAN - PRO-774	0 g/L
MULTI-PURPOSE CONSTRUCTION ADHESIVE	LIMIT 70 g/L
3M - SCOTCH-WELD URETHANE ADHESIVE DP-620NS, BLACK	<10 g/L
ELMER'S - CARPENTER'S INTERIOR WOOD GLUE	<1 g/L
EVERBUILD - GUN A NAIL STANDARD	25.3 g/L
FRANKLIN INTERNATIONAL - TITEBOND III WOOD GLUE	5.6 g/L
HENKEL - LEPAGE CARPENTER'S GLUE	<2 g/L
HENKEL - LEPAGE EPOXY RESIN	.38 g/L
HENKEL - LEPAGE PL PREMIUM	45 g/L
LIQUID NAILS - LN 704	22 g/L
LIQUID NAILS - LN 903	<70 g/L
ROMAN - PRO-838	17.2 g/L
ROMAN - PRO-880	<50 g/L
ROMAN - PRO-935	8 g/L
SIKA - SIKABOND	48.3 g/L

PRE-APPROVED LIST FOR LOW EMMITING MATERIALS

MANUFACTURER - PRODUCT VOC CONTENT	
PVC WELDING	LIMIT 510 g/L
IPS CORPORATION - IPEX SYS 15 GREY	<510 g/L
IPS CORPORATION - WELD_ON 782 CLEAR CEMENT FOR PVC	<510 g/L
IPS CORPORATION - WELD-ON 711 LOW VOC PIPE CEMENT	<510 g/L
IPS CORPORATION - WELD-ON 780 CLEAR CEMENT FOR PVC	<510 g/L
IPS CORPORATION - WELD-ON 781 CLEAR CEMENT FOR PVC	<510 g/L
IPS CORPORATION - WELD-ON 781 GREY CEMENT FOR PVC	<510 g/L
IPS CORPORATION - WELD-ON 810 - 2 COMPONENT ADHESIVE	50 g/L
IPS CORPORATION - WELD-ON DUIT 413 - PVC PIPE CEMENT	510 g/L
OATEY - CLEAR ADVANCED PVC CEMENT	<510 g/L
TIGRE - ADESIVO AQUATHERM (AQUATHERM E ESPECIAL) CPVC	330 g/L
TIGRE - ADESIVO PLASTICO PARA PVC - INCOLOR	332.14 g/L
ADHESIVE PRIMER FOR PLASTIC	LIMIT 550 g/L
IPS CORPORATION - WELD-ON PLUMBING CLEAR PRIMER FOR PVC	550 g/L
IPS CORPORATION - WELD-ON PLUMBING PURPLE PRIMER FOR PVC	550 g/L
OATLEY - PURPLE PRIMER NSF LISTED	550 g/L
SPECIAL PURPOSE AEROSOL ADHESIVE	LIMIT 70% BY WEIGHT
IPS CORPORATION - WELD-ON PLUMBING CLEAR PRIMER FOR PVC	64%
SUBFLOOR ADHESIVE	LIMIT 50 g/L
FRANKLIN INTERNATIONAL - GREENCHOICE WEATHERPROOF SUBFLOOR ADHESIVE (TITEBOND)	550 g/L
HENKEL - OSI PRO SERIES 450 SUBFLOOR ADHESIVE	<2 g/L
VCT ADHESIVE	LIMIT 50 g/L
BALL - STYCCIBOND F44	48 g/L
ROMAN - VOV 11901	5 g/L
ROMAN - VOV 11905	5 g/L
WOOD FLOORING ADHESIVE	LIMIT 100 g/L
ARMSTRONG WORLD INDUSTRIES - EVERLAST PREMIUM URETHANE	77 g/L
ARMSTRONG WORLD INDUSTRIES - HARTCO 57 WOOD FLOORING - URETHANE	65 g/L
ARMSTRONG WORLD INDUSTRIES - PROCONNECT WOOD FLOORING - ACRYLIC	7 g/L
HENKEL - LOCTITE PL400 SUBFLOOR ADHESIVE	5.2 g/L
SIKA CORPORATION - SIKABOND-T54 - URETHANE	30.38 g/L
SIKA CORPORATION - SIKABOND-T55 - URETHANE	83 g/L
ARCHITECTURAL SEALANT	LIMIT 250 g/L
3M - FIRE BARRIER CP-25WB+	<1 g/L
3M - FIRE BARRIER MOLDABLE PUTTY+	0 g/L
BALL - STOPGP P131 PRIMER	15 g/L
BASF - SONOLASTIC	<100 g/L
CERTAINTED - PROROC READY-MIX JOINT COMPOUND	0 g/L
CUSTOM BUILDING PRODUCTS - POLYBLEND SANDED GROUT	0 g/L
DAP - ALEX PAINTERS'S ACRYLIC LATEX CAULK - ALL COLORS	59.2 g/L
DAP - ALEX PLUS ACRYLIC LATEX CAULK SILICONE - CLEAR	44.4 g/L
DAP - DYNAFLEX 230	49 g/L
DAP - KWIK SEAL TUB & TILE CAULKING - ALL COLORS	25.4 g/L
DAP - SILICONE PLUS RUBBER KITCHEN & BATH SEALANT	<40 g/L
DATENBLATT - PCI ZEMTEC 1K	.015 g/L
DATENBLATT - MAPESIL AC	26 g/L
DESIGN POLYMERICS - 1010 WATER BASED DUCT SEALANT	0 g/L
DESIGN POLYMERICS - 1020 WATER BASED DUCT SEALANT	0 g/L
DESIGN POLYMERICS - 1030 WATER BASED DUCT SEALANT	0 g/L
DOW CORNING - 732 SILICONE	35 g/L
DOW CORNING - 786 SILICONE	33 g/L
DOW CORNING - HVAC/R SILICONE	33 g/L
DYE-N-SEAL-DECORATIVE CONCRETE DYE	0 g/L

PRE-APPROVED LIST FOR LOW EMMITING MATERIALS

MANUFACTURER - PRODUCT VOC CONTENT	
ARCHITECTURAL SEALANT	LIMIT 250 g/L
DUCTMATE INDUSTRIES - PRO SEAL	41 g/L
EUCLID CHEM CO - CLEARSEAL WB 150	134 g/L
GE - SILICONE SEALANT	20 g/L
GRABBER - GRABBERGARD EFC	32.5 g/L
HAMILTON DRYWALL PRODUCTS - POWDERED JOINT CEMENT	0 g/L
HARDCAST CARLISLE - DUCTSEAL 321	75 g/L
HARDCAST CARLISLE - IRONGRIP 601	49 g/L
HENKEL - OSI PRO-SERIES	<50 g/L
HERCULES - STAY PUT PUTTY	0 g/L
IDEAL CHEMICAL PRODUCTS - IDEALSEAL UNIVERSAL SILICONE	0 g/L
IPS - WELD-ON ALL SEAL PIPE JOINT COMPOUND	0 g/L
LATICRETE - 1500 SANDED GROUT	0 g/L
LATICRETE - 1600 UNSANDED GROUT	0 g/L
LATICRETE - LATASIL SILICONE	37.16 g/L
LATICRETE - PERMACOLOR GROUT	0 g/L
LATICRETE - PREMIUM ACRYLIC CAULK	50 g/L
LATICRETE - SPECTRALOCK	.031 g/L
MAPEI - KERACAULK S	41 g/L
MAPEI - KERACOLOR S	0 g/L
MAPEI - KERACOLOR U	0 g/L
MAPEI - KERALASTIC MORTAR	0 g/L
MAPEI - KERAPLY	3 g/L
MAPEI - KERAPOXY - PART A	7 g/L
MAPEI - KERAPOXY IEG - PART A	21 g/L
MAPEI - ULTRACOLOR PLUS	0 g/L
MAPEI - ULTRACONTACT	0 g/L
MAPEI - ULTRAFLEX LFT	0 g/L
MAPEI - ULTRALITE MORTAR	0 g/L
MAPEI - ULTRALITE MORTAR PRO	0 g/L
MOMENTIVE - SCS1000 SILICONE SEALANT	20 g/L
MOMENTIVE - SILICONE RUBBER SEALANT	27 g/L
NATIONAL GYPSUM - READY MIX JOINT COMPOUNDS - PROFORM (MULTIPLE PRODUCTS)	2 g/L
NR4000 - WHITE LIGHTNING SILICONIZED ACRYLIC LATEX CAULK	43 g/L
OATEY - GREAT WHITE PJC	3 g/L
OATEY - PLUMBERS PUTTY	0 g/L
PCI SECCORAL 1 K	1.5 g/L
POLYMER ADHESIVE - AIRSEAL #22	<21 g/L
POLYMER ADHESIVE - AIRSEAL #33	35 g/L
REDGARD - F1051	5 g/L
RIGIPS - SUPER FUGENFULLER JOINT COMPOUND	0.009 g/L
SICHERHEITSDATENBLATT - BRILLUX ACRYLIC SEALANT 395	20 g/L
SICHERHEITSDATENBLATT - BRILLUX AIRLESS-SPACHTEL 1890	1 g/L
SICHERHEITSDATENBLATT - BRILLUX RIGIPS	0.0009 g/L
SICHERHEITSDATENBLATT - BRILLUX CREGLAS ELF 377	1 g/L
SICHERHEITSDATENBLATT - BRILLUX UNIFLOTT 6 JOINT COMPOUND	0 g/L
SICHERHEITSDATENBLATT - BRILLUX UNIFLOTT 8 JOINT COMPOUND	0 g/L
SIKAGARD - HIGH GLOSS CLEAR SEALER	<20 g/L
SOLOCROM - JUNTA PLAC MASILLA	3 g/L
SONNEBORN, DIVISION OF BASF - OMNI-PLUS	0 g/L
SONNEBORN, DIVISION OF BASF - SONOLAC	41 g/L
SOUDAL - FIX ALL CLASSIC	33.4 g/L
SPECSEAL - SERIES SSS INTUMESCENT SEALANT	22 g/L
TITEBOND - PAINTER'S PLUS CAULK - CLEAR	28 g/L
TITEBOND - PAINTER'S PLUS CAULK - WHITE OR COLORS	33 g/L
TREMCO - TREMFLEX 834 - WHITE	22 g/L
TREMCO - TREMSIL 200 - CLEAR	1 g/L
TREMCO - TREMSTOP ACRYLIC	35 g/L

PRE-APPROVED LIST FOR LOW EMMITING MATERIALS

MANUFACTURER - PRODUCT VOC CONTENT	
ARCHITECTURAL SEALANT	LIMIT 250 g/L
USG - FIRECODE COMPOUND	<2 g/L
USG (US GYPSUM CO) - BEADEX ALL PURPOSE DRYWALL	<2 g/L
USG (US GYPSUM CO) - BEADEX LITE TAPING DRYWALL	<2 g/L
USG (US GYPSUM CO) - SHEETROCK ALL PURPOSES JOINT COMPOUND	0 g/L
VERSAFLEX, INC. - SL45 PART B (HARDNER)	0 g/L
VERSAFLEX, INC. - SL45 PART B (PRE-POLYMER)	0 g/L
W R GRACE - FLAMESAFE FS 1900 FIRESTOP	10.86 g/L
WESTPAC MATERIALS - FAST SET 20 - DRYWALL JOINT AND PATCHING COMPOUND	0 g/L
WESTPAC MATERIALS - FAST SET 40 - DRYWALL JOINT AND PATCHING COMPOUND	0 g/L
WESTPAC MATERIALS - FAST SET LITE 5 - DRYWALL JOINT AND PATCHING COMPOUND	0 g/L
WESTPAC MATERIALS - ECO SET LITE 20 - DRYWALL JOINT AND PATCHING COMPOUND	0 g/L
WESTPAC MATERIALS - ECO SET LITE 40 - DRYWALL JOINT AND PATCHING COMPOUND	0 g/L
WESTPAC MATERIALS - ECO SET LITE 90 - DRYWALL JOINT AND PATCHING COMPOUND	0 g/L
ARCHITECTURAL PAINTS/COATINGS/PRIMER - FLATS	LIMIT 50 g/L
C2 - L-8000 LOVO INTERIOR LATEX NON-REFLECTIVE FLAT	<50 g/L
ICI - DULUX	30 g/L
SHERWIN-WILLIAMS - HARMONY INTERIOR LATEX PRIMER	0 g/L
SHERWIN-WILLIAMS - PROMAR LATEX PRIMER	0 g/L
ARCHITECTURAL PAINTS/COATINGS/PRIMER - NON-FLATS	LIMIT 150 g/L
BRILLUX - PM 270	<100 g/L
BRILLUX - ACYL-FASSADENFARBE	25 g/L
BRILLUX - LF595	1 g/L
BRILLUX - PM246	<100 g/L
C2 - L1800 LOVO WALLBOARD PRIMER	<50 g/L
C2 - L8200 LOVO INTERIOR LATEX EGGSHELL	<50 g/L
C2 - L8400 LOVO INTERIOR LATEX SEMI-GLOSS	<50 g/L
ICI - DULUX ECOSURE WATER-BASED GLOSS	75 g/L
ICI - DULUX LIFEMASTER EGGSHELL INTERIOR LATEX ENAMEL	0 g/L
ICI - DULUX LIFEMASTER SEMI-GLOSS INTERIOR LATEX ENAMEL	0 g/L
SHERWIN-WILLIAMS - COLORACCENTS, EGGSHELL	126 g/L
SHERWIN-WILLIAMS - DTM ACRYLIC PRIMER	132 g/L
SHERWIN-WILLIAMS - ECOSELECT ZERO VOC EGGSHELL LATEX	0 g/L
SHERWIN-WILLIAMS - ECOSELECT ZERO VOC INTERIOR LATEX EGGSHELL	<40 g/L
SHERWIN-WILLIAMS - HARMONY INTERIOR LATEX PRIMER	0 g/L
SHERWIN-WILLIAMS - HARMONY INTERIOR SEMI-GLOSS	<50 g/L
SHERWIN-WILLIAMS - HARMONY, EGGSHELL	<50 g/L
SHERWIN-WILLIAMS - PRO INDUSTRIAL PRO-CRYL ACRYLIC PRIMER	96 g/L
SHERWIN-WILLIAMS - PROMAR200 PRIMER	91 g/L
SHERWIN-WILLIAMS - PROMAR400 LATEX EGGSHELL, EXTRA WHITE	0 g/L
SHERWIN-WILLIAMS - PROMAR400 LATEX SEMI-GLOSS, EXTRA WHITE	0 g/L
ANTICORROSIVE/ANTIRUST PAINT	LIMIT 250 g/L
CAFECO - SPRAYFILM WB 4	0 g/L
ICI PAINTS - DEVOE DEVFLEX 4020PF	91 g/L
SHERWIN-WILLIAMS - WATER BASED CATALYZED EPOXY	120 g/L
CLEAR WOOD FINISHES - VARNISH	LIMIT 350 g/L
SHERWIN-WILLIAMS - WOOD CLASSICS WATERBORNE POLYURETHANE VARNISH	311 g/L
FLOOR COATINGS	LIMIT 100 g/L
MAPEI - MAPECEM QUICKPATCH	0 g/L
ADVANCED FLOOR PRODUCTS - RETROPLACE 99	0 g/L



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FOR CONSTRUCTION

PROJECT NAME:
LECANTO HWY & NORVELL BRYANT

PROJECT ADDRESS:
**3159 W NORVELL BRYANT HWY
LECANTO, FL 34461**

STORE #: 78366
PROJECT #: 97107-001
ISSUE DATE: 09/06/2023
DESIGNER: RAI MONTERO
PRODUCTION DESIGNER: ANDY MCLLOUD
CHECKED BY: DONALD RETHMAN

Revision Schedule			
Rev	Date	By	Description

SHEET TITLE:
PRE-APPROVED CONST. MATERIALS
SCALE: NO SCALE

SHEET NUMBER:
G-006

BLD202323715

PRE-APPROVED LIST FOR LOW EMMITING MATERIALS

MANUFACTURER - PRODUCT VOC CONTENT

WATERPROOFING SEALERS	LIMIT 250 g/L
ADVANCED FLOOR PRODUCTS - RETROGUARD	100 g/L
AMERIPOLISH - PROGUARD STAIN SHIELD	<50 g/L
DEVOE - WATERBORNE EPOXY	200 g/L
H&C - CONCRETE SEALER	250 g/L
MAPEI - MAPELASTIC AQUADEFENSE	0 g/L
SCOFIELD - FORMULA ONE	0 g/L
SCOFIELD - FORMULA ONE FINISH COAT	0 g/L
SCOFIELD - FORMULA ONE GUARD-W	<100 g/L
SCOFIELD - FORMULA ONE DYE	10.7 g/L
SCOFIELD - FORMULA ONE LITHIUM DENSIFIER	0 g/L
SEALSOURCE - KROMAPOLISH	0 g/L

STAINS	LIMIT 250 g/L
H&C - CONCRETE STAIN	246 g/L
AMERIPOLISH - COLOR JUICE COATING	0 g/L
DALYS - WOODBORNE WOOD STAIN	<50 g/L

CARPET	
INTERFACEFLOR - GLP	CRI GREEN LABEL
INTERFACEFLOR - SOFTSISAL	CRI GREEN LABEL
LEES CARPET TILE - GROUND STRATA MODULAR	CRI GREEN LABEL
SHAW INDUSTRIES - VIBE	CRI GREEN LABEL

PRE-APPROVED LIST FOR LOW EMMITING MATERIALS

MANUFACTURER - PRODUCT VOC CONTENT

HARD SURFACE FLOORING	
NON-ORGANIC GLAZED TILE - GENERIC (ALL NON-ORGANIC, GLAZED TILE COMPLIES)	N/A
ALTRO LTD - STRONGHOLD 30	FLOORSCORE
ALTRO LTD - AQUARIUS	FLOORSCORE
ALTRO LTD - ATLAS 40	FLOORSCORE
ALTRO LTD - CONTRAX	FLOORSCORE
ALTRO LTD - DESIGNER 25	FLOORSCORE
ALTRO LTD - IMPRESSIONIST II	FLOORSCORE
ALTRO LTD - MARINE 20	FLOORSCORE
ALTRO LTD - MAXIS 25	FLOORSCORE
ALTRO LTD - MIRICA	FLOORSCORE
ALTRO LTD - SUPREMA II	FLOORSCORE
ALTRO LTD - TIMBERSAFE II	FLOORSCORE
ALTRO LTD - WALKWAY 20	FLOORSCORE
ALTRO LTD - WALKWAY 20D	FLOORSCORE
ALTRO LTD - XPRESSLAY	FLOORSCORE
CROSSVILLE INC - AMERCANO	FLOORSCORE
CROSSVILLE INC - BLUESTONE	FLOORSCORE
CROSSVILLE INC - BUILDING BLOX	FLOORSCORE
CROSSVILLE INC - CLASSIC MOSAICS	FLOORSCORE
CROSSVILLE INC - COLOR BLOX EC	FLOORSCORE
CROSSVILLE INC - COLOR BLOX MOSAICS	FLOORSCORE
CROSSVILLE INC - COLOR BLOX TOO	FLOORSCORE
CROSSVILLE INC - COTTO AMERICANA	FLOORSCORE
CROSSVILLE INC - CROSS COLORS	FLOORSCORE
CROSSVILLE INC - CROSS COLORS LP	FLOORSCORE
CROSSVILLE INC - ECOCYCLE	FLOORSCORE
CROSSVILLE INC - MAIN STREET	FLOORSCORE
CROSSVILLE INC - PALAIS	FLOORSCORE
CROSSVILLE INC - POMPEII	FLOORSCORE
CROSSVILLE INC - RETRO ACTIVE	FLOORSCORE
CROSSVILLE INC - STRUCTURE	FLOORSCORE
CROSSVILLE INC - TEXTURES	FLOORSCORE
CROSSVILLE INC - TUSCAN CLAY	FLOORSCORE
CROSSVILLE INC - ULTIMETAL	FLOORSCORE
CROSSVILLE INC - VISTA AMERICANA	FLOORSCORE
CROSSVILLE INC - WEATHERSTONE	FLOORSCORE
CROSSVILLE INC - WOOD IMPRESSIONS	FLOORSCORE

PRE-APPROVED LIST FOR LOW EMMITING MATERIALS

MANUFACTURER - PRODUCT VOC CONTENT

COMPOSITE WOOD	NO ADDED UREA-FORMALDEHYDE
ANY - APA RATED STRUCTURAL PLYWOOD (EXPOSURE 1 OR EXTERIOR)	YES
COLUMBIA FOREST PRODUCTS - EUROPLY PLUS	YES
COLUMBIA FOREST PRODUCTS - PUREBOND	YES
EGGERS INDUSTRIES - 206 5-PLY	YES
GLASTEEL - GLASLINER - FRP	YES
GRAHAM WOOD DOORS - GPD-45 5-PLY AGRIFIBER	YES
GRAHAM WOOD DOORS - GPD-AP 5-PLY AGRIFIBER	YES
GRAHAM WOOD DOORS - GPD-EC 5-PLY ENGINEERED COMPOSITE	YES
GRAHAM WOOD DOORS - GPD-SL 5-PLY STAVE LUMBER	YES
LYDEN DOORS - CD200 NAUF PARTICLEBOARD CORE	YES
LYDEN DOORS - CD250 AGFIBER CORE	YES
LYDEN DOORS - CD300 NAUF STAVE LUMBER CORE	YES
LYDEN DOORS - CD350 STRUCTURAL COMPOSITE CORE	YES
MARSHFIELD - ENVIRONMENTAL CLASS	YES
NAUF - COMPOSITE WOOD DOOR	YES
ROSEBURG - COMPOSITE WOOD PANTLS	YES
SIERRA PINE - ARREIS	YES
SIERRA PINE - MEDEX	YES
SIERRA PINE - MEDITE FR	YES
SIERRA PINE - MEDITE II	YES
SIERRA PINE - PERMACORE	YES

GYPSUM BOARD	
AMERICAN GYPSUM - FIREBLOCK	GREENGUARD GOLD
GEORGIA PACIFIC - TOUGHROCK FIREGUARD	GREENGUARD GOLD
LAFARGE - FIRECHECK	GREENGUARD GOLD
NATIONAL GYPSUM - GOLD BOND FIRESHIELD	GREENGUARD GOLD
CERTAINTEED - PROROC TYPE X	CHPS
USG - SHEETROCK FIRECODE	CHPS
GEORGIA PACIFIC - TOUGHROCK GYPSUM BOARD	GREENGUARD GOLD
SMDS - DENSARMOR PLUS	GREENGUARD GOLD

ACOUSTICAL CEILING SYSTEM	
ARMSTRONG - CERAMAGUARD	CHPS
ARMSTRONG - FINE FISSURED	CHPS
ARMSTRONG - CLEANROOM VL	CHPS
ARMSTRONG - CORTEGA	CDPH/EHLB
ARMSTRONG - CLEANROOM	CDPH/EHLB
CRANE - SEQUENTIA LAMINATED PANELS	GREENGUARD
ARMSTRONG - METALWORKS	CHPS
USG - RADAR	CHPS/CDPH/EHLB
USG - SHEETROCK	CA/DHS/EHLB

WALL COVERINGS	
CERTAINTEED - DIAMONDBACK TILE BACKER	GREENGUARD GOLD
COLUMBIA FOREST PRODUCTS - EUROPLY PLUS	NAUF
COLUMBIA FOREST PRODUCTS - PUREBOND	NAUF
CRANE COMPOSITES - GLASBORD FRP	GREENGUARD GOLD
DAL-TILE - CERAMIC WALL TILE	CHPS
GEORGIA PACIFIC - DENSSHIELD TILE BACKER BOARD	CHPS
GLASTEEL - GLASLINER FRP	GREENGUARD GOLD
MARLITE - FRP	GREENGUARD
NATIONAL GYPSUM - E2XP TILE BACKER	GREENGUARD GOLD
OMNOVA - ECORE	GREENGUARD GOLD
PANOLAM INDUSTRIES - PANOLAM FRP	GREENGUARD GOLD
PARKLAND PLASTICS - PLASTEX NRP	GREENGUARD GOLD
SEQUENTIA - EMBOSSED TEXTURE	GREENGUARD



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Timothy L. Roberding, PE
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09/12/2023

FOR CONSTRUCTION

PROJECT NAME:
LECANTO HWY & NORVELL BRYANT

PROJECT ADDRESS:
**3159 W NORVELL BRYANT HWY
LECANTO, FL 34461**

STORE #: 78366
PROJECT #: 97107-001
ISSUE DATE: 09/06/2023
DESIGNER: RAI MONTERO
PRODUCTION DESIGNER: ANDY MCLLOUD
CHECKED BY: DONALD RETHMAN

Revision Schedule			
Rev	Date	By	Description

SHEET TITLE:
PRE-APPROVED CONST. MATERIALS
SCALE: NO SCALE

SHEET NUMBER:
G-007

BLD202323715

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WALL CONSTRUCTION SCHEDULE	
WALL LABELING KEY: INTERIOR SHEATHING	
WALL STUD	
INTERIOR MODIFIER	
WALL STUD	
4a	3 5/8" 20 GA STUDS AT 16" O.C. (FULL HEIGHT).
4b	3 5/8" 20 GA STUDS AT 16" O.C. (TERMINATE 6" ABOVE CEILING). PROVIDE 45 DEGREE METAL STUD BRACING AT 48" O.C. FROM TOP OF STUD WALL TO STRUCTURE ABOVE.
4c	3 5/8" 16 GA STUDS AT 16" O.C. (PARTIAL HEIGHT). DRYWALL SCREWS AT 12" O.C.
6a	6" 20 GA STUDS AT 16" O.C. (FULL HEIGHT)
6b	6" 20 GA STUDS AT 16" O.C. (TERMINATE 6" ABOVE CEILING). PROVIDE 45 DEGREE METAL STUD BRACING AT 48" O.C. FROM STUD WALL TO STRUCTURE ABOVE.
INTERIOR SHEATHING	
A	ONE SIDE 5/8" MOISTURE RESISTANT GYP. BOARD (UNDERSIDE OF GYPSUM BOARD...
B	BOTH SIDES 5/8" MOISTURE RESISTANT GYP. BOARD (ONE SIDE UNDERSIDE OF GYPSUM BOARD CEILING AND OTHER SIDE TERMINATE 6" ABOVE ACT CEILING)
C	ONE SIDE 5/8" PLYWOOD SUBSTRATE BOARD (UNDERSIDE TERMINATE 6" ABOVE ACT CEILING)
D	ONE SIDE 5/8" MOISTURE RESISTANT GYP. BOARD AND OTHER SIDE 5/8" TYPE "X" GYP. BOARD (BOTH SIDE UNDERSIDE OF GYPSUM BOARD CEILING)
E	ONE SIDE 5/8" TYPE "X" GYP. BOARD (ONE SIDE UNDERSIDE OF GYPSUM BOARD CEILING)
F	ONE SIDE 5/8" MOISTURE RESISTANT GYP. BOARD (ONE SIDE UNDERSIDE OF GYPSUM BOARD CEILING) AND OTHER SIDE 5/8" PLYWOOD SUBSTRATE BOARD. BOARD (TERMINATE 6" ABOVE ACT CEILING)
G	BOTH SIDES 5/8" MOISTURE RESISTANT GYP. BOARD (ONE SIDE UNDERSIDE OF GYPSUM BOARD CEILING AND OTHER SIDE UP TO STRUCTURE)
H	BOTH SIDES 5/8" MOISTURE RESISTANT GYP. BOARD (ONE SIDE UNDERSIDE TERMINATE 6" ABOVE ACT CEILING AND OTHER SIDE UP TO STRUCTURE)
I	SIDE 5/8" TYPE "X" GYP. BOARD (ONE SIDE UNDERSIDE OF GYPSUM BOARD CEILING) AND OTHER SIDE 5/8" MOISTURE RESISTANT GYP. BOARD (UP TO STRUCTURE)
J	BOTH SIDES 5/8" MOISTURE RESISTANT GYP. BOARD (BOTH SIDE TERMINATE 6" ABOVE ACT CEILING)
K	BOTH SIDES 5/8" MOISTURE RESISTANT GYP. BOARD (UP TO 4' - 0" AFF)
L	ONE SIDE 5/8" MOISTURE RESISTANT GYP. BOARD (TERMINATE 6" ABOVE ACT CEILING) AND OTHER SIDE 5/8" TYPE "X" GYP. BOARD (UNDERSIDE OF GYPSUM BOARD CEILING)
INTERIOR MODIFIERS	
ai	ACOUSTIC INSULATION (FULL HEIGHT)
48	PARTIAL HEIGHT WALL 48" AFF. 16 GA METAL STUDS AT 16" O.C. W/ RCKW RIGID CONNECTORS AT FLOOR. (MODIFIER = HEIGHT IN INCHES A.F.F.)

WALL BLOCKING KEY					
SYMBOL	ITEM	WEIGHT	HEIGHT A.F.F.	APPROX. WIDTH	
A	WORKROOM HAND SINK	128 LBS (58 KG)	36" TO 40" (915MM TO 1015MM)	30" (760MM) BEHIND SINK	
B	SHELVES ABOVE COMPARTMENT SINK	200 LBS (91 KG)	48" TO 76" (1220MM TO 1930MM)	96" (2440MM) CENTERED ABOVE COMPARTMENT SINK	
C	WATER FILTRATION SYSTEM	TBD BY VENDOR	COORDINATE LOCATION AND EXTENT WITH PENTAIR		
D	SHELVES AT MANAGER'S DESK	300 LBS (136 KG)	32" TO 96" (810MM TO 2440MM)	48" (1220MM) 3/4 (19MM) ACX PLYWOOD, CENTERED ON SHELVES	
E	EQUIPMENT RACK AT MANAGER'S DESK	300 LBS (136 KG)	44" TO 96" (1120MM TO 2440MM)	28" (710MM) 3/4 (19MM) ACX PLYWOOD, CENTERED ON RACK	
F	5-COMP LOCKERS	200LBS	0" TO 66" (0MM TO 1676MM)	SEE PLAN	
G	RESTROOM GRAB BARS	200 LBS (91 KG)	30" TO 36" (760MM TO 915MM)	60" (1525MM) AROUND WATER CLOSET	
H	RESTROOM HAND SINK	200 LBS (91 KG)	COMMERCIAL INSTALLATION REQUIRES CONCEALED ARM CARRIER. REFER TO MFR'S SPECIFICATION.		
I	MILLWORK BOXES	BLOCKING SPECIFICATION FOR FRENCH CLEATING SYSTEM. REFER TO DETAILS.			
J	DIAPER CHANGING STATION	250 LBS (113 KG)	40 1/2" TO 46 1/2" (1030MM TO 1180MM)	32" (810MM) BEHIND STATION	
K	UPPER CBE SHELVING	BLOCKING SPECIFICATION FOR CBE METAL SHELVES. REFER TO VENDOR'S SPECIFICATION AND DETAILS.			
L	MERCH BAY	TBD BY VENDOR (VARIES)	BLOCKING SPECIFICATION FOR ADAPTABLE CASEWORK. REFER TO VENDOR'S SPECIFICATION AND DETAILS.		
M	ALL ARTWORK, FIXTURES, ACCESSORIES AND CASEWORK FABRICATIONS NOT OTHERWISE NOTED	TBD BY VENDOR (VARIES)	GC TO PROVIDE WALL BLOCKING AS REQUIRED FOR ALL ITEMS FOR A COMPLETE AND SECURE INSTALLATION. EXTEND BLOCKING 8" (205MM) BEYOND ON EACH SIDE OF EACH ITEM.		
N	MENU BOARDS / HARDWARE	300 LBS (136 KG)	72" TO 112" (1829MM TO 2845MM)	EXTENT OF BACKBAR UPPER CASEWORK	
O	ADAPTABLE CASEWORK	TBD BY VENDOR (VARIES)	BLOCKING SPECIFICATION FOR ADAPTABLE CASEWORK. REFER TO VENDOR'S SPECIFICATION AND DETAILS.		
P	RESTROOM HAND DRYER	200LBS	36" TO 48" (915MM TO 1219MM)	24" STARTING 18" FROM WALL CORNER/SEE PLAN	

LEGEND	
	NEW FULL HEIGHT WALL
	NEW PARTIAL HEIGHT WALL
	EXISTING WALL
	WALL BLOCKING CALL OUT
	EXISTING COLUMN


GENERAL NOTES

- GENERAL CONTRACTOR TO VERIFY ALL DIMENSIONS AND NOTIFY STARBUCKS CONSTRUCTION MANAGER OF ANY DISCREPANCIES PRIOR TO CONSTRUCTION. ALL DIMENSIONS TO BE TAKEN FROM DESIGNATED DATUM POINT.
- GENERAL CONTRACTOR TO PROVIDE FIRE TREATED WOOD STUD BLOCKING, OR EQUIVALENT TO SUPPORT ANY WALL ATTACHMENT AND/OR SIGNAGE.
- IF EXISTING EXTERIOR ENTRANCE THRESHOLD EXCEEDS MINIMUM BARRIER FREE PROVISION OF THE CODE, REMOVE AND REPLACE WITH ACCESSIBLE THRESHOLD. RAISED THRESHOLDS AND FLOOR LEVEL CHANGES AT ACCESSIBLE DOORWAYS TO BE BEVELED WITH A SLOPE NO GREATER THAN 1:12.
- ALL DIMENSIONS ARE TO FINISHED FACE UNLESS SHOWN OR NOTED OTHERWISE.
- INSTALL MOISTURE RESISTANT GREEN BOARD ON BACKBAR WALL PER PROJECT MANUAL.
- ALL DOORS SHALL BE 32" (815MM) MINIMUM CLEAR OPENING WHEN OPENED TO 90 DEGREE POSITION UNLESS OTHERWISE NOTED.
- SEE SHEET A-601 FOR EXTERIOR DOOR AND WINDOW SCHEDULES.
- STARBUCKS VENDOR TO PROVIDE DOOR HARDWARE COMPONENTS AND GC TO INSTALL.
- VERIFY ALL EXISTING DOORS, HARDWARE AND FRAMES MEET STARBUCKS AND/OR CODE REQUIREMENTS.
- PROVIDE FIRE EXTINGUISHERS AS NOTED ON THE APPROVED PLANS FROM THE CITY.
- SEE SHEET A-501 FOR BUILDING DETAILS.
- REFER TO SHEET I-106 FOR FLOOR FINISHES.

KEYED NOTES

- EXISTING STOREFRONT DOOR. GC TO ENSURE IN PROPER WORKING ORDER AND REPAIR AS NECESSARY. REPLACE HARDWARE AS REQUIRED.
- EXISTING STOREFRONT WINDOW SYSTEM. GC TO CLEAN TO "LIKE NEW" CONDITION AND REPAIR AS NECESSARY.
- EXISTING 42IN SERVICE DOOR. GC TO ENSURE IN PROPER WORKING ORDER AND REPAIR AS NECESSARY. REPLACE HARDWARE AS REQUIRED.
- RECESSED ELECTRICAL PANEL. GC CONFIRM WITH WL AS INDICATED. MAINTAIN MINIMUM CLEARANCES AS REQUIRED BY CODE. REFER TO ELECTRICAL DRAWINGS.
- CONSTRUCT NEW 4' - 0" HIGH PARTIAL-HEIGHT WALL AS INDICATED. PROVIDE KNEE BRACE KIT #SKB AS MANUFACTURED BY PITCON INDUSTRIES @ 4' - 0" O.C. MAXIMUM FINISH ALL EXPOSED EDGES.
- INSTALL NEW DOORS AS INDICATED. SEE SHEET A-601 FOR DOOR AND HARDWARE TYPE.
- OUTLINE OF SOFFIT ABOVE.
- OUTLINE OF BAR PER CASEWORK MANUFACTURER.
- FIRE EXTINGUISHER LOCATION.
- GC TO INSTALL REINFORCED CONCRETE FLOOR SLAB AND VAPOR BARRIER OVER EXISTING COMPACTED FILL.
- SHELF FOR WATER HEATER ABOVE.
- ALIGN FACE OF FINISHED WALL.
- EXISTING DT WINDOW.
- REFER TO SHEET A-601 FOR DOOR AND HARDWARE TYPE.
- INSTALL BLACKOUT FILM ON EXTERIOR FACE OF GLAZING. REFER TO SHEET I-101.1 FOR GRAPHICS SCHEDULE.

NOTE:
SEE SHEET A-501, A-502 & A-503 FOR WALL CONSTRUCTION DETAILS.

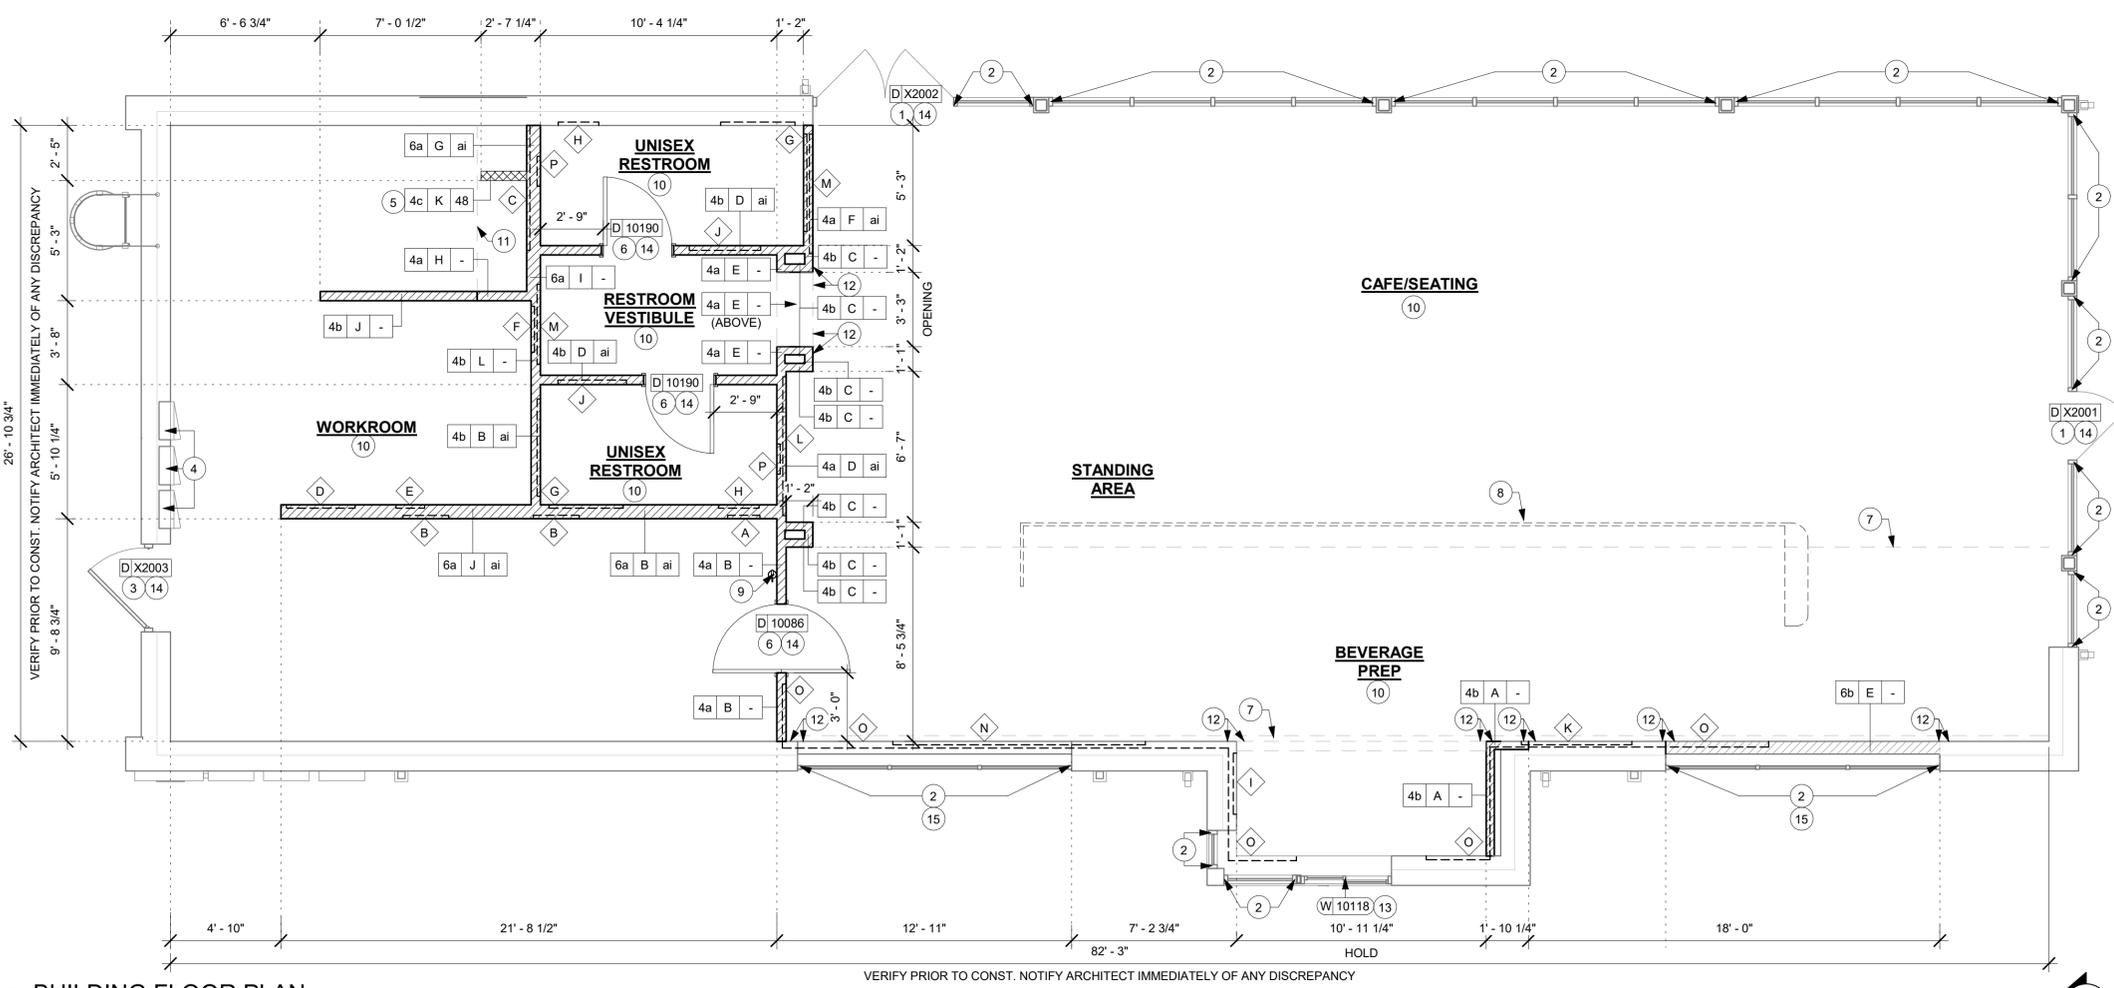

1 BUILDING FLOOR PLAN
Scale: 1/4" = 1'-0"



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PROJECT ADDRESS:
**3159 W NORVELL BRYANT HWY
LECANTO, FL 34461**

STORE #: 78366
PROJECT #: 97107-001
ISSUE DATE: 09/06/2023
DESIGNER: RAI MONTERO
PRODUCTION DESIGNER: ANDY MCLLOUD
CHECKED BY: DONALD RETHMAN

Revision Schedule			
Rev	Date	By	Description

SHEET TITLE:
BUILDING FLOOR PLAN

SCALE: 1/4" = 1'-0"

SHEET NUMBER:
A-101

BLD202323715



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Revision Schedule			
Rev	Date	By	Description

SHEET TITLE:
BUILDING FLOOR PENETRATION PLAN
SCALE: 1/4" = 1'-0"

SHEET NUMBER:
A-102


KEYED NOTES

- A. ALL STUB-UP DIMENSIONS ARE RELATIVE TO FINISHED WALL LOCATIONS (SHOWN AS OUTLINES ON THIS PLAN). REFER TO FLOOR PLAN FOR WALL PLACEMENT.
- B. FLOOR SINK/ DRAIN: REFER TO CUT SHEETS FOR COMPONENT SPECIFICATIONS AND CUTOUT REQUIREMENTS.
- C. WASTE LINE PENETRATIONS: REFER TO PLUMBING PLANS FOR INDIVIDUAL LINE LOCATIONS.
- D. STUB-UP PENETRATIONS: REFER TO ELECTRICAL AND PLUMBING PLANS FOR INDIVIDUAL STUB-UP LOCATIONS.
- E. TOILET FLOOR PENETRATION: REFER TO CUT SHEETS FOR STUB-UP LOCATION RELATIVE TO FINISHED WALL.
- F. FLOOR PENETRATIONS AT MOP SINK: REFER TO PLUMBING PLANS FOR INDIVIDUAL LINE SPECIFICATION.
- G. PENETRATION TO BE LOCATED ON CENTERLINE OF WALL OR AS REQUIRED PER CONDITIONS.
- H. EXISTING HOSE BIB.
- J. LOCATION OF POWER AND DATA OUTLETS BEHIND MENU BOARDS. CENTER OUTLETS BEHIND MENU BOARDS. REFER TO DETAIL 2/I-509 FOR MORE INFORMATION.
- K. DUPLEX FLOOR OUTLET. COORDINATE FLOOR RECEPTACLES LOCATION WITH TABLE LEG.
- L. REFER TO SHEET I-106 FOR FLOOR FINISHES.
- M. LOCATION OF DUPLEX OUTLET AT 18 IN AFF. COORDINATE LOCATIONS WITH STARBUCKS CM. REFER TO ELECTRICAL SHEETS FOR MORE INFORMATION.
- N. ALL OUTLETS IN CAFE AND PARTNER'S AREA TO MATCH SURROUNDING COLOR RECEPTACLES AND COVER PLATE.
- P. LOCATION OF RADIANT 15A TAMPER RESISTANT ULTRA-FAST USB TYPE A/C OUTLET, WHITE AT 18 IN AFF. COORDINATE LOCATIONS WITH STARBUCKS CM. REFER TO ELECTRICAL SHEETS FOR MORE INFORMATION.

LEGEND


- FLOOR SINK
- FLOOR PENETRATION
- ELECTRICAL PENETRATION AREA
- DATUM POINT
- DRAIN FLOOR SINK (RESTROOMS)
- DATA OUTLET
- WALL OUTLET
- FLOOR OUTLET

NOTE: SEE SHEET I-101.1 FOR PLUMBING FIXTURE SCHEDULE

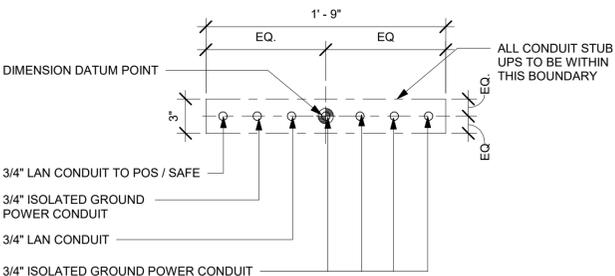


2 STUB UPS - FRONTBAR

Scale: 1 1/2" = 1'-0"

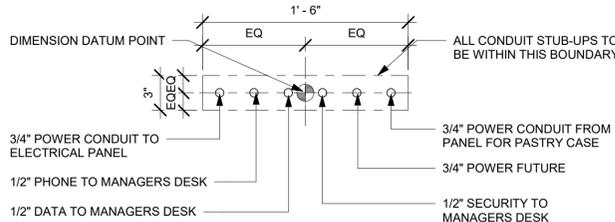


3 STUB UPS - DOUBLE POS/SAFE

Scale: 1 1/2" = 1'-0"

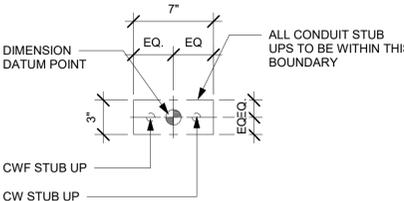

4 STUB UPS - ESPRESSO

Scale: 1 1/2" = 1'-0"

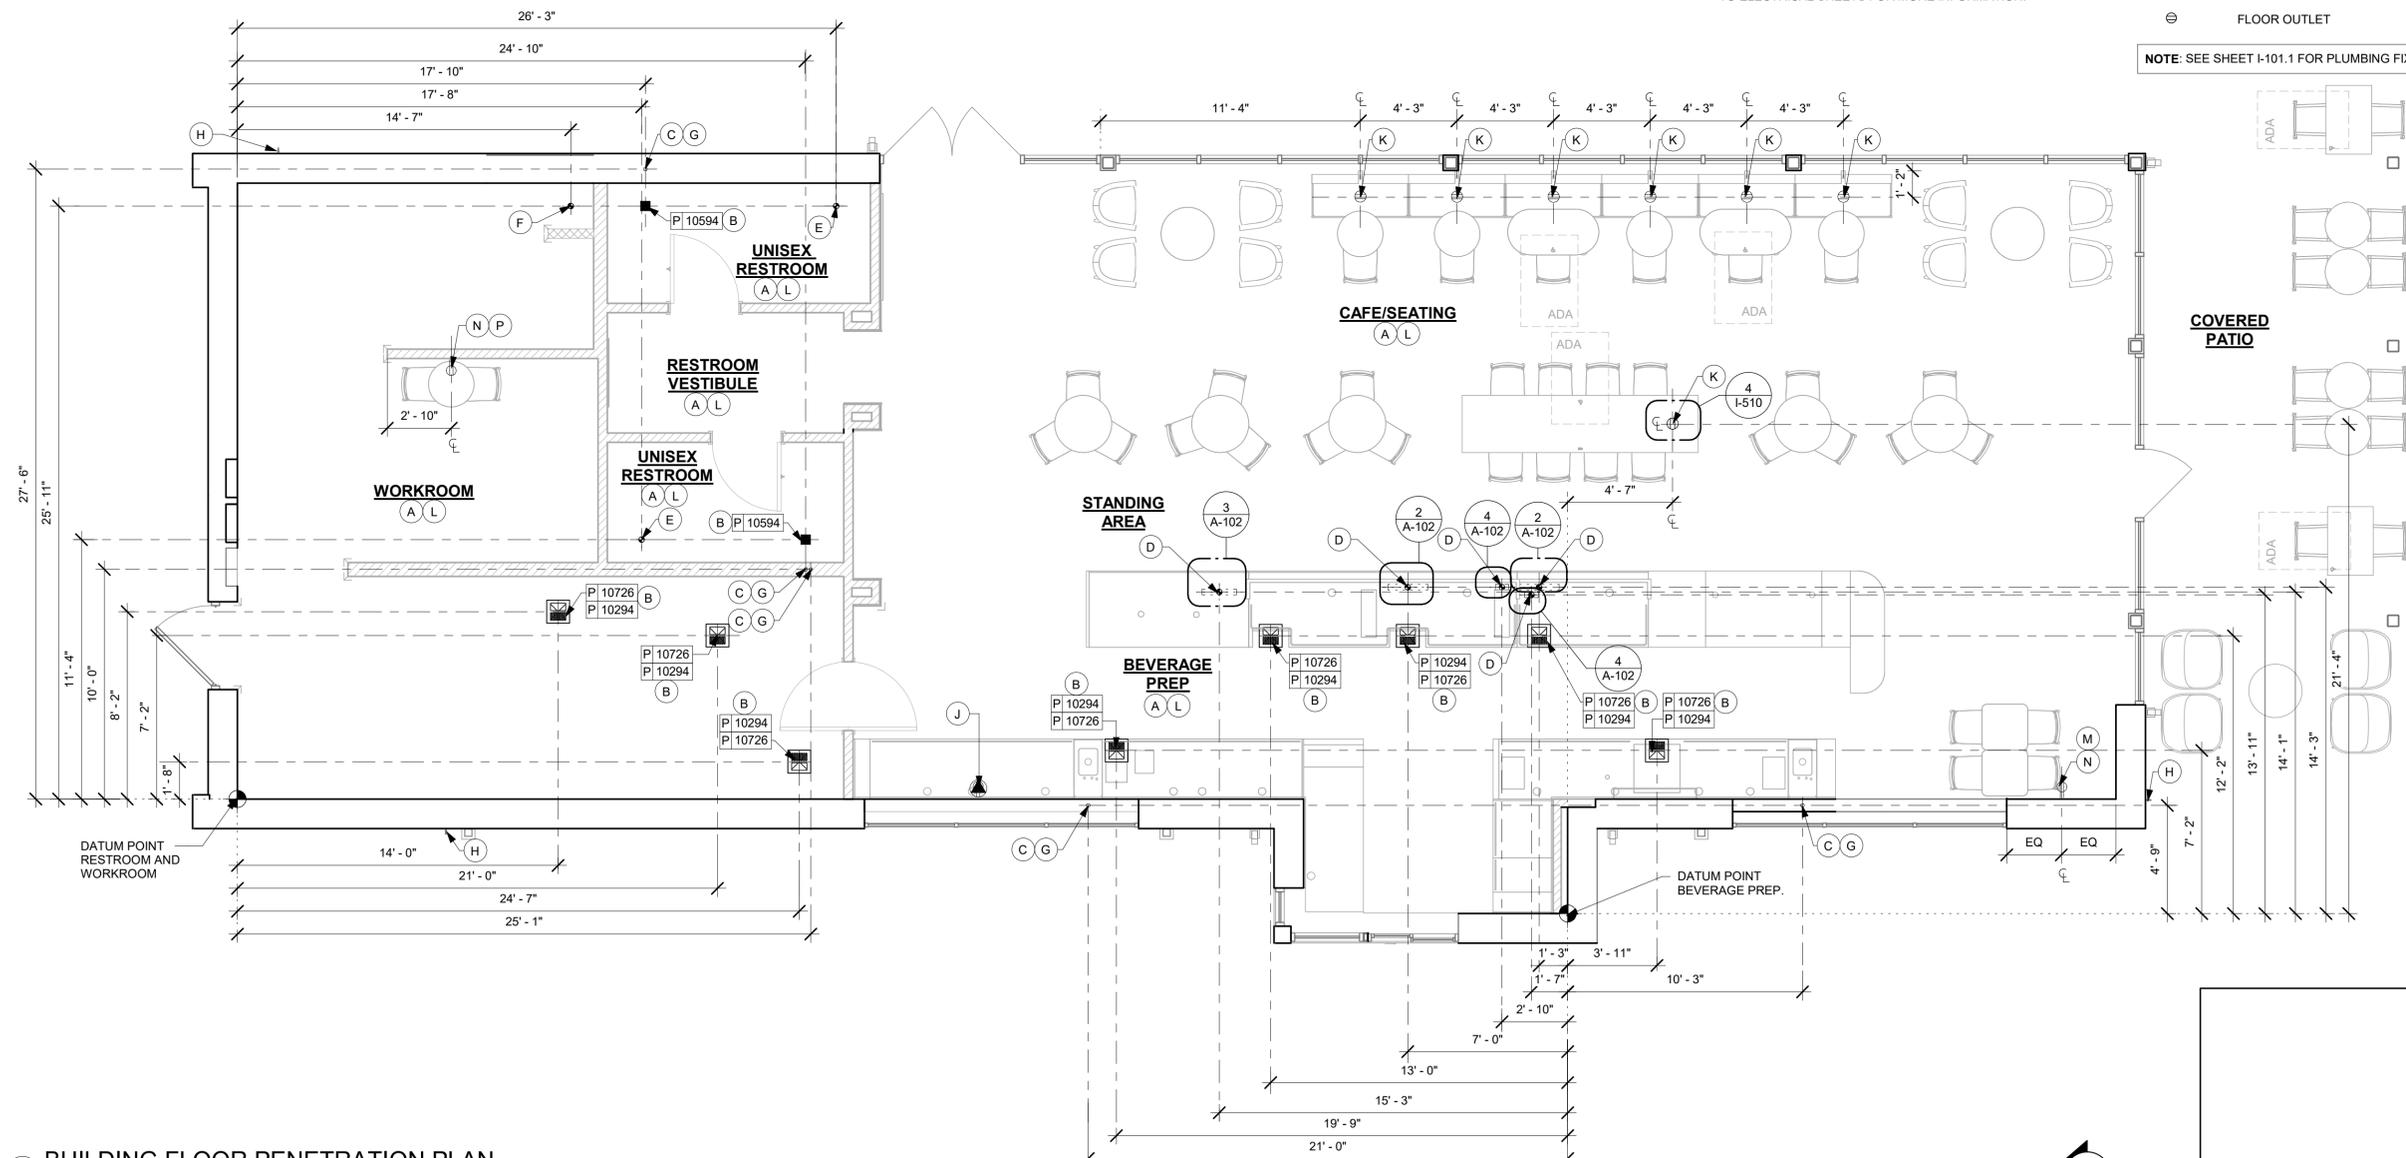

1 BUILDING FLOOR PENETRATION PLAN

Scale: 1/4" = 1'-0"



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CEILING TREATMENT SCHEDULE - "U"					
DESIGN ID	AREA	DESCRIPTION	FURN. BY	INST. BY	COMMENTS
OTHER					
19734	475 SF	ACT - ULTIMA - 2X2FT 61X61CM	GC	GC	FACTORY FINISHED SW7037 BALANCED BEIGE ; FOR ORDERING CONTACT DEB PICKENS AT DP.PICKENS@ARMSTRONGCEILINGS.COM, PH: 480-695-3053
X9301	1023 SF	CIRRUS SECOND LOOK ILING - 2X4FT 61X122CM LINEAR PANELS (III PANEL SCORING CREATES NOMINAL 8INX4FT)	GC	GC	PROVIDED BY: ARMSTRONG; FACTORY FINISHED BY MANUFACTURER TO MATCH SW7039-ES

PAINT SCHEDULE					
COLOR CODE	DESCRIPTION	LRV	FURN. BY	INST. BY	COMMENTS
SW6074-ES	SW - SPALDING GRAY - EGGSHELL	22	GC	GC	USE PRIMER CP-1
SW7037-ES	SW - BALANCED BEIGE - EGGSHELL	46	GC	GC	USE PRIMER CP-1
SW7039-ES	SW - VIRTUAL TAUPE - EGGSHELL	20	GC	GC	USE PRIMER CP-1
SW7039-SG	SW - VIRTUAL TAUPE - SEMIGLOSS	20	GC	GC	USE PRIMER CP-1

INTERIOR SIGNAGE SCHEDULE - "S"					
DESIGN ID	COUNT	DESCRIPTION	FURN. BY	INST. BY	COMMENTS
INTERIOR SIGNAGE					
21163	1	SUSPENDED MOP SIGNAGE - ILLUMINATED - CEILING MOUNTED	SB	GC	SEE DETAIL: 6/I-509; VENDOR: HILTON SIGNAGE
21720	1	MOBILE ORDER PICK UP SUSPENSION KIT	SB	GC	SHIP IN 2-6 WEEKS; VENDOR: HILTON; SEE DETAIL: 6/I-509

RESPONSIBILITY LEGEND

FURN. BY	INST. BY
SB - FURNISHED BY STARBUCKS	GC - INSTALLED BY GENERAL CONTRACTOR
GC - FURNISHED BY GENERAL CONTRACTOR	SB - INSTALLED BY STARBUCKS
VD - FURNISHED BY VENDOR	VD - INSTALLED BY VENDOR

NOTE:
ALL RESPONSIBILITIES TO BE CONFIRMED WITH STARBUCKS CONSTRUCTION MANAGER PRIOR TO ORDERING / CONSTRUCTION.

LIGHTING LEGEND

- CUSTOM CAN - LED DOWNLIGHT [L]X7001
- CAN - LED ADJUSTABLE RECESSED - 3IN 75MM - BLACK - 800LM SPOT [L]21769
- CAN - LED ADJUSTABLE RECESSED - 3IN 75MM - BLACK - 800LM FLOOD [L]21771
- TRACK - LED FIXTURE WITH SNOOT - 3IN 75MM - BLACK - 1100LM SPOT [L]21777
- CAN - LED ADJUSTABLE RECESSED - 3IN 75MM - BLACK - 750LM WF [L]22246
- STRIP - LED TAPE IN HOUSING - VARIABLE LENGTH - BLACK - 350LM PER FT [L]22215

GENERAL NOTES

- A. IF REQUIRED BY LOCAL CODE, GENERAL CONTRACTOR TO PROVIDE SEMI-RECESSED SPRINKLER HEADS WITH POLISHED CHROME ESCUTCHEONS CENTERED IN ACOUSTICAL CEILING TILE. IF PENDANT HEADS ARE REQUIRED IN GWB SOFFIT OVER FRONTBAR, CONCEAL SUPPLY PIPING WITHIN SOFFIT. GENERAL CONTRACTOR TO SUBMIT SPRINKLER LAYOUT TO STARBUCKS' CONSTRUCTION MANAGER FOR APPROVAL PRIOR TO INSTALLATION.
- B. LEAVE TEN (10) ADDITIONAL RETAIL CEILING TILES TO MATCH RETAIL CEILING PAINT COLOR ABOVE THE WORKROOM CEILING AT MANAGER'S DESK FOR FUTURE USE.
- C. PROVIDE GROMMET AT ACOUSTIC CEILING PENETRATIONS FOR FIXTURES OF SUPPORTS.
- D. HEATING, VENTILATING AND AIR CONDITIONING SHOWN ON THIS PLAN PROVIDED FOR REFERENCE ONLY. SEE MECHANICAL DRAWINGS FOR ADDITIONAL INFORMATION.
- E. DIFFUSERS AND RETURNS IN ACOUSTICAL CEILING TILE TO BE CENTERED IN TILE AND PAINTED TO MATCH ADJACENT FINISHES (TYP.).
- F. PAINT ALL EXPOSED HVAC DUCTS, HVAC DIFFUSERS, LIGHT TRIM RINGS, PIPING, CONDUIT AND JUNCTION BOXES THE SAME COLOR AS SPECIFIED ON SURROUNDING CEILING OR SOFFIT UNLESS OTHERWISE NOTED. TYPICAL THROUGHOUT RETAIL AREA OF STORE.
- G. PAINT SUBSTITUTIONS ARE NOT ALLOWED. USE STARBUCKS' NATIONAL ACCOUNT "COLOR CODE" WHEN ORDERING PAINTS.


KEYED NOTES

1. INSTALL 2' X 2' ACT CEILING TILE LOCATED IN WORKROOM AND DT AREA AS INDICATED.
2. GYP. CEILING / SOFFIT WITH SMOOTH FINISH (PAINT AS SCHEDULED).
3. INSTALL 2' X 4' CIRRUS SECOND LOOK ACT LOCATED IN CAFE AS INDICATED (PAINT AS SCHEDULED).
4. INSTALL CEILING MOUNTED MOP SIGNAGE AS INDICATED.
5. INSTALL ROLLER SHADES AS INDICATED.
6. LINE OF SOFFIT / HEADER / BULKHEAD.
7. ALIGN FINISHED SURFACES.
8. LOCATIONS OF ALL EGRESS LIGHTING FOR REFERENCE ONLY. GC TO VERIFY WITH LOCAL FIRE MARSHAL PRIOR TO INSTALLATION.
9. REFER TO INTERIOR FINISH ELEVATIONS FOR MENU BOARD SPACING.
10. REFER TO SHEET A-105 FOR LIGHTING LOCATIONS AND INFORMATION.
11. INSTALL EXTERIOR SPEAKER AT 9' - 6" (2896 MM) A.F.F. MIN.
12. INSTALL RECESSED SPEAKERS AS INDICATED.
13. PLATFORM FOR HEATER AND WATER FILTRATION. PROVIDE SOFFIT AND LIFT CEILING THIS AREA ONLY TO ENSURE ADEQUATE CLEARANCE FOR SERVICING. ADJACENT CEILING COLOR.
14. LINE OF PASTRY CASE BELOW.
15. LOCATION OF ALL SWITCHING.
16. INSTALL SECURITY CAMERA AS INDICATED.
17. WIRELESS ACCESS POINT: LOCATE (2) PER STORE, ONE ABOVE POS, ONE NEAR MANAGER'S WORKSTATION.
18. PIR MOTION DETECTOR: MOTION DETECTORS ARE REQUIRED IN THE FOLLOWING LOCATIONS:
A. BEHIND BAR NEAR POINT OF SALE
B. CENTRALLY LOCATED IN CAFE
C. AT MANAGER'S WORKSTATION
D. CENTRALLY LOCATED IN BACK OF HOUSE
19. INSTALL NEW EXTERIOR CANOPY RECESSED CAN LIGHTS AS INDICATED.
20. EXTERIOR BUILDING SIGNAGE. SEE BUILDING EXTERIOR ELEVATIONS FOR ADDITIONAL INFORMATION.
21. EXTERIOR WALL SCONCES BY LL.
22. AWNING / CANOPY.
23. EXTERIOR CEILING FANS BY SB. J-BOX BY LL.
24. LINEAR DIFFUSER FOR REFERENCE ONLY. PAINT TO MATCH SW7037.
25. EXTERIOR SECURITY LIGHT BY LL.

NOTE:
REFER TO SHEET I-101.1 FOR FURNITURE AND DATA DEVICE SCHEDULES.

LEGEND

- ELEVATION DATUM
- TRACK LIGHTING
- STRIP LIGHTING
- RECESSED CAN LIGHT
- TROFFER
- RR SCONCE
- EXIT SECURITY LIGHT
- MUSIC SYSTEM SPEAKER
- MUSIC SYSTEM RECESSED SPEAKER
- WIFI ACCESS POINT (WAP)
- SECURITY CAMERA
- PIR MOTION SENSOR
- LINEAR DIFFUSER

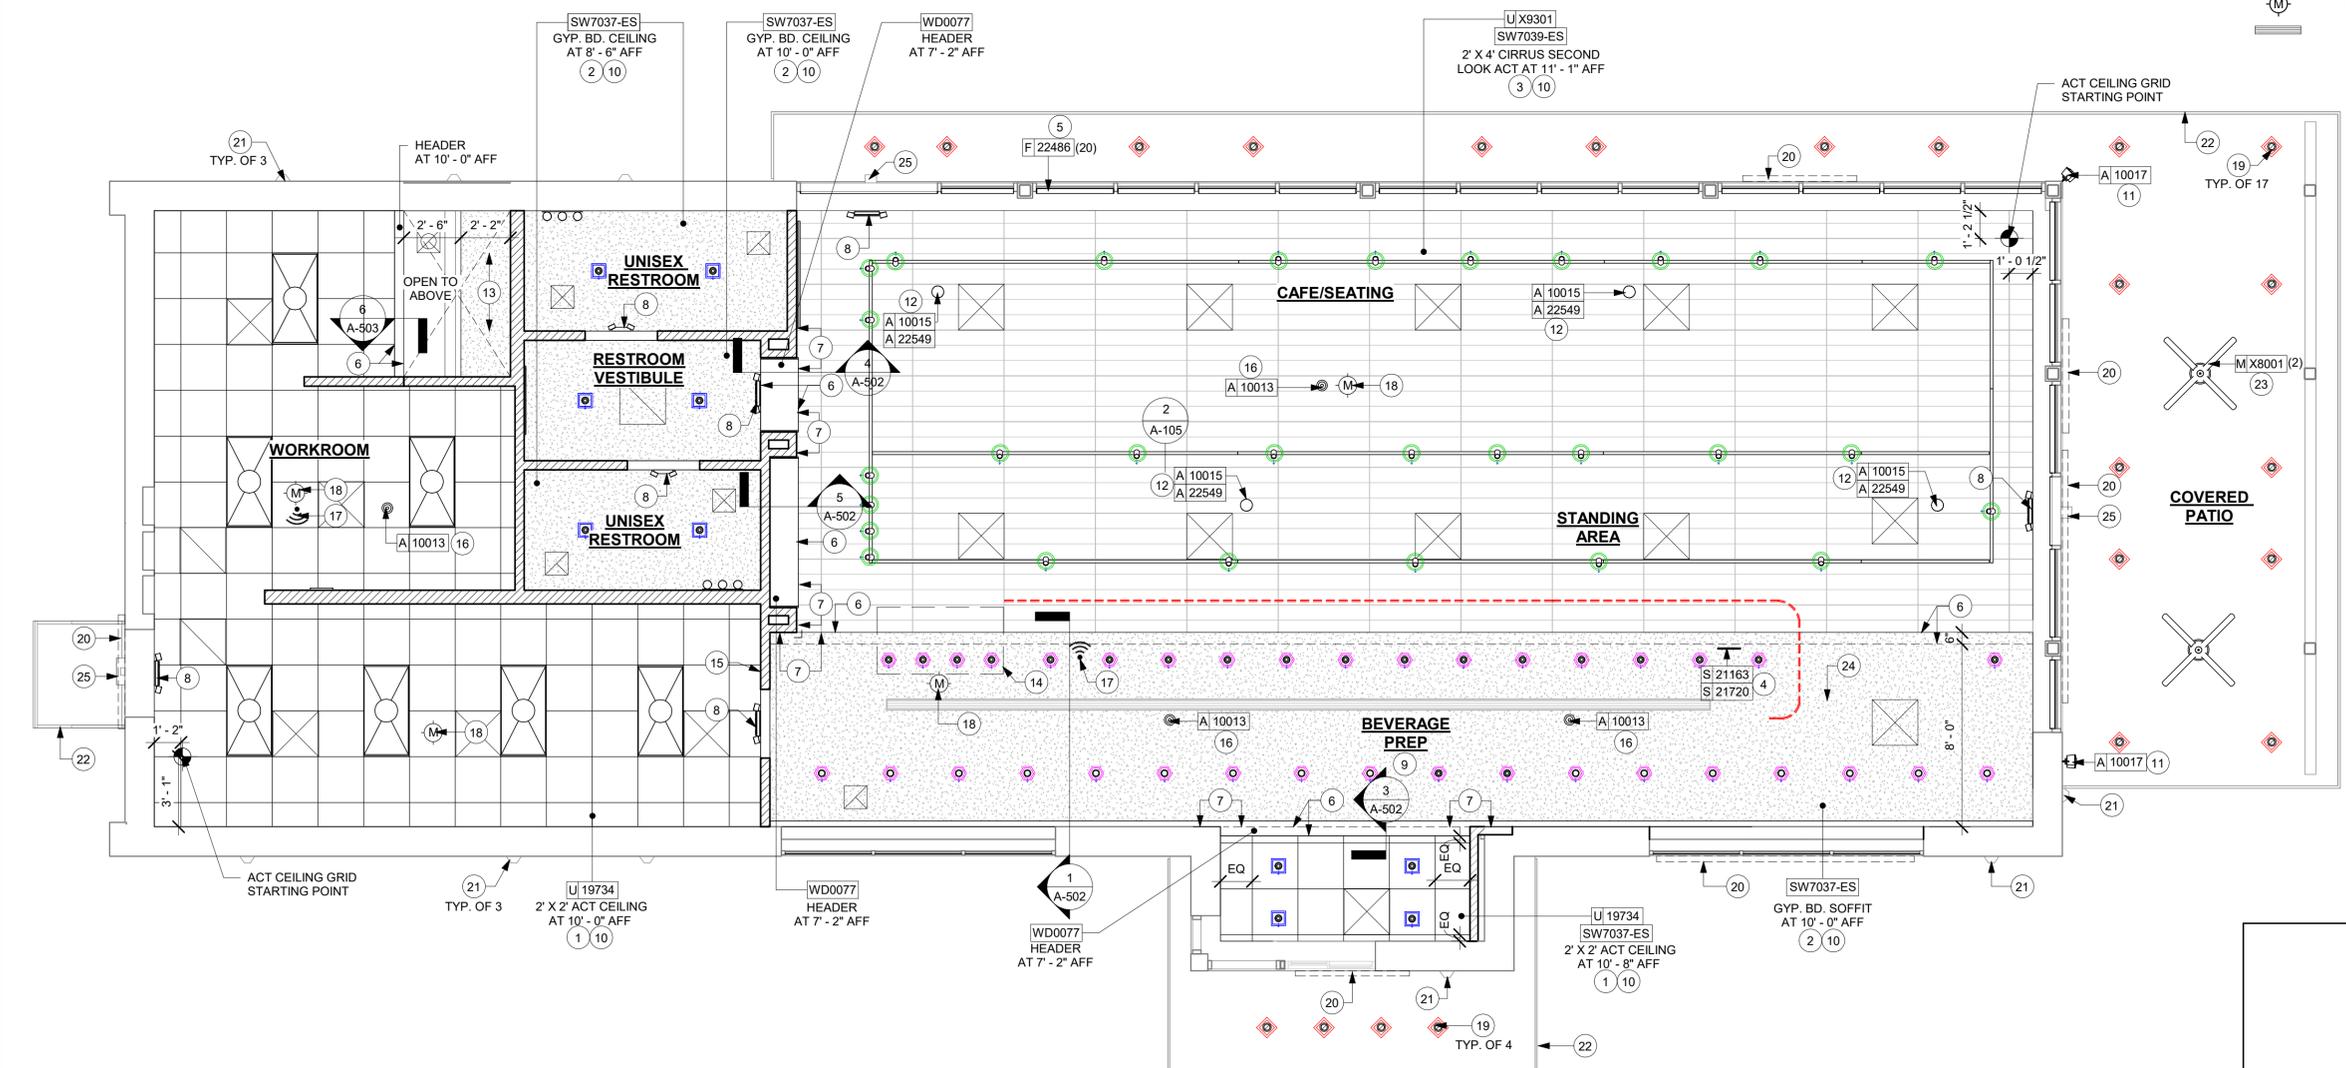

1 REFLECTED CEILING PLAN
Scale: 1/4" = 1'-0"



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FOR CONSTRUCTION

PROJECT NAME:
LECANTO HWY & NORVELL BRYANT

PROJECT ADDRESS:
**3159 W NORVELL BRYANT HWY
LECANTO, FL 34461**

STORE #: 78366
PROJECT #: 97107-001
ISSUE DATE: 09/06/2023
DESIGNER: RAI MONTERO
PRODUCTION DESIGNER: ANDY MCLLOUD
CHECKED BY: DONALD RETHMAN


Revision Schedule			
Rev	Date	By	Description

SHEET TITLE:
REFLECTED CEILING PLAN
SCALE: 1/4" = 1'-0"

SHEET NUMBER:
A-104

BLD202323715

LIGHTING FIXTURE SCHEDULE - "L"						
DESIGN ID	COUNT	DESCRIPTION	FURN. BY	INST. BY	BULB	COMMENTS
EXIT						
19044	2	LED EXIT SIGN WITH EMERGENCY LIGHT - WHITE AND RED	SB	GC	INTEGRATED LED	
19047	3	LED EXIT SIGN WITH EMERGENCY LIGHT - BLACK AND GREEN	SB	GC	INTEGRATED LED	
19057	2	LED EMERGENCY LIGHT DOUBLE - BLACK	SB	GC	INTEGRATED LED	
RECESSED CAN						
21769	36	CAN - LED ADJUSTABLE RECESSED - 3IN 75MM - BLACK - 800LM SPOT	SB	GC	INTEGRATED LED	
21771	10	CAN - LED ADJUSTABLE RECESSED - 3IN 75MM - BLACK - 800LM FLOOD	SB	GC	INTEGRATED LED	
X7001	22	CUSTOM CAN - LED ADJUSTABLE RECESSED	SB	GC		EXTERIOR CANOPY LIGHT
SCONCE						
20748	2	SCONCE - KUZCO PLUTO TRIPLE - CHROME	SB	GC	INTEGRATED LED	
STRIP						
22215	2	STRIP - LED TAPE IN HOUSING - VARIABLE LENGTH - BLACK - 350LM PER FT	SB	GC	INTEGRATED LED	FIELD TRIMMABLE TO 0.9 IN LENGTHS V.I.F (1) 24' - 0" (1) 17' - 10"
TRACK						
12947	2	TRACK - WITH CONNECTORS - 8FT 244CM - BLACK - 1 CIRCUIT	SB	GC		
12948	6	TRACK - WITH CONNECTORS - 16FT 488CM - BLACK - 1 CIRCUIT	SB	GC		ALL BAR / CAFE TRACK LIGHTING TO BE RUN THROUGH 1A / 2A CURRENT LIMITING DEVICE #RCLF12BL-TCL2BL; SEE ELECTRICAL DRAWINGS FOR ADDITIONAL INFORMATION
12949	3	TRACK - WITH CONNECTORS - 12FT 365CM - BLACK - 1 CIRCUIT	SB	GC		ALL BAR / CAFE TRACK LIGHTING TO BE RUN THROUGH 1A / 2A CURRENT LIMITING DEVICE #RCLF12BL-TCL2BL; SEE ELECTRICAL DRAWINGS FOR ADDITIONAL INFORMATION
15058	2	TRACK - WITH CONNECTORS - 6FT 183CM - BLACK - 1 CIRCUIT	SB	GC		
15059	3	TRACK - WITH CONNECTORS - 6FT 183CM - WHITE - 1 CIRCUIT	SB	GC		
21777	29	TRACK - LED FIXTURE WITH SNOOT - 3IN 75MM - BLACK - 1100LM SPOT	SB	GC	INTEGRATED LED	ALL BAR / CAFE TRACK LIGHTING TO BE RUN THROUGH 1A / 2A CURRENT LIMITING DEVICE #RCLF12BL-TCL2BL; SEE ELECTRICAL DRAWINGS FOR ADDITIONAL INFORMATION
TROFFER						
21783	7	TROFFER - LED RECESSED - 24X48IN 600X1200MM - WHITE - 4300LM	SB	GC	INTEGRATED LED	

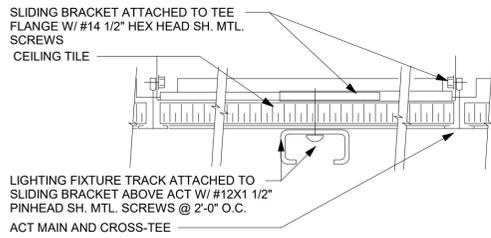

2 TRACK LIGHT - ACT MOUNT

Scale: 6" = 1'-0"

RESPONSIBILITY LEGEND

FURN. BY	INST. BY
SB - FURNISHED BY STARBUCKS	GC - INSTALLED BY GENERAL CONTRACTOR
GC - FURNISHED BY GENERAL CONTRACTOR	SB - INSTALLED BY STARBUCKS
VD - FURNISHED BY VENDOR	VD - INSTALLED BY VENDOR

NOTE:
ALL RESPONSIBILITIES TO BE CONFIRMED WITH STARBUCKS CONSTRUCTION MANAGER PRIOR TO ORDERING / CONSTRUCTION.

GENERAL NOTES


- WHERE ACOUSTICAL CEILING MEETS WALL, PROVIDE ANGLE WALL MouldING FOR REVEAL. MATCH CEILING GRID COLOR WHEN APPLICABLE.
- PAINT SUBSTITUTIONS ARE NOT ALLOWED. USE STARBUCKS' NATIONAL ACCOUNT "COLOR CODE" WHEN ORDERING PAINTS. SEE SHEET I-602 FOR PAINT SCHEDULES.
- ALL FIXTURES IN FOOD PREPARATION AREA SHALL HAVE SHATTERPROOF LAMPS IF THE FIXTURE IS NOT LENSED.
- PROVIDE GROMMET AT ALL CEILING PENETRATIONS FOR FIXTURES/SUPPORTS.
- ADJUST FOCUS OF ALL TRACK AND RECESSED DIRECTIONAL LIGHTING TO FULLY ILLUMINATE ALL ARTWORK, MENU BOARDS AND MERCHANDISE BAYS.
- IF PENDANT SUSPENDED LENGTH EXCEEDS 48" (1220MM) FROM CEILING, REPLACE WITH SURFACE-MOUNTED PENDANT AND SUSPEND WITH GC-SUPPLIED CONDUIT AND J-BOX TO DIMENSIONED HEIGHT.
- CENTER EMERGENCY/EXIT LIGHTS ABOVE DOORS, UON.

KEYED NOTES

- INSTALL NEW RECESSED CAN LIGHTS AT CENTER WHERE APPLICABLE.
- INSTALL SURFACE MOUNTED TRACK LIGHTING AS INDICATED.
- INSTALL LED STRIP LIGHT AT FRONTBAR COUNTER AS INDICATED.
- INSTALL RECESSED TROFFER LIGHTS AS INDICATED.
- MOUNT RESTROOM WALL SCONCE WITH CENTER OF J-BOX AT 6' - 8" AFF AS INDICATED ON RESTROOM ELEVATIONS.
- LOCATIONS OF ALL EGRESS LIGHTING FOR REFERENCE ONLY. GC TO VERIFY WITH LOCAL FIRE MARSHAL PRIOR TO INSTALLATION.
- INSTALL CEILING MOUNTED MOP SIGNAGE AS INDICATED.
- EXTERIOR WALL SCONCES BY LL.
- INSTALL NEW EXTERIOR CANOPY RECESSED CAN LIGHTS AS INDICATED.
- EXTERIOR CEILING FANS BY SB. J-BOX BY LL.
- EXTERIOR SECURITY LIGHT BY LL.

LIGHTING LEGEND

	CUSTOM CAN - LED DOWNLIGHT	L X7001
	CAN - LED ADJUSTABLE RECESSED - 3IN 75MM - BLACK - 800LM SPOT	L 21769
	CAN - LED ADJUSTABLE RECESSED - 3IN 75MM - BLACK - 800LM FLOOD	L 21771
	TRACK - LED FIXTURE WITH SNOOT - 3IN 75MM - BLACK - 1100LM SPOT	L 21777
	CAN - LED ADJUSTABLE RECESSED - 3IN 75MM - BLACK - 1100LM SPOT	L 22246
	STRIP - LED TAPE IN HOUSING - VARIABLE LENGTH - BLACK - 350LM PER FT	L 22215

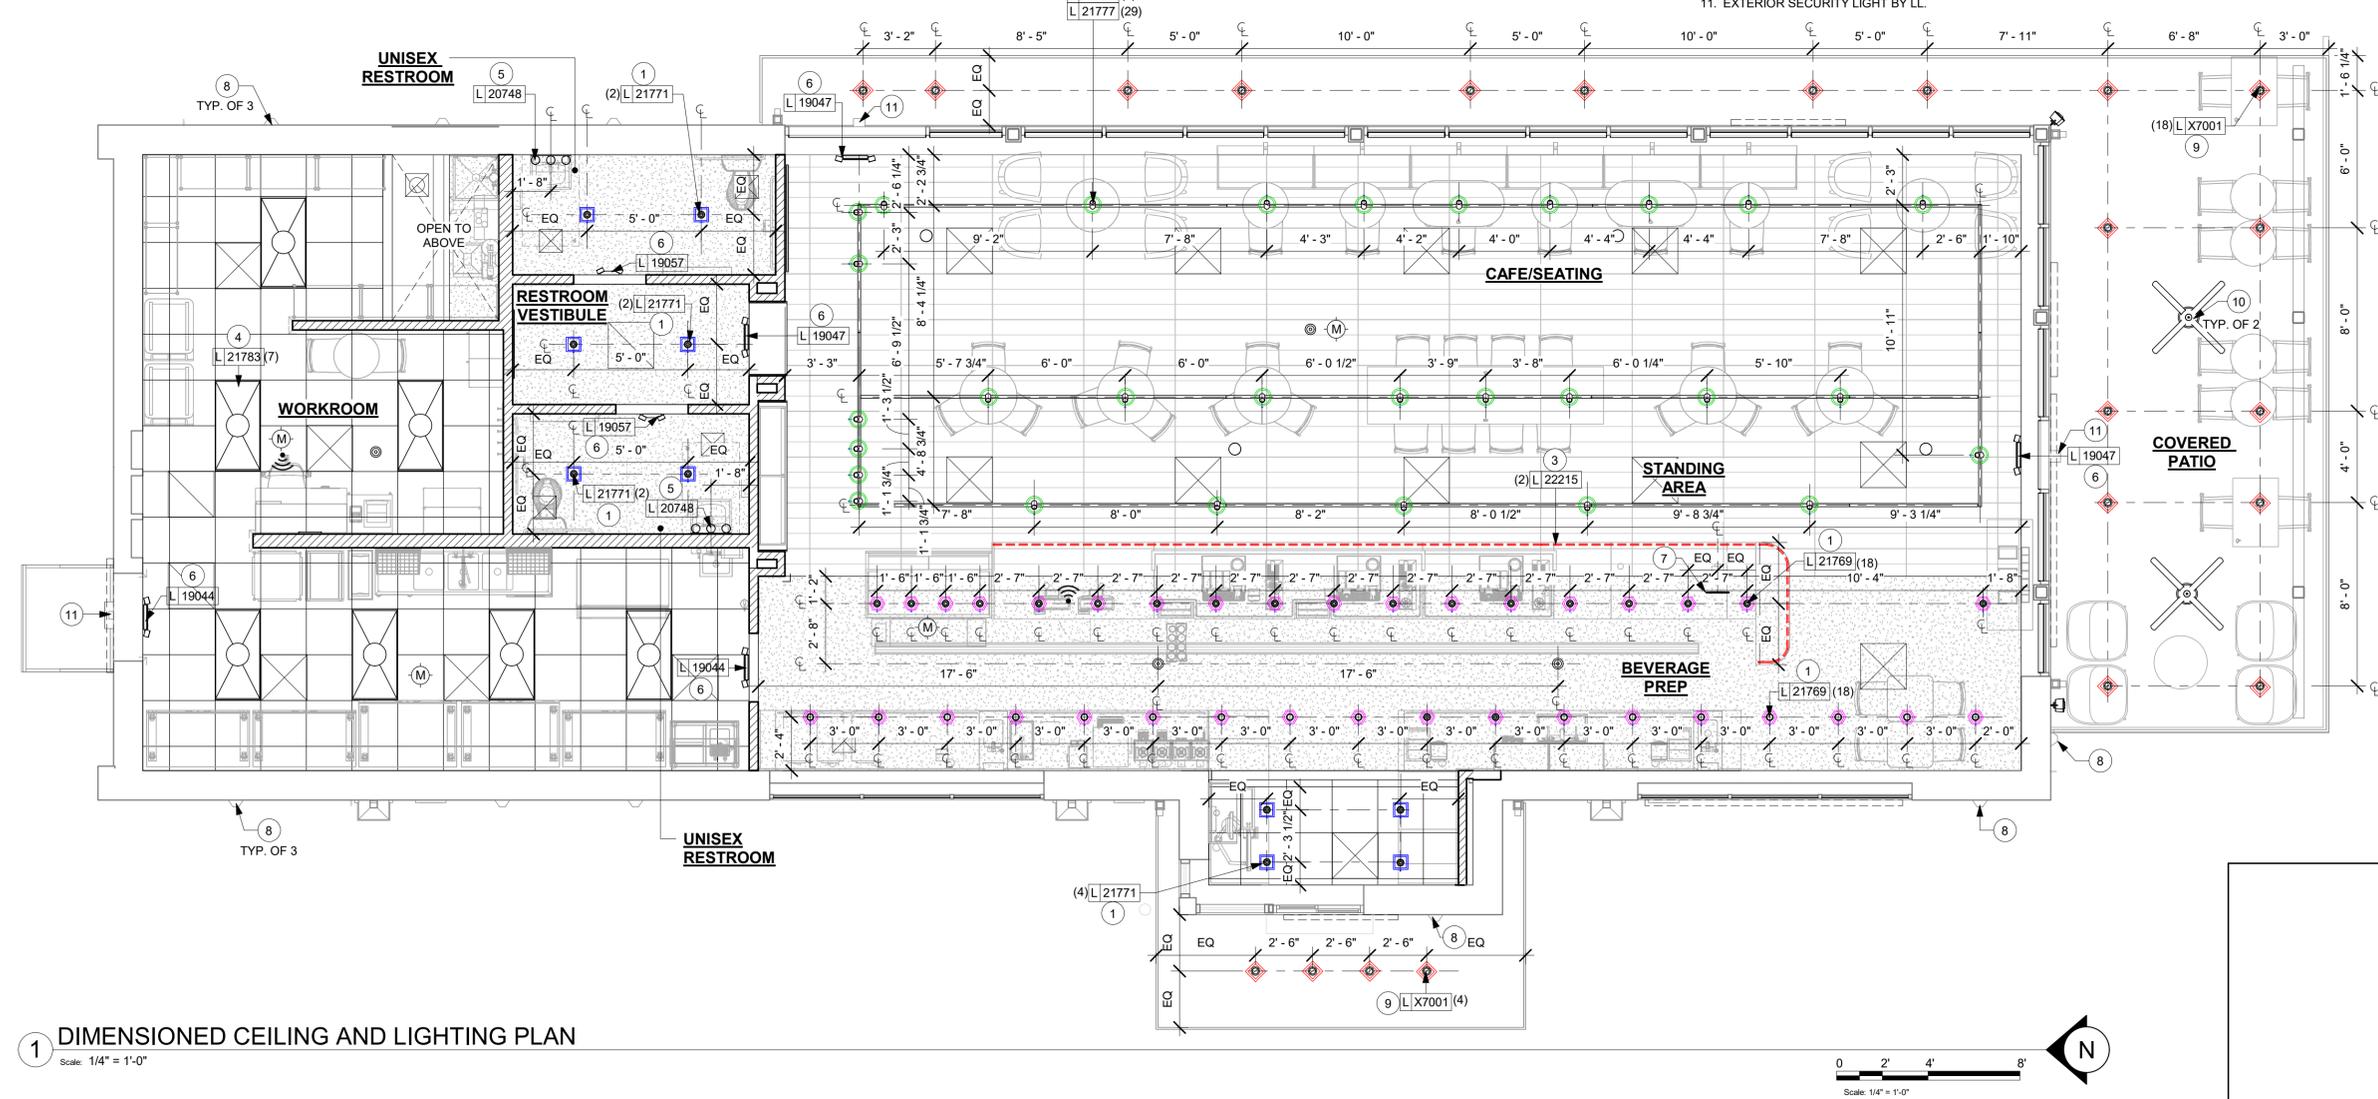

1 DIMENSIONED CEILING AND LIGHTING PLAN

Scale: 1/4" = 1'-0"



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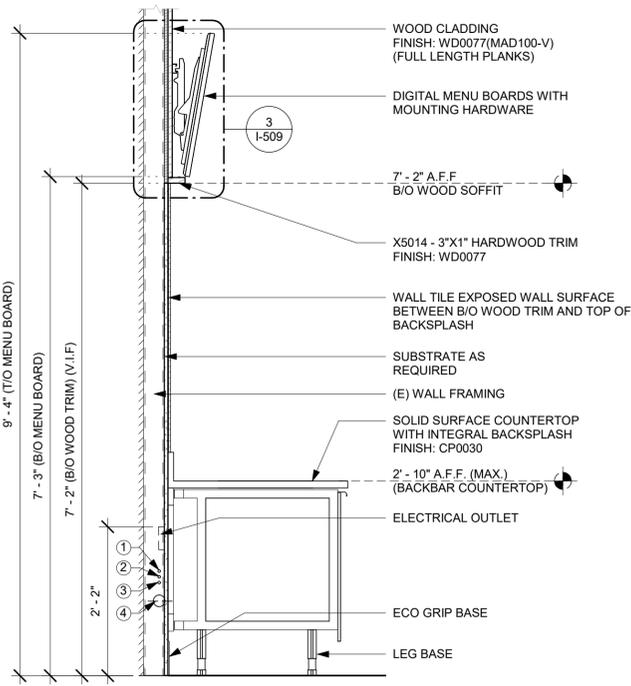
Revision Schedule			
Rev	Date	By	Description

SHEET TITLE:
DIMENSIONED CEILING AND LIGHTING PLAN
SCALE: AS SHOWN

SHEET NUMBER:
A-105

BLD202323715


C:\Users\kallejennings\Documents\97107-001_78366_LECANTO HWY & NORVELL BRYANT, FL_2021_kallejennings.rvt 9/6/2023 11:13:49 AM



- NOTES:
- 1 1'-7" AFF (CW SUPPLY)
 - 2 1'-6" AFF (CWF SUPPLY)
 - 3 1'-5" AFF (HW SUPPLY)
 - 4 VARIES: 1/4" PER FOOT FALL (ABS 2" WASTE LINE)

1 WALL SECTION AT BACKBAR


Scale: 3/4" = 1'-0"

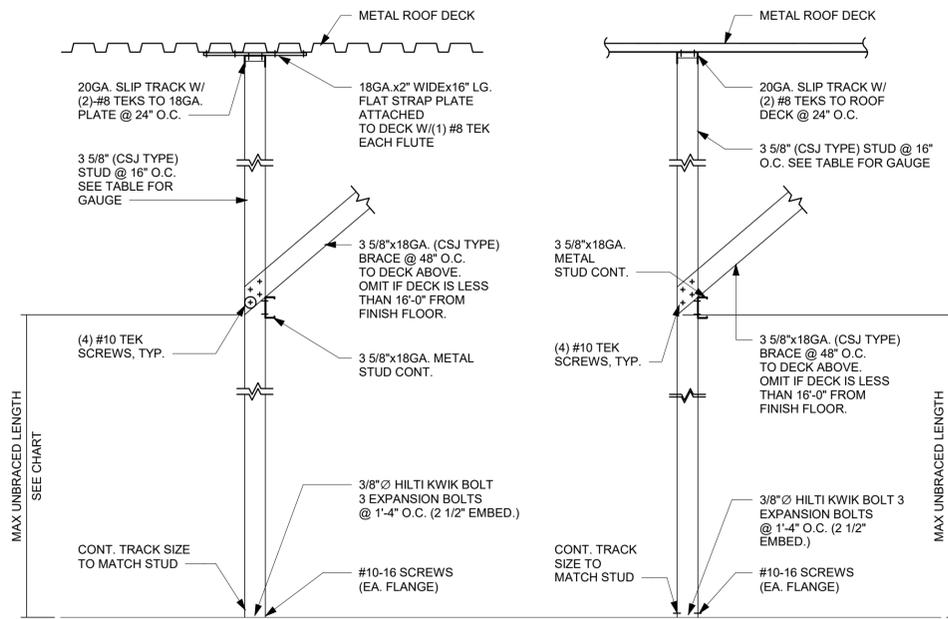

PARALLEL TO ROOF DECK FLUTE DIRECTION PERPENDICULAR TO ROOF DECK FLUTE DIRECTION


2 NEW PARTITION WALL TO STRUCTURE

Scale: 3/4" = 1'-0"

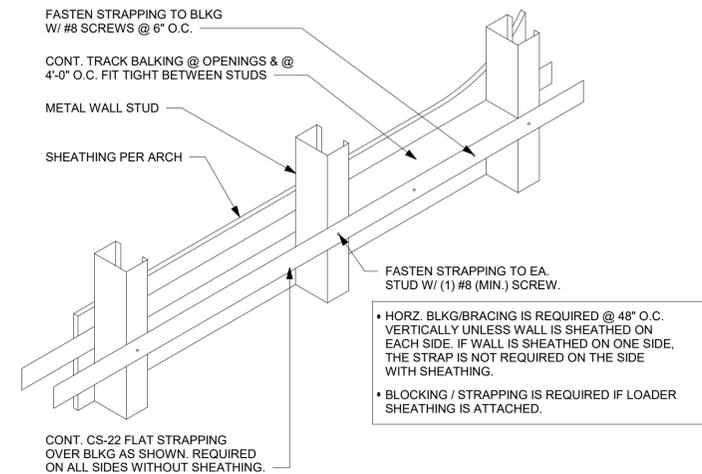

3 TYPICAL WALL BLOCKING BRACING

Scale: 3/4" = 1'-0"

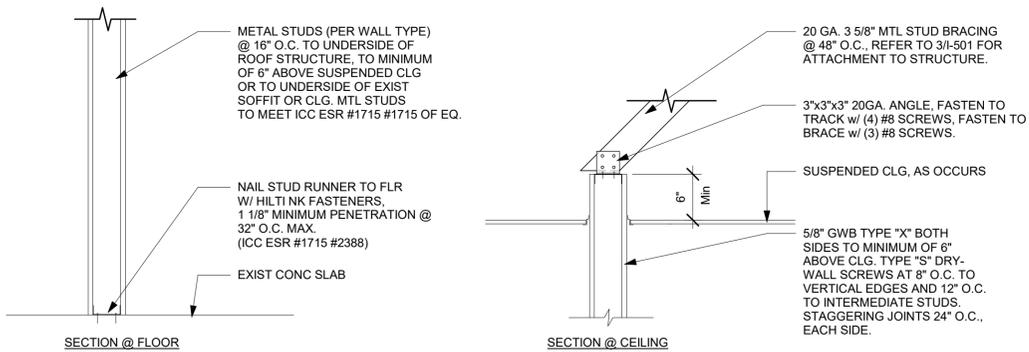


4 NEW PARTITION WALL 6" ABOVE CEILING

Scale: 1" = 1'-0"

PARTITION WALL SCHEDULE					
WALL HEIGHT	STUD SIZE	DEF TRACK	DEF TRACK SPANNING BTWN (E) JOISTS	BOT TRACK	
15 FEET	362S137-33	33 MIL	JST @ 4' O.C. 54 MIL JST @ 6' O.C. 68 MIL	33 MIL	
20 FEET	550S162-33	33 MIL	JST @ 4' O.C. 68 MIL JST @ 6' O.C. 97 MIL	33 MIL	
25 FEET	600S200-43	43 MIL	JST @ 4' O.C. 68 MIL JST @ 6' O.C. 97 MIL	33 MIL	

5 PARTITION WALL SCHEDULE

Scale: 3/4" = 1'-0"

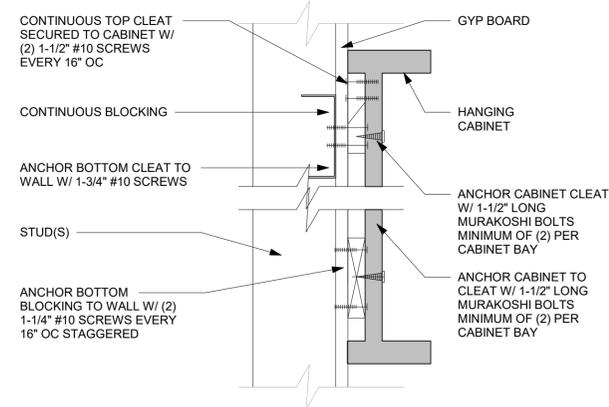


6 ANCHOR DETAIL

Scale: 3" = 1'-0"

WALL TYPE FASTENER SCHEDULE			
WALL TYPE	WALL BLOCKING	FASTENERS	NOTES
WOOD FRAME	X	#8 X3" (75MM) W/D OR EQUIVALENT	REFER TO BLOCKING REQUIREMENTS
METAL FRAME	X	#6CT. X1 1/4" (32MM) MTL W/D OR EQUIVALENT	REFER TO BLOCKING REQUIREMENTS
CMU		MIN. 5/16"x3" (8MMx75MM) TAPCON OR EQUIVALENT	SPACE PER DETAIL THIS SHEET
CONCRETE		MIN. 1/4"x3" (7MMx75MM) SLEEVE ANCHOR OR EQUIVALENT	SPACE PER DETAIL THIS SHEET
BRICK		MIN. 1/4"x1" (7MMx25MM) WEDGE ANCHOR OR EQUIVALENT	SPACE PER DETAIL THIS SHEET AVOID SETTING ANCHORS IN MORTAR JOINTS


STUD WALL BLOCKING REQUIREMENTS:
WOOD STUD WALLS REQUIRE MIN. 2"x6" (50MMx150MM) WOOD BLOCKING SECURED FLUSH TO STUD FACE WITH (3) 10D NAILS (OR EQUIVALENT)

METAL STUD WALLS REQUIRE MIN. 2"x6" (50MMx150MM) WOOD BLOCKING SECURED FLUSH TO STUD FACE WITH MIN. (3) #6 CT. 1.25" (30MM) SCREWS (OR EQUIVALENT)

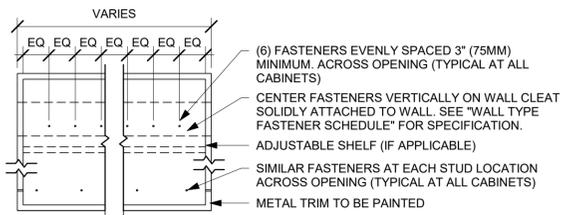

7 UPPER CABINET ATTACHMENT

Scale: 1" = 1'-0"

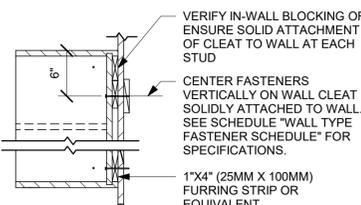

8 DIEWALL SECTION AT FRONT BAR

Scale: 1" = 1'-0"



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ISSUE DATE: 09/06/2023
DESIGNER: RAI MONTERO
PRODUCTION DESIGNER: ANDY MCLCROD
CHECKED BY: DONALD RETHMAN

Revision Schedule			
Rev	Date	By	Description

SHEET TITLE:
BUILDING DETAILS

SCALE: AS SHOWN

SHEET NUMBER:

A-501

BLD202323715



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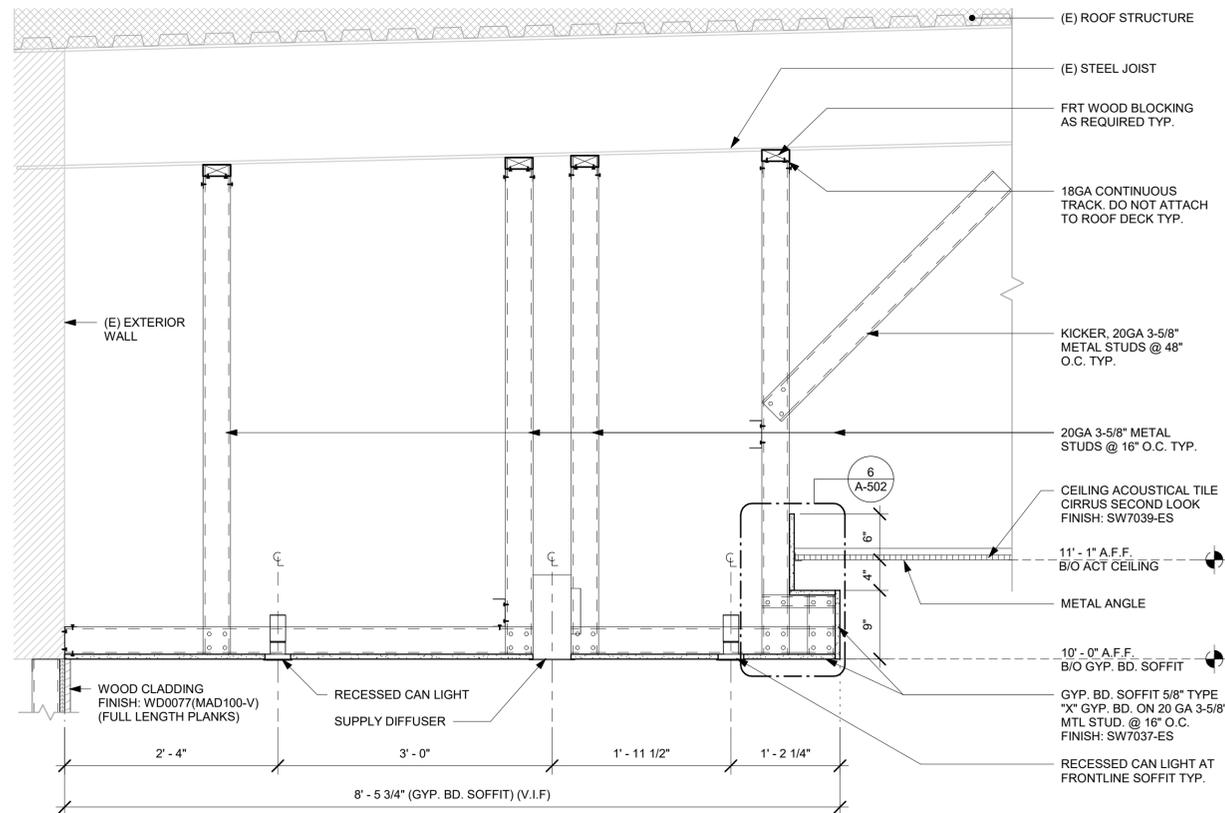
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Rev	Date	By	Description


SHEET TITLE:
BUILDING DETAILS

SCALE: AS SHOWN


SHEET NUMBER:
A-502




2 SOFFIT CONSTRUCTION
Scale: 1" = 1'-0"

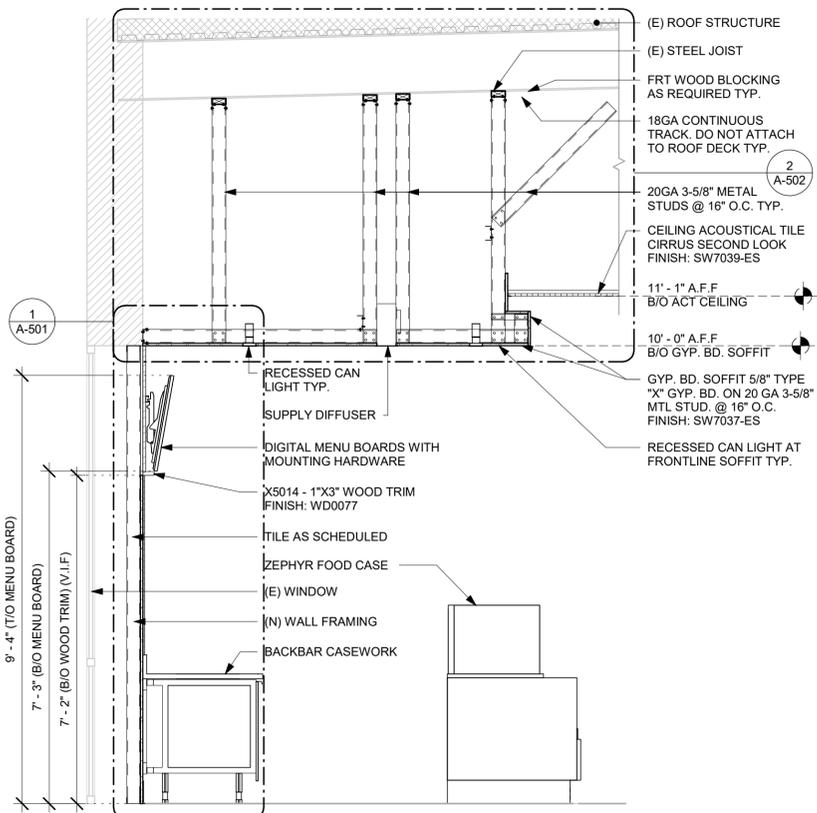


1 BACKBAR SECTION
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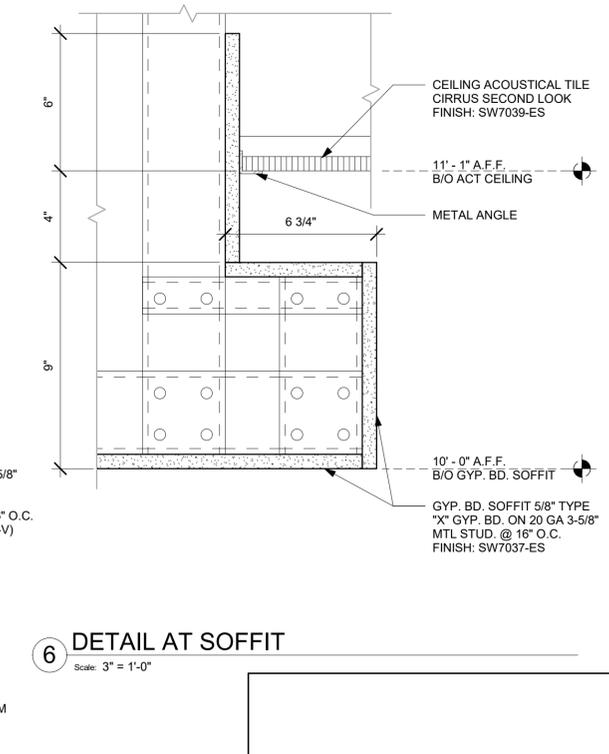
3 HEADER AT DT AREA
Scale: 1 1/2" = 1'-0"

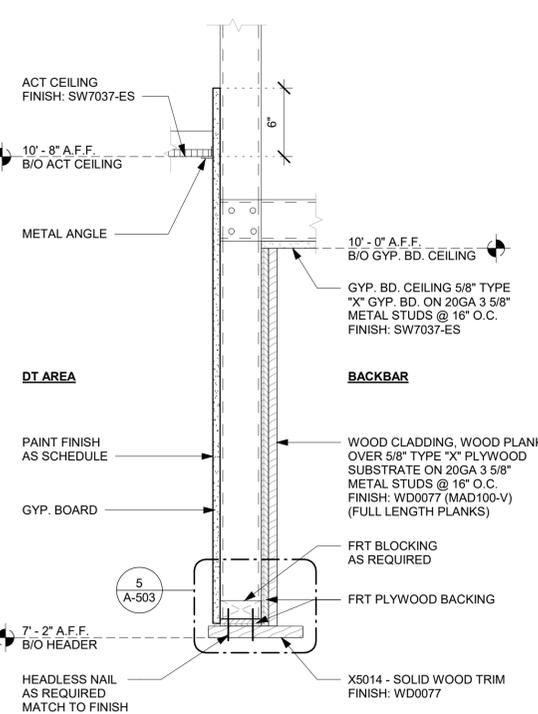

4 HEADER AT RR VESTIBULE
Scale: 1 1/2" = 1'-0"

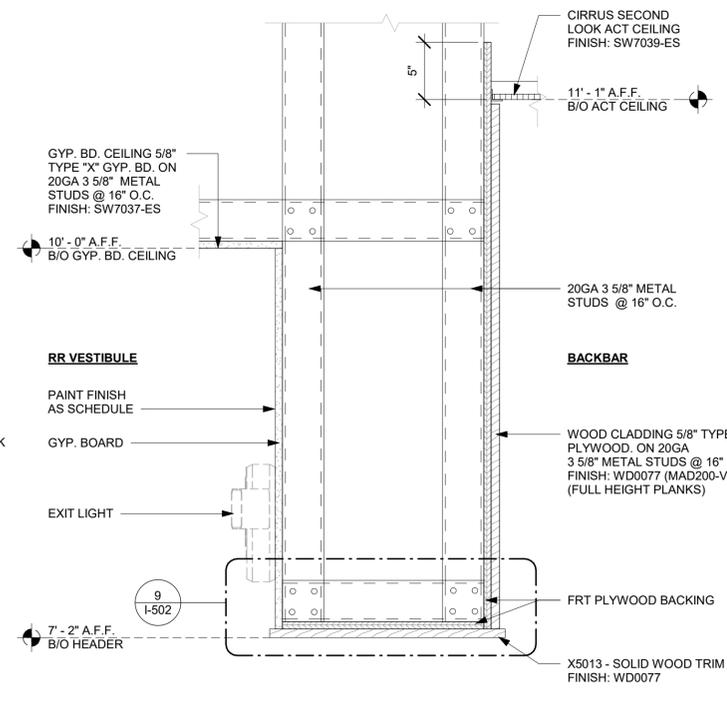

5 HEADER AT MERCH
Scale: 1 1/2" = 1'-0"

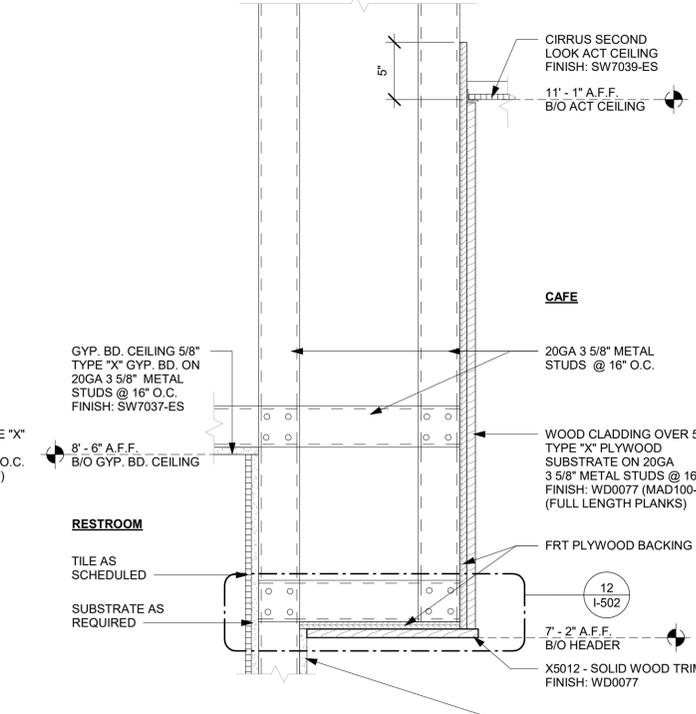


6 DETAIL AT SOFFIT
Scale: 3" = 1'-0"

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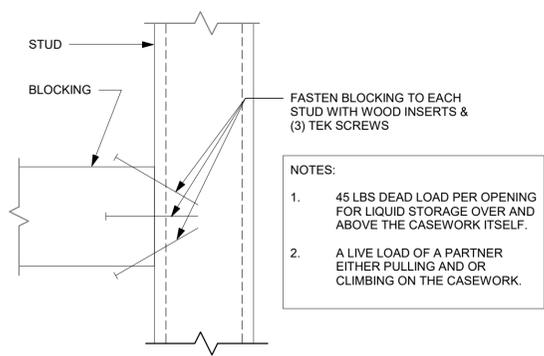
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NOTES:
 1. 45 LBS DEAD LOAD PER OPENING FOR LIQUID STORAGE OVER AND ABOVE THE CASEWORK ITSELF.
 2. A LIVE LOAD OF A PARTNER EITHER PULLING AND OR CLIMBING ON THE CASEWORK.

1 BLOCKING AT CASEWORK


Scale: 1/2" = 1'-0"

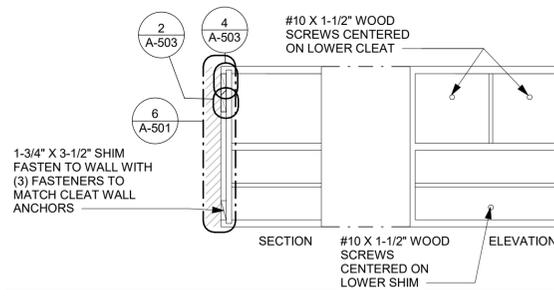

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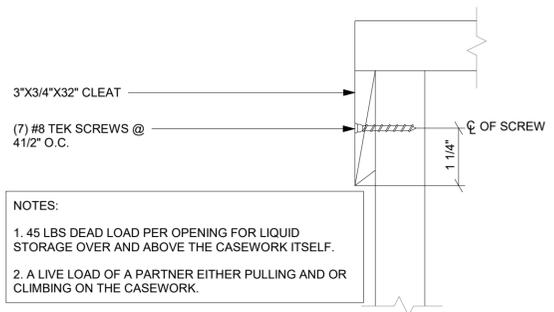
2 BLOCKING TO METAL STUD

Scale: 1/2" = 1'-0"

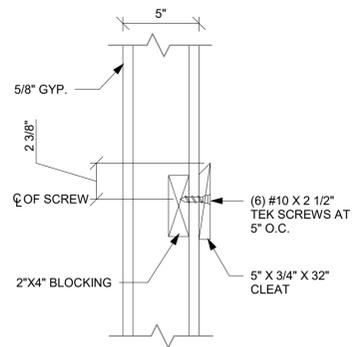

3 CLEAT TO WOOD BLOCKING


Scale: 1/2" = 1'-0"



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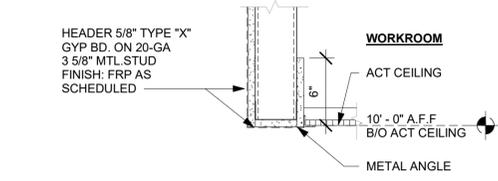
4 CLEAT TO FRAME

Scale: 1/2" = 1'-0"

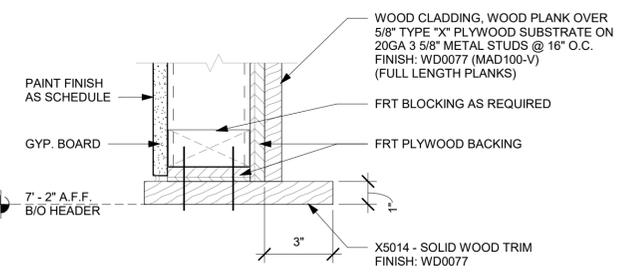


5 FINISH EDGE AT DT AREA

Scale: 3" = 1'-0"



6 HEADER AT WATER FILTERATION

Scale: 1 1/2" = 1'-0"

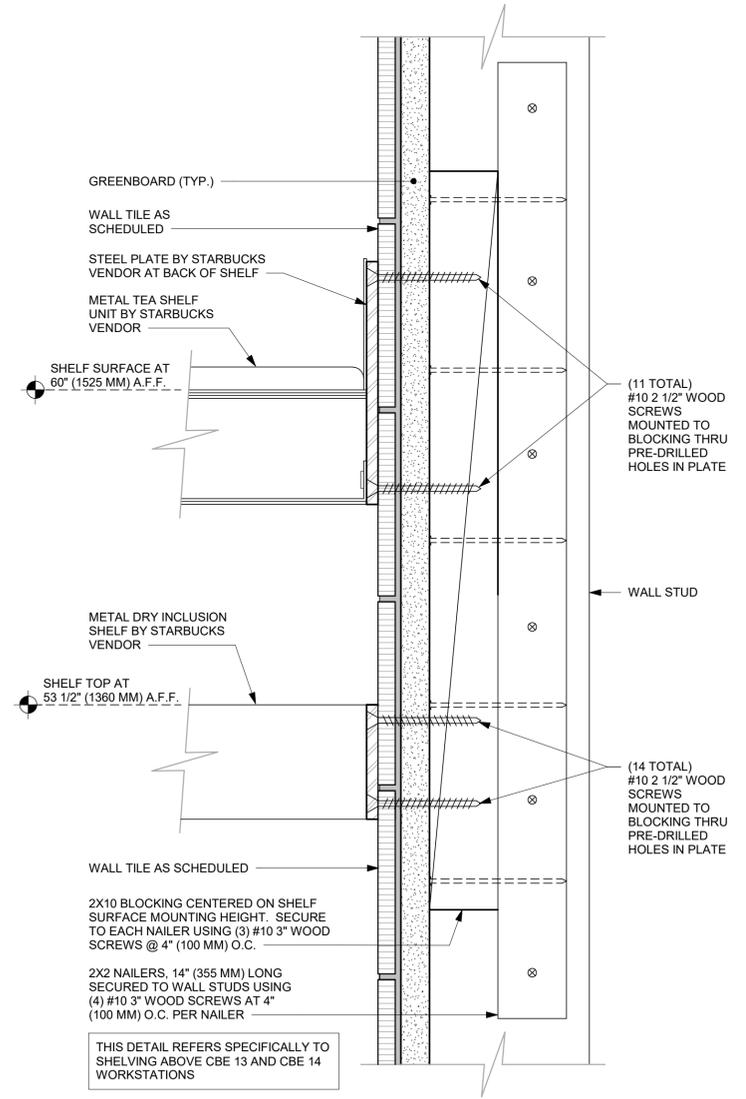

7 METAL TEA AND DRY INCLUSION SHELF WOOD WALL ATTACHMENT

Scale: 6" = 1'-0"



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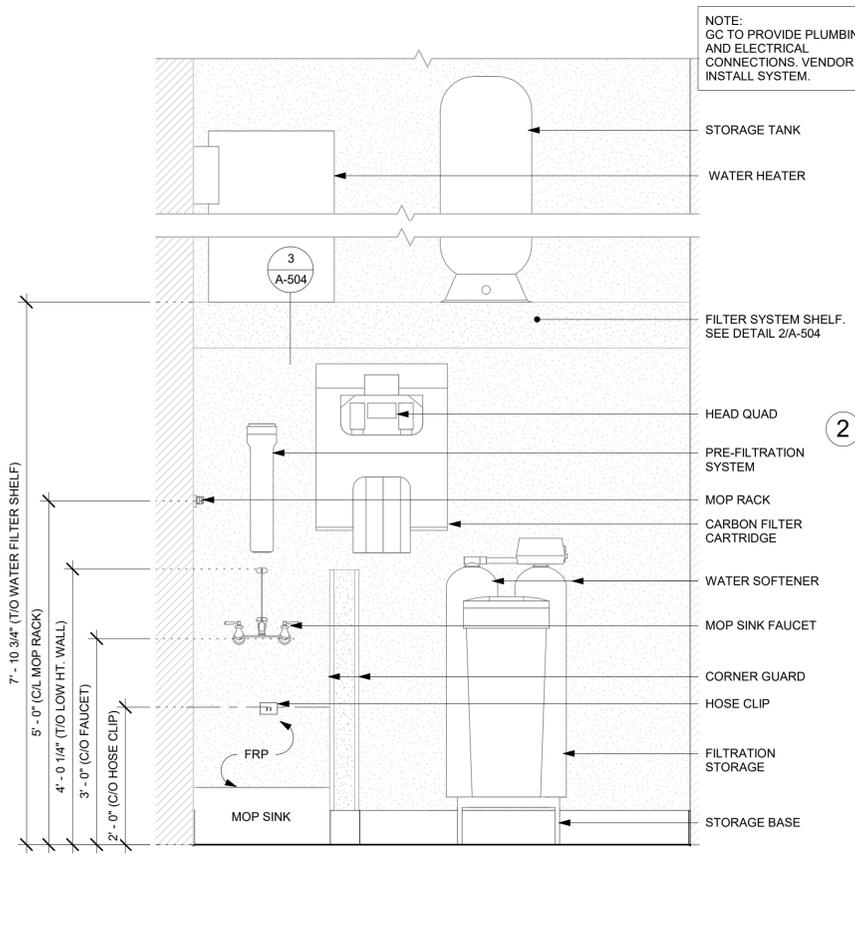
SHEET TITLE:
BUILDING DETAILS

SCALE: AS SHOWN


SHEET NUMBER:
A-503

BLD202323715


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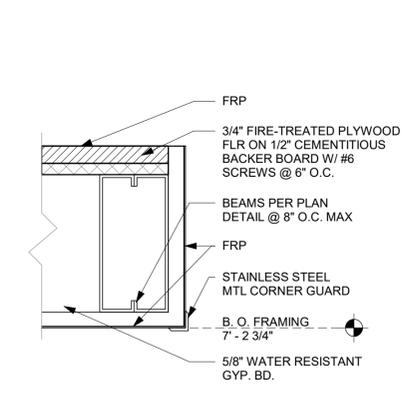
1 WATER SYSTEM ELEVATION
Scale: 3/4" = 1'-0"




2 FILTER SYSTEM SHELF PLAN
Scale: 1/2" = 1'-0"

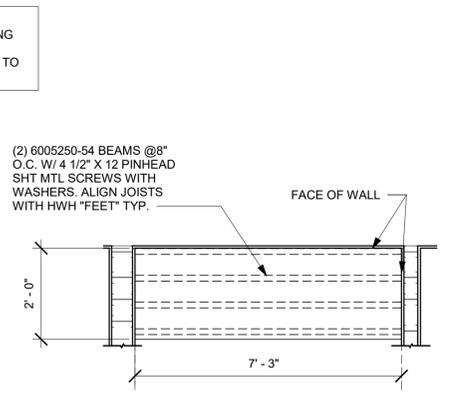


3 FILTER SYSTEM SHELF SECTION
Scale: 1/2" = 1'-0"

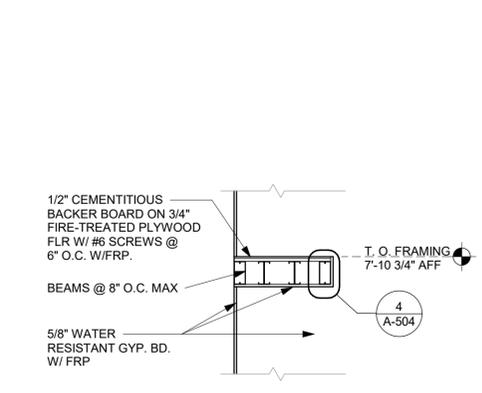


4 FILTER SYSTEM SHELF EDGE
Scale: 3" = 1'-0"

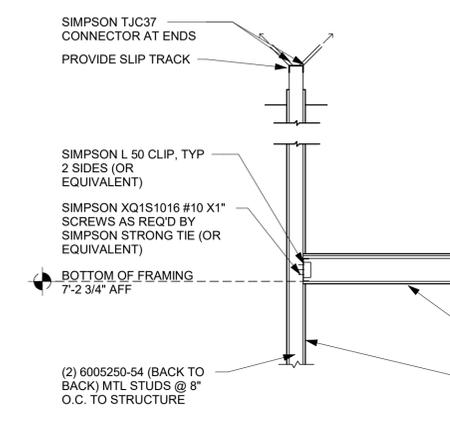


5 FILTER SYSTEM SHELF ELEVATION
Scale: 1/2" = 1'-0"

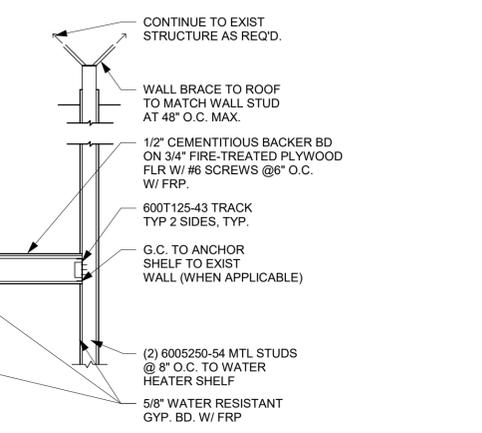


6 FILTER SYSTEM SHELF ANGLE SUPPORT DETAIL
Scale: 1 1/2" = 1'-0"

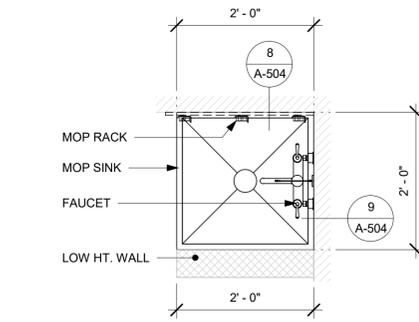


7 MOP SINK - PLAN
Scale: 3/4" = 1'-0"

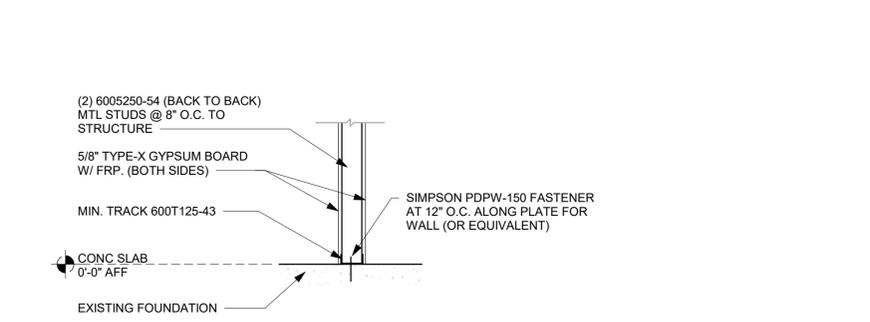


8 FILTER SYSTEM SHELF CONNECTION AT FOUNDATION
Scale: 3/4" = 1'-0"

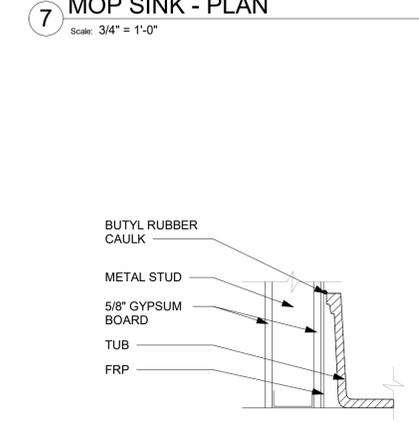

9 FRP AT MOP SINK
Scale: 1 1/2" = 1'-0"

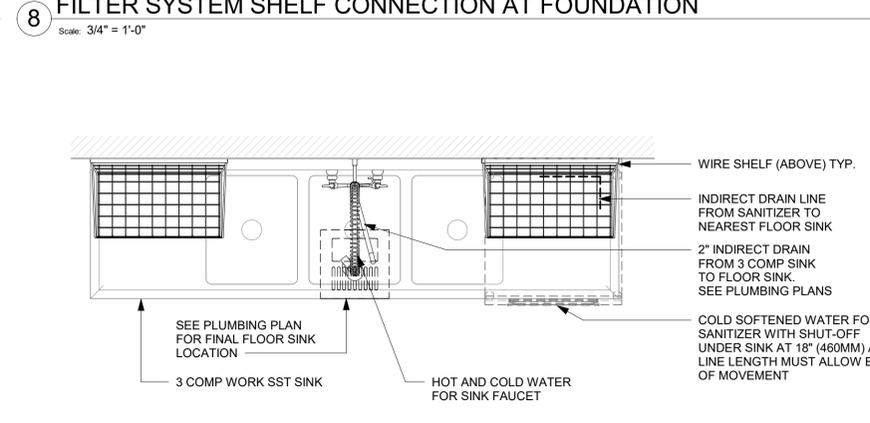

10 3-COMP PLAN - SANITIZER(UNDER)
Scale: 3/4" = 1'-0"

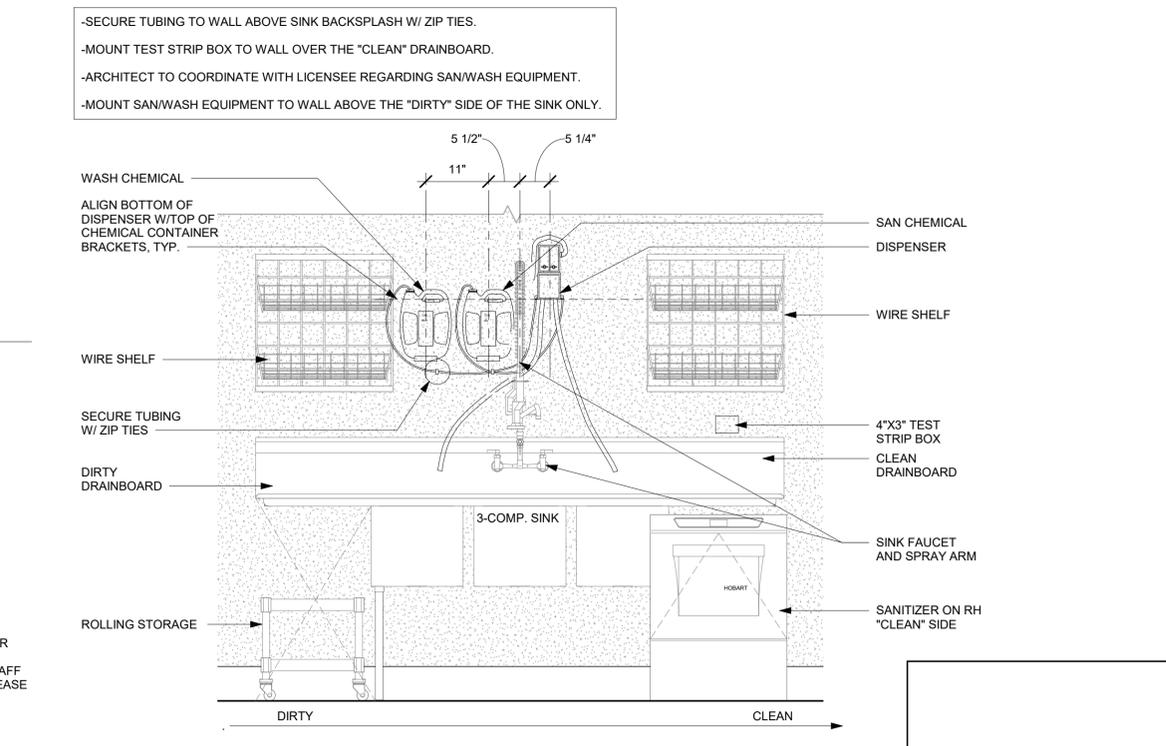

11 CLICK SAN/WASH INSTALL (SANITIZER BELOW)
Scale: 3/4" = 1'-0"

NOTE:
GC TO PROVIDE PLUMBING
AND ELECTRICAL
CONNECTIONS. VENDOR TO
INSTALL SYSTEM.

NOTES TO CONTRACTOR:
1. PRE DRILL HOLES THROUGH S.S. ANGLE TO PREVENT DAMAGE TO SCREWS.
2. TEK SCREWS OR EQUIVALENT TO BE USED.
3. ANGLE TO BE CONTINUOUS (NO SPLICES)

-SECURE TUBING TO WALL ABOVE SINK BACKSPLASH W/ ZIP TIES.
-MOUNT TEST STRIP BOX TO WALL OVER THE "CLEAN" DRAINBOARD.
-ARCHITECT TO COORDINATE WITH LICENSEE REGARDING SAN/WASH EQUIPMENT.
-MOUNT SAN/WASH EQUIPMENT TO WALL ABOVE THE "DIRTY" SIDE OF THE SINK ONLY.



STARBUCKS
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SEATTLE, WASHINGTON 98134
(206) 318-1575

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License: AR0017303

Design Forum Engineering

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Timothy L. Raberding, PE
Professional Engineer
License: 62078



FOR CONSTRUCTION

PROJECT NAME:
LECANTO HWY & NORVELL BRYANT

PROJECT ADDRESS:
**3159 W NORVELL BRYANT HWY
LECANTO, FL 34461**

STORE #: 78366
PROJECT #: 97107-001
ISSUE DATE: 09/06/2023
DESIGNER: RAI MONTERO
PRODUCTION DESIGNER: ANDY MCLLOUD
CHECKED BY: DONALD RETHMAN

Revision Schedule			
Rev	Date	By	Description


SHEET TITLE:
WORKROOM DETAILS

SCALE: AS SHOWN


SHEET NUMBER:
A-504

BLD202323715


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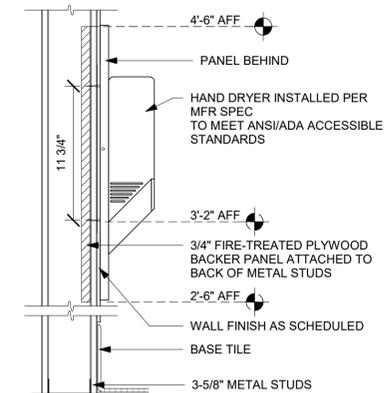
1 WALL TILE PATTERN AT RESTROOM
 Scale: 1/2" = 1'-0"

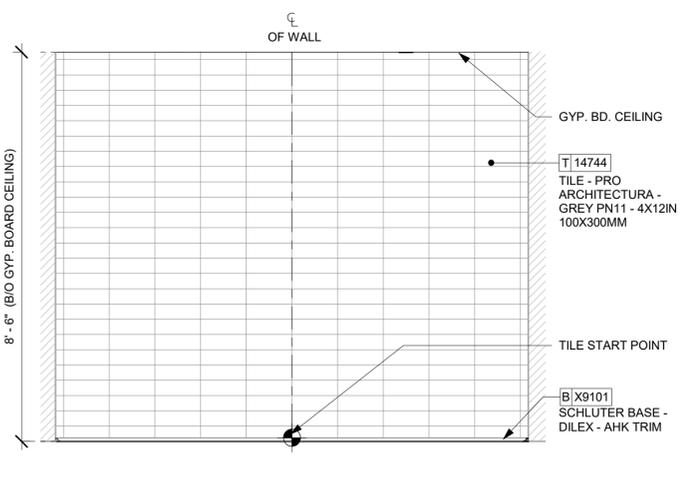


2 WALL MOUNTED BABY CHANGING EQUIPMENT DETAILS
 Scale: 3/4" = 1'-0"

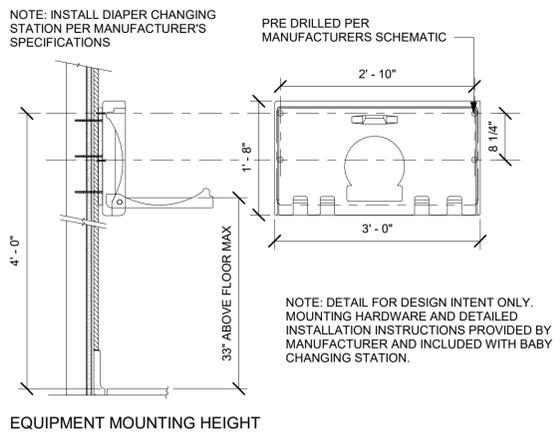


DIAPER CHANGING DETAIL

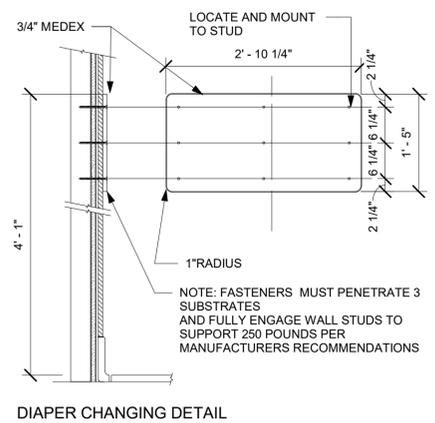


3 HAND DRYER BLOCKING
 Scale: 1 1/2" = 1'-0"

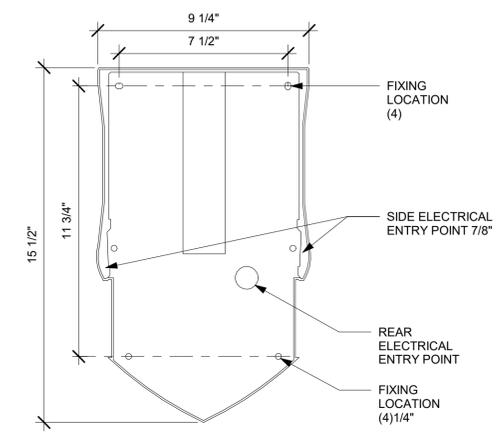


4 HAND DRYER SECTION
 Scale: 3" = 1'-0"

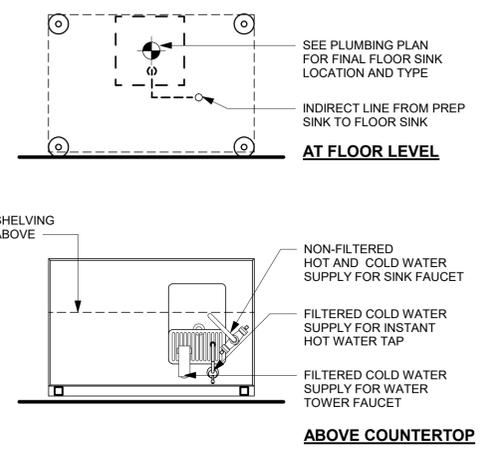


5 WATER FILLING STATION - PLUMBING
 Scale: 3/4" = 1'-0"

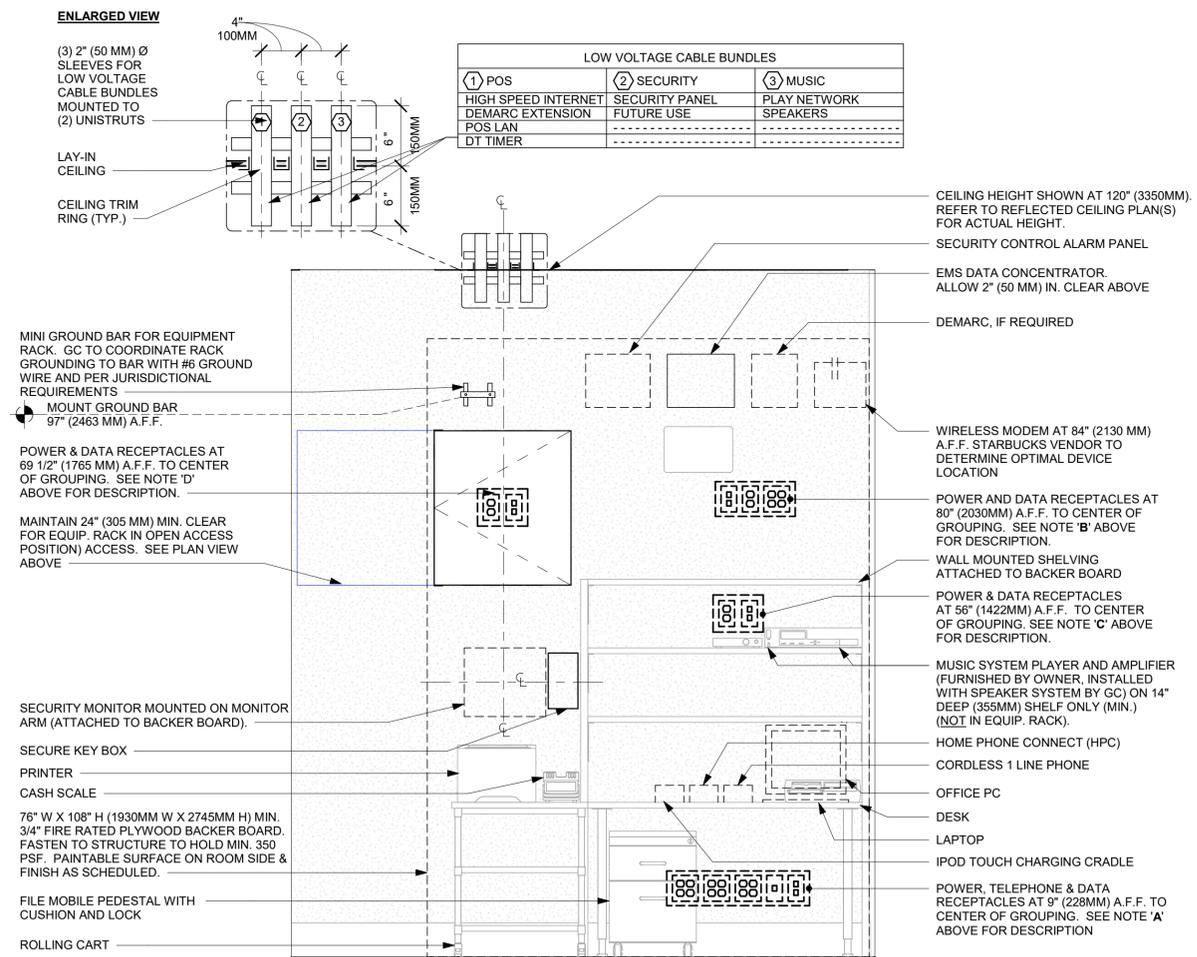

8 MANAGER WORKROOM - ELECTRICAL
 Scale: 3/4" = 1'-0"

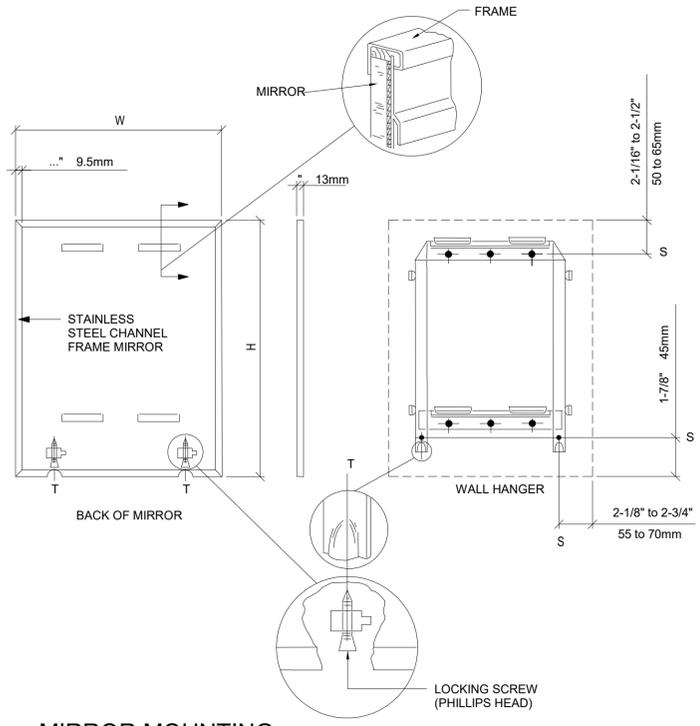

6 MIRROR MOUNTING
 Scale: 3/4" = 1'-0"

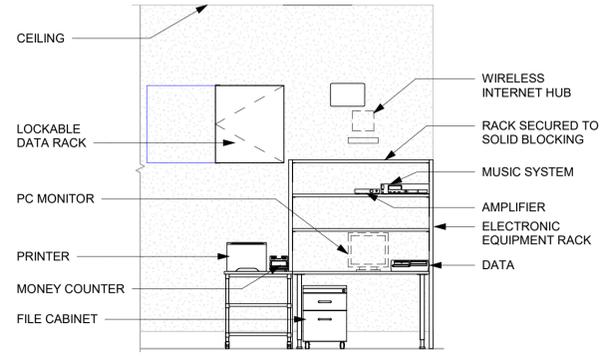

7 MANAGER DESK (DETAIL FOR INSTALLATION)
 Scale: 3/8" = 1'-0"



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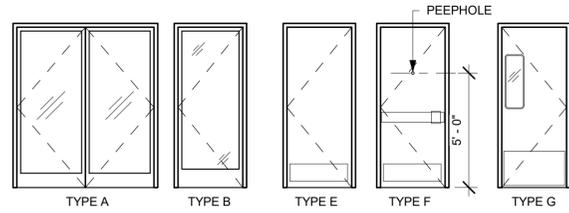
Revision Schedule			
Rev	Date	By	Description

SHEET TITLE:
RESTROOM AND WORKROOM DETAILS
 SCALE: AS SHOWN

SHEET NUMBER:
A-505

BLD202323715

INTERIOR DOOR LEGEND



STOREFRONT DOOR (TYPE A)

DOOR HARDWARE SET NO. 3-A - For pair aluminum main entry/exit doors (300 or less occupancy)				
No.	Item	Description	Manufacturer	Finish
6	Hanging Devices	TH2314/MPB91	McKinney	630
1	Securing Devices (active leaf)	MS1850S Deadbolt	Adams Rite	626
1	Securing Devices (inactive...)	MS1880 Two-Point Flushbolt	Adams Rite	626
2	Securing Devices (active leaf)	C607 7-Pin Core Combined "A" Keyway	Falcon Lock	626
1	Securing Devices (active leaf)	KB609-2 Cut Control Key "A" Keyway	Falcon Lock	---
9	Securing Devices (active leaf)	KB632-2 Cut User Key "A" Keyway	Falcon Lock	---
2	Securing Devices (active leaf)	C987 7-Pin Mortise Cylinder Housing w/AR Cam	Falcon Lock	626
2	Securing Devices (active leaf)	A08794-003 Adjustable Ring, Mortise Cyl. 5/16-13/32	Falcon Lock	626
2	Operating Trim	108 Door Pull Handle	Rockwood	630
2	Operating Trim	48 Push Bar x 31	Rockwood	630
2	Closing Devices	8916 Door Closer 8916 AF89P AL	Dorma	689
2	Stops and Holders	473 Door Stop w/ Hook	Rockwood	626
2	Accessories	Door Sweep 18062CNB36	Pemko	A
1	Threshold	325 Half Saddle Threshold	National Guard	---
1	Sign	Vinyl Sign: "THIS DOOR MUST REMAIN UNLOCKED WHEN BUILDING IS OCCUPIED"	Seton	---

STOREFRONT DOOR (TYPE B)

DOOR HARDWARE SET NO. 2-A - For new single aluminum secondary entry/exit door (50 or more occupancy)				
No.	Item	Description	Manufacturer	Finish
3	Hanging Devices	TH2314/MPB91	McKinney	630
1	Securing Devices	CD35A-NL-OP Panic Device	Von Duprin	628/630
2	Securing Devices	C607 7-Pin Core Combined "A" Keyway	Falcon Lock	626
1	Securing Devices	KB609-2 Cut Control Key "A" Keyway	Falcon Lock	---
9	Securing Devices	KB632-2 Cut User Key "A" Keyway	Falcon Lock	---
1	Securing Devices	C953 7-Pin Rim Cylinder Housing	Falcon Lock	626
1	Securing Devices	C987 7-Pin Mortise Cylinder Housing w/AR Cam	Falcon Lock	626
1	Securing Devices	A08794-003 Adjustable Ring, Mortise Cyl. 5/16-13/32	Falcon Lock	626
1	Operating Trim	108 Door Pull Handle	Rockwood	630
1	Closing Devices	8916 Door Closer 8916 AF89P	Dorma	689
1	Stops and Holders	473 Door Stop w/ Hook	Rockwood	626
1	Threshold	325 Half Saddle Threshold	National Guard	---
1	Sign	Vinyl Sign: "THIS DOOR MUST REMAIN UNLOCKED WHEN BUILDING IS OCCUPIED"	Seton	---

RESTROOM DOOR (TYPE E)

DOOR HARDWARE SET NO. 6 - For restroom door with lever and privacy lock				
No.	Item	Description	Manufacturer	Finish
3	Hanging Items	TA2714/MPB79 Hinge MacPro Bearing 4.5 x 4.5	McKinney	626
1	Securing Devices	PB5425LN Lock, Shallow Coin Turn, Privacy PB5425LN-693-497 1-3/4	Yale Lock	626
1	Closing Devices	8916 Door Closer 8916 AF89P	Dorma	689
2	Protective Trim Units	K1050 B4E Kickplate 8" x 34" Each Side 32D	Rockwood	630
3	Accessories	GJ64 Rubber Silencer	Glynn Johnson	Gray
1	Stops and Holders	473 Door Stop w/ Hook	Rockwood	626

SERVICE DOOR (TYPE F)

DOOR HARDWARE SET NO. 42 - For exterior 42" wide service door				
No.	Item	Description	Manufacturer	Finish
3	Hanging Devices	TH2314/MPB91 Hinge MacPro Bearing 4.5 x 4.5	McKinney	630
1	Securing Devices	C607 7-Pin Core Combined "A" Keyway	Falcon Lock	626
1	Securing Devices	I/O 2000L-03IC Auto Locking Door Alarm, IC; No CTR Includes Mortise Cylinder	Sur-Lock	---
1	Closing Devices	8916 Door Closer 8916 AF89P	Dorma	689
1	Protective Trim Units	K1050 B4E Kickplate 10" x 40"	Rockwood	630
1	Accessories	137NA Weather Strip 20" 42" x 84"	National Guard	A
1	Accessories	Door Sweep 18062CNB36	Pemko	A
1	Miscellaneous Items	DS / 1000 Door Scope	Security Products	Silver
1	Miscellaneous Items	MCV309NWHGL Door Bell	Nutone	As Selected

WORKROOM DOOR (TYPE G)

DOOR HARDWARE SET NO. 11 - For workroom door at backbar				
No.	Item	Description	Manufacturer	Finish
1	Traffic Door Package	SCP8 36" x 84"	Eliason	As Selected

INTERIOR DOOR SCHEDULE - "D"					
DESIGN ID	COUNT	DESCRIPTION	FURN. BY	INST. BY	COMMENTS
DOOR					
10086	1	DOOR - SINGLE IMPACT DOUBLE ACTING - 36IN 915MM - TYPE G	SB	GC	ELIASON; SEE HARDWARE SET # 11; DOOR TYPE G; HOLLOW METAL DOOR, DOOR FINISH:PL0019; FRAME FINISH:MT0023
10190	2	DOOR - SINGLE FLUSH - 36IN - TYPE E	SB	GC	DOOR FINISH: SW7039-ES; FRAME FINISH: SW7039-SG; LOCKNET; SEE HARDWARE SET #6, DOOR TYPE E
X2001	1	DOOR - STOREFRONT METAL FRAME SINGLE - TYPE B	EXIST	EXIST	DOOR: LOCKNET; DOOR FINISH: CLEAR GLASS; FRAME FINISH: BLACK; SEE HARDWARE SET # 2-A, DOOR TYPE B
X2002	1	DOOR - STOREFRONT METAL FRAME DOUBLE - TYPE A	EXIST	EXIST	DOOR: LOCKNET; DOOR FINISH: CLEAR GLASS; FRAME FINISH: BLACK; SEE HARDWARE SET # 3-A, DOOR TYPE A
X2003	1	DOOR - SINGLE FLUSH - SERVICE DOOR - 42IN - TYPE F	EXIST	EXIST	LOCKNET; SEE HARDWARE SET #42, DOOR TYPE F

WINDOW SCHEDULE - "W"					
DESIGN ID	COUNT	DESCRIPTION	FURN. BY	INST. BY	COMMENTS
WINDOW					
10118	1	WINDOW - DT HURRICANE RATED - 48X44IN 1205X1105MM - ALUMINUM	EXIST	EXIST	LL TO SPECIFY IMPACT GLASS OR NON-IMPACT GLASS AS REQUIRED. CONTACT DAN RADEK AT dan@ready-access.com 1-800-621-5045

RESPONSIBILITY LEGEND

FURN. BY	INST. BY
SB - FURNISHED BY STARBUCKS	GC - INSTALLED BY GENERAL CONTRACTOR
GC - FURNISHED BY GENERAL CONTRACTOR	SB - INSTALLED BY STARBUCKS
VD - FURNISHED BY VENDOR	VD - INSTALLED BY VENDOR

NOTE:
ALL RESPONSIBILITIES TO BE CONFIRMED WITH STARBUCKS CONSTRUCTION MANAGER PRIOR TO ORDERING / CONSTRUCTION.

GENERAL NOTES

- STARBUCKS VENDOR TO PROVIDE DOOR HARDWARE COMPONENTS. GC TO INSTALL.
- SEE SHEET A101 FOR TAGGED LOCATION OF EXTERIOR DOORS AND WINDOWS.
- EGRESS SHALL NOT PASS THROUGH KITCHENS, STORAGE ROOMS, CLOSETS OR SIMILAR SPACES. (1014.2)
- PANIC AND FIRE EXIT HARDWARE, WHERE INSTALLED ON DOORS IN THIS BUILDING SHALL SATISFY THE FOLLOWING (1008.1.10):
 - THE ACTUATION PORTION OF THE RELEASING DEVICE SHALL EXTEND AT LEAST ONE-HALF OF THE DOOR LEAF WIDTH.
 - THE MAXIMUM UNLATCHING FORCE DOES NOT EXCEED 15 POUNDS (6.8 KG).
 - PIVOTED OR BALANCED DOORS SHALL BE OF THE PUSH-PAD TYPE WHERE PANIC HARDWARE IS REQUIRED AND THE PAD SHALL NOT EXTEND ACROSS MORE THAN ONE-HALF OF THE DOOR WIDTH, MEASURED FROM THE LATCH SIDE.
 - PANIC HARDWARE LISTED IN ACCORDANCE WITH UL 305.
 - FIRE EXIT HARDWARE LISTED IN ACCORDANCE WITH UL 10C AND UL 305.



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09/12/2023

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PROJECT ADDRESS:
**3159 W NORVELL BRYANT HWY
LECANTO, FL 34461**


STORE #:	78366
PROJECT #:	97107-001
ISSUE DATE:	09/06/2023
DESIGNER:	RAI MONTERO
PRODUCTION DESIGNER:	ANDY MCLLOUD
CHECKED BY:	DONALD RETHMAN

Revision Schedule			
Rev	Date	By	Description

SHEET TITLE:
WINDOW AND DOOR SCHEDULES & DETAILS
SCALE: NO SCALE

SHEET NUMBER:
A-601


BLD202323715

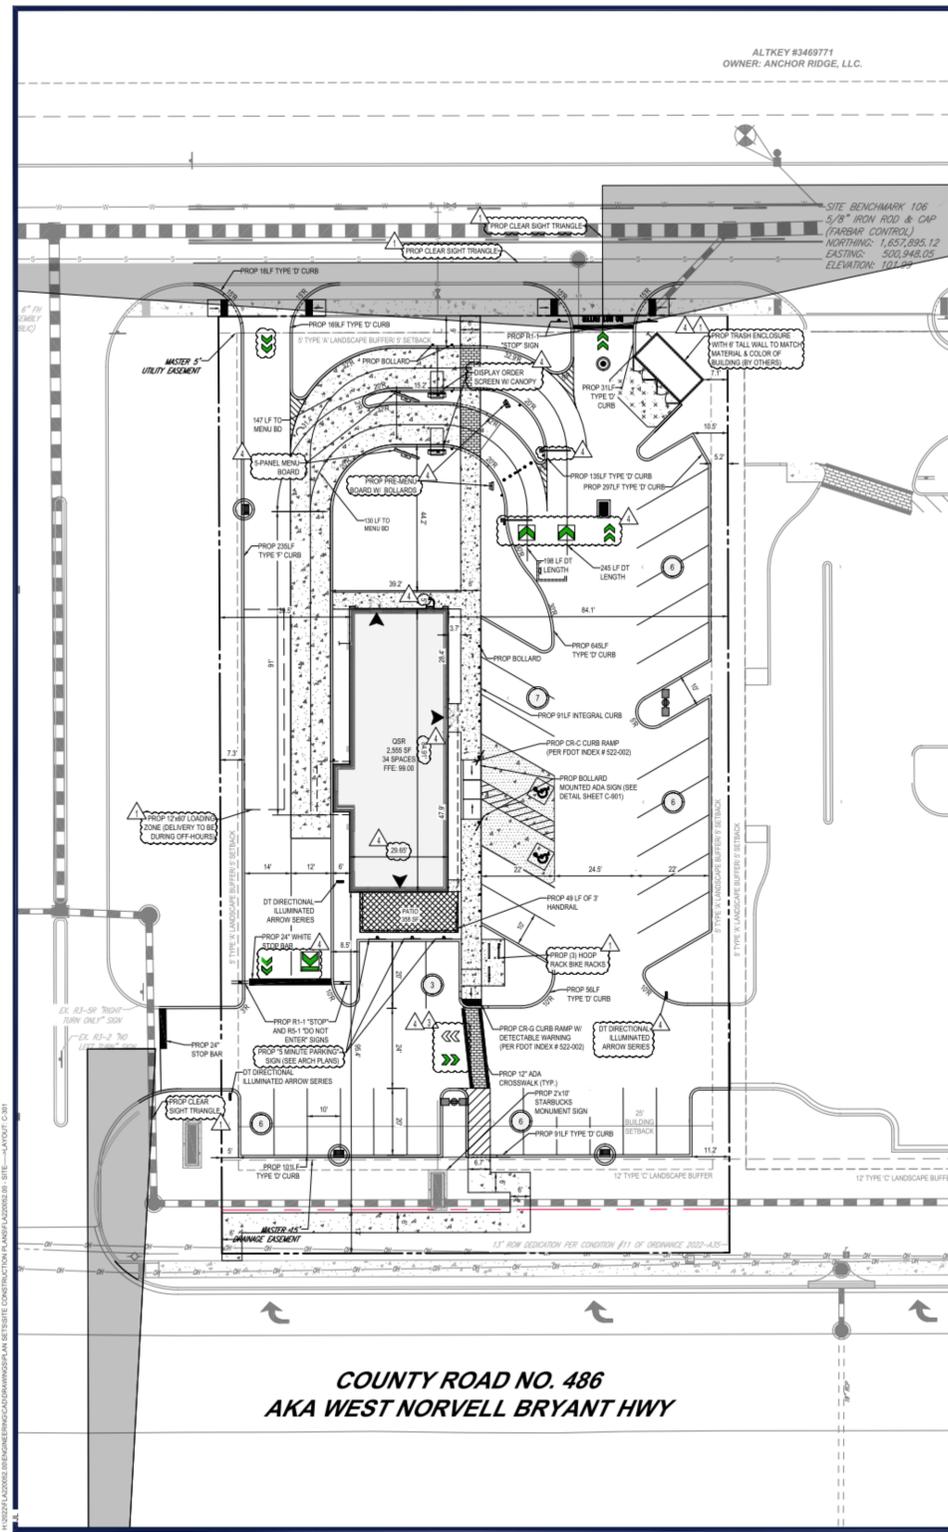

COUNTY ROAD NO. 486
AKA WEST NORVELL BRYANT HWY

SITE DATA	
PARCEL ID/PLAT NUMBER	
SITE ADDRESS	CR 486 & CR 486 LECANTO, FL 34461
JURISDICTION	CITRUS COUNTY
ZONING	ONC, MCR
FORM ZONE	2 / AE (EL. 03.0)
PROPOSED F.A.R.	0.88
MAXIMUM BUILDING HEIGHT	
TOTAL PROJECT AREA	45,948 SF (0.34 AC)
EXISTING GREEN SPACE	45,948 SF (0.34 AC)
PROPOSED GREEN SPACE	13,010 SF (0.34 AC)
PROPOSED TOTAL IMPERVIOUS AREA	25,548 SF (0.34 AC)
PROPOSED BLDG. AREA	2,585 SF (0.02 AC)
PROPOSED UTA AREA	23,063 SF (0.34 AC)
PROPOSED OTHER IMPERVIOUS AREA	1,510 SF (0.02 AC)
PARKING CALCULATIONS	
(1)(2)(3) REG. PARKING SPACES PROVIDED	32
TOTAL (1)(2)(3) ADA SPACES PROVIDED	2
TOTAL SPACES PROVIDED	34
REQUIRED PARKING SPACES	1:1,700 / 19 SPACES
MAX OCCUPANCY	36 (INTERIOR) / 34 (EXTERIOR) = 19 OCCUPANTS
REQUIRED BICYCLE PARKING SPACES	1 (50' PARKING SPACE + 1 SPACE)
PROVIDED BICYCLE PARKING SPACES	0 (5 SPACES)
BUILDING SETBACKS	
NORTH	0'
SOUTH	25'
EAST	0'
WEST	0'
LANDSCAPE BUFFERS	
NORTH	0' TYPE 'X'
SOUTH	12' TYPE 'C'
EAST	0' TYPE 'X'
WEST	0' TYPE 'X'

LEGEND	
EX. PROPERTY LINE	---
EX. ADJACENT PROPERTY LINE	---
EX. ROADWAY CL.	---
PROP. PROPERTY LINE	---
PROP. BUFFER	---
PROP. SETBACK	---
PROP. PARKING COUNT	○
PROP. SIGN	▲
PROP. BUILDING ENTRANCES	▲
PROP. CONCRETE SIDEWALK	▨
PROP. BLACK CONCRETE	▨
PROP. HEAVY DUTY CONCRETE	▨

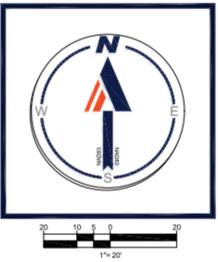

BOHLER
SITE CIVIL AND CONSULTING ENGINEERING
PROGRAM MANAGEMENT
LANDSCAPE ARCHITECTURE
PERMITTING SERVICES
TRANSPORTATION SERVICES

REVISIONS				
REV	DATE	COMMENT	DESIGNED BY	CHECKED BY
1	9/13/2023	PER CITRUS COUNTY COMMENTS	EA	KM
2	9/30/2023	PER CITRUS COUNTY COMMENTS	EA	KM
3	10/27/2023	ARCH COORDINATION	SU	KM
4	09/17/2023	TENANT COORDINATION	EA	KM

811
Know what's below.
Call before you dig.
ALWAYS CALL 811
It's fast. It's free. It's the law.

ISSUED FOR MUNICIPAL & AGENCY REVIEW & APPROVAL

PROJECT NO.: FLA2200262-03
DRAWN BY: J. EA
CHECKED BY: KM
DATE: 11/16/2023
CAD I.D.: SITE - 0

SITE CONSTRUCTION PLANS
FOR

BEVERLY HILLS CROSSING - STARBUCKS
N LECANTO HWY & W NORVELL BRYANT HWY
LECANTO, FL 34461
S21 - T18S - R18E

BOHLER
600 N. WESTSHORE BLVD., SUITE 950
TAMPA, FLORIDA 33609
Phone: (813) 812-4100
Fax: (813) 812-4101
FLORIDA BUSINESS CERT. OF AUTH. NO. 3709

THIS ITEM HAS BEEN DIGITALLY SIGNED AND SEALED BY KYLE STEVEN MOORE, PE, ON THE DATE ADJACENT TO THE SEAL. PRINTED COPIES OF THIS DOCUMENT ARE NOT CONSIDERED SIGNED AND SEALED AND THE SIGNATURE MUST BE VERIFIED ON ANY ELECTRONIC COPIES.

SHEET TITLE:
SITE PLAN

SHEET NUMBER:
C-301

REVISION 4 - 05/17/2023

- SITE NOTES:**
- THE PROPOSED ACTIVITIES SHALL COMPLY WITH CITRUS COUNTY DEVELOPMENT REGULATIONS (LATEST EDITION), INCLUDING THE TREE AND LANDSCAPE CODE, STORM WATER MANAGEMENT REGULATIONS, AND FIRE CODES AT THE TIME OF PERMITTING.
 - SIDEWALKS TO BE PROVIDED AND BUILT IN ACCORDANCE WITH F.D.O.T. AND CITRUS COUNTY LAND DEVELOPMENT REGULATIONS (LATEST EDITION). ALL PROPOSED SIDEWALKS SHALL MEET ADA REQUIREMENTS.
 - ALL DIMENSIONS ARE SHOWN AT FACE OF CURB, UNLESS OTHERWISE NOTED. B/C INDICATES DIMENSION IS TO BACK OF CURB.
 - ALL RADII DIMENSIONS ARE 2' AT THE FACE OF CURB UNLESS OTHERWISE NOTED.
 - FREE STANDING SIGNAGE SHOWN ONLY FOR REPRESENTATIONAL PURPOSES, AND SHALL BE PERMITTED SEPARATELY.
 - A RIGHT-OF-WAY PERMIT WILL BE REQUIRED FOR ALL WORK WITHIN THE PUBLIC RIGHT-OF-WAY. SPECIFIC STIPULATIONS OR CONDITIONS WILL BE IMPOSED AT THE TIME OF PERMIT APPLICATION.
 - CONSTRUCTION PLAN APPROVAL DOES NOT EXEMPT THE CONTRACTOR FROM OBTAINING THE REQUIRED BUILDING, ELECTRICAL, PLUMBING, AND MECHANICAL PERMITS. THESE INCLUDE BUT ARE NOT LIMITED TO ANY STRUCTURE, SIGN, WALL, ENCLOSURE, OR SCREENING, ETC.
 - IN THE EVENT THE PROJECT IS TERMINATED PRIOR TO CONSTRUCTION COMPLETION, THE PROJECT SHALL BE BROUGHT TO GRADE, SEEDED, AND ALL DEBRIS AND MATERIALS SHALL BE HAULED OFF-SITE AND DUMPED AT A STATE OF FLORIDA APPROVED FACILITY.
 - ANY DAMAGED SIDEWALK OR CURB WITHIN THE F.D.O.T. RIGHT-OF-WAY SHALL BE REMOVED AND REPLACED.
 - ALL DISTURBED AREAS WITHIN THE F.D.O.T. RIGHT-OF-WAY WILL BE SOODED.
 - STANDARD INDICES REFER TO THE LATEST VERSION OF F.D.O.T. "ROADWAY AND TRAFFIC DESIGN STANDARDS"
 - NO LANE CLOSURES ARE ALLOWED BETWEEN 5:00 A.M. AND 7:30 P.M. THE F.D.O.T. RESERVES THE RIGHT TO REQUIRE DIFFERENT HOURS OF LANE CLOSURE. ALL LANE CLOSURES MUST BE APPROVED BY THE DEPARTMENT AT LEAST TWO WEEKS PRIOR TO THE LANE CLOSURE IN ACCORDANCE WITH THE DISTRICT LANE CLOSURE POLICY.
 - ALL POTABLE WATER, RECLAIMED WATER, AND SANITARY SEWER CONSTRUCTION SHALL BE IN ACCORDANCE WITH THE APPROVED CONSTRUCTION PLAN.
 - FDEP WATER AND WASTEWATER PERMITS MUST BE OBTAINED PRIOR TO BEGINNING CONSTRUCTION.
 - PROPER DOCUMENTATION FOR ALL PUBLIC UTILITY EASEMENTS SHALL BE PROVIDED TO THE PROPERTY MANAGEMENT DEPARTMENT PRIOR TO CERTIFICATE OF COMPLETION.
 - UTILITY RECORD DRAWINGS ARE REQUIRED PRIOR TO PLACING THIS WATER AND WASTEWATER FACILITIES INTO SERVICE. PLEASE SEE THE ADDITIONAL INFORMATION SECTION FOR INSTRUCTIONS.

- RIGHT-OF-WAY NOTES:**
- A RIGHT-OF-WAY USE PERMIT WILL BE REQUIRED FOR ALL WORK WITHIN THE PUBLIC RIGHT-OF-WAY. SPECIFIC STIPULATIONS OR CONDITIONS WILL BE IMPOSED AT THE TIME OF PERMIT APPLICATION.
 - ALL AREAS WITHIN THE COUNTY OR F.D.O.T. RIGHT-OF-WAY DISTURBED THROUGH THE COURSE OF CONSTRUCTION WILL BE RE-GRADED AND SOODED.
 - IT SHALL BE THE DEVELOPER'S RESPONSIBILITY TO PROTECT ALL COUNTY OR F.D.O.T. OWNED AND/OR MAINTAINED INFRASTRUCTURE. ANYALL COSTS ASSOCIATED WITH ALTERATIONS, RELOCATIONS, OR REPAIRS MADE NECESSARY BY THIS DEVELOPMENT SHALL BE BORNE BY EITHER THE OWNER, DEVELOPER, AND/OR CONTRACTOR. SPLICES IN THE FIBER OPTIC CABLE, SIGNALIZATION OR ROADWAY LIGHTING CONDUCTORS, OR THE ADDITION OF ADDITIONAL PULL/JUNCTION BOXES WILL NOT BE PERMITTED IN THE EVENT A CABLE IS CUT, DAMAGED, OR REQUIRES RELOCATION, THE CABLE(S) SHALL BE RESTORED BACK TO THE ORIGINAL CONFIGURATION. ORIGINAL CONFIGURATION IS DEFINED AS SYSTEM STATUS, LAYOUT, AND DESIGN PRIOR TO ANY WORK COMMENCING.
 - FOR UTILITIES TO BE RELOCATED BY THE UTILITY PROVIDER, CONTRACTOR SHALL COORDINATE DEMOLITION SCHEDULE WITH UTILITY PROVIDERS. DEMOLITION OF SIDEWALKS AND DRIVEWAYS SHALL OCCUR PRIOR TO UTILITY RELOCATIONS.

- ADA ACCESSIBILITY NOTES:**
- ALL HANDICAPPED PARKING SPACES AND ACCESS AISLES ADJACENT TO THE HANDICAP PARKING SPACES SHALL HAVE A MAXIMUM OF 2% SLOPE IN ALL DIRECTIONS (THIS INCLUDES RUNNING SLOPE AND CROSS SLOPE).
 - AN ACCESSIBLE ROUTE FROM THE PUBLIC STREET OR SIDEWALK TO ALL BUILDING ENTRANCES MUST BE PROVIDED. THIS ACCESSIBLE ROUTE SHALL BE A MINIMUM OF 60" WIDE. THE RUNNING SLOPE OF AN ACCESSIBLE ROUTE SHALL NOT EXCEED 5% AND THE CROSS SLOPE SHALL NOT EXCEED 2%.
 - SLOPES EXCEEDING 5% BUT LESS THAN 8% WILL REQUIRE A RAMP AND MUST CONFORM TO THE REQUIREMENTS FOR RAMP DESIGN (HANDRAILS, CURBS, LANDINGS). NO RAMP SHALL EXCEED AN 8% RUNNING SLOPE OR 2% CROSS SLOPE.
 - IN THE CASE THAT A NEW SIDEWALK WILL BE CONSTRUCTED IN THE ROW OF A SITE, THE RUNNING SLOPE OF THE SIDEWALK SHALL NOT EXCEED 5% AND THE CROSS SLOPE SHALL NOT EXCEED 2%. THIS STANDARD APPLIES TO CROSS WALKS IN THE DRIVEWAY AS WELL AND WILL REQUIRE SPECIAL ATTENTION DURING STAKING TO MAKE SURE THE 2% CROSS SLOPE IS MET IN THE CROSS WALK.
 - IT WILL BE THE RESPONSIBILITY OF THE GENERAL CONTRACTOR TO ENSURE THAT THE HANDICAP PARKING SPACES, ACCESSIBLE ROUTES, AND SIDEWALKS/CROSSWALKS ARE CONSTRUCTED TO MEET ADA REQUIREMENTS.
 - ANY REQUIREMENTS LISTED ABOVE THAT CAN NOT BE MET SHALL BE BROUGHT TO THE ENGINEER'S ATTENTION IMMEDIATELY. ANYTHING NOT BUILT TO THE ABOVE STANDARDS WILL REQUIRE REMOVAL AND REPLACEMENT OF THE NON-COMPLIANT AREAS AT THE GENERAL CONTRACTOR'S COST.



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09/12/2023

FOR CONSTRUCTION

PROJECT NAME:
LECANTO HWY & NORVELL BRYANT

PROJECT ADDRESS:
**3159 W NORVELL BRYANT HWY
LECANTO, FL 34461**

STORE #: 78366
PROJECT #: 97107-001
ISSUE DATE: 09/06/2023
DESIGNER: RAI MONTERO
PRODUCTION DESIGNER: ANDY MCCLLOUD
CHECKED BY: DONALD RETHMAN

Revision Schedule			
Rev	Date	By	Description

SHEET TITLE:
LL SITE PLAN

SCALE: 1/4" = 1'-0"

SHEET NUMBER:
SP-001

1 LANDLORD SITE PLAN

BLD202323715

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KEYED NOTES


- INSTALL EXTERIOR FURNITURE AS SHOWN.
- INSTALL CAFE FURNITURE THROUGHOUT AS SHOWN.
- LOCATION OF CONDIMENT CART. SEE INTERIOR FINISH ELEVATIONS.
- DO NOT CAULK TRASH RINGS TO COUNTERTOP.
- DO NOT BLOCK FOOD CASE INTAKE/ EXHAUST.
- INSTALL MERCH BAY AS INDICATED. SECURE TO WALL.
- SAFE LOCATED AT POS CABINET.
- HAND SINK W/ INTEGRAL SPLASH GUARD.
- G.C. TO REVERSE HINGE ON U.C. REFRIGERATOR TO LEFT HAND SWING AS SHOWN.
- INSTALL NITRO EQUIPMENT AS INDICATED.
- LOCATION OF FUTURE 3RD BAR.
- SECURE LOCKERS TO WALL PER MFGS. RECOMMENDATIONS.
- LOCATION OF ALL SWITCHING.
- PLACE FIRE EXTINGUISHER IN WORKROOM PER FIRE INSPECTOR.
- REFER TO ENLARGED RESTROOM PLANS AND ELEVATIONS (SHEET I-401) FOR FIXTURE LOCATIONS AND MOUNTING HEIGHTS.
- MANAGERS DESK. SEE MANAGER'S DESK / EQUIPMENT RACK ELECTRICAL DETAIL FOR ADDITIONAL INFORMATION.
- VENDOR TO INSTALL WATER FILTRATION SYSTEM PER MANUFACTURER'S REQUIREMENTS. G.C. TO PROVIDE PLUMBING AND ELECTRICAL REQUIREMENTS.
- WATER HEATER LOCATED ABOVE. SEE PLUMBING DRAWINGS.
- RECESSED ELECTRICAL PANELS. SEE BUILDING FLOOR PENETRATION PLAN ON SHEET A-102 AND ELECTRICAL FOR ADDITIONAL INFORMATION.
- EXISTING PATIO RAILING.

NOTE:
REFER SHEET I-101.1 FOR DATA DEVICE, FURNITURE, GRAPHICS, PLUMBING FIXTURE, SPECIALTY EQUIPMENT, MECHANICAL EQUIPMENT AND SITE SCHEDULE.

- EXISTING HOSE BIB.
- EXISTING ROOF ACCESS LADDER.
- LOCATION OF FUTURE WARMING OVEN.
- LOCATION OF FUTURE FREEZER.

GENERAL NOTES

- GENERAL CONTRACTOR TO SCHEDULE WITH LOCAL REFRIGERATION CONTRACTOR TO CONDUCT INITIAL FOOD CASE START-UP AND TESTING. FOR LIST OF APPROVED START UP CONTRACTORS, CONTACT PROJECT CONSTRUCTION REPRESENTATIVE.
- THE SITE IS SERVED BY THE MUNICIPAL WATER AND SEWER SYSTEM UNLESS OTHERWISE NOTED.
- ALL FLOOR AND WALL JUNCTIONS IN STORAGE AND PREP. AREAS SHALL HAVE A 6" COVED BASE.
- ALL FOOD STORAGE SHALL BE 6" (150mm) A.F.F.
- ALL WOOD SURFACES (DOORS, TRIM, SHELVES, CABINETS) SHALL BE SEALED.
- FLOORS, WALLS AND CEILING FINISHES IN FOOD PREP. AREAS SHALL BE SMOOTH, NON-TOXIC, NON-ABSORBENT, DURABLE AND EASILY CLEANABLE. PAINT SHALL BE WASHABLE AND SEMI-GLOSS OR HIGH-GLOSS FINISH.
- ALL EQUIPMENT AND INSTALLATION WILL MEET NATIONAL SANITATION FOUNDATION STANDARDS OR EQUIVALENT.
- ALL EQUIPMENT AND CABINERY WILL BE FLUSH MOUNTED TO COUNTERS, WALLS OR FLOORS, OR BE RAISED TO ALLOW FOR CLEANING.
- CONFIRM ALL NECESSARY CLEARANCES PER PRODUCT CUT SHEET REQUIREMENTS FOR ALL EQUIPMENT (E.G. ICE MACHINE).
- EQUIPMENT UNITS SHALL CONTAIN NO EXPOSED THREADS, EMBELLISHMENTS OR OVERHANGING EDGES THAT SERVE AS PLACES FOR ACCUMULATION OF DUST, DIRT AND DEBRIS.
- WARMING OVEN(S) SHOWN FOR PERMITTING PURPOSES. INSTALLATION AT STORE OPENING TO BE VERIFIED BY STARBUCKS CONSTRUCTION REPRESENTATIVE.
- EACH HAND WASHING SINK WILL HAVE A SINGLE SERVICE TOWEL AND SOAP DISPENSER, AND ALL HAND SINKS TO HAVE A COMBINATION FAUCET OR PREMIXING FAUCET.
- FOR PLUMBING FIXTURES, REFER TO THE PLUMBING DESIGN PLAN. FOR DATA DEVICE SCHEDULE, REFER TO THE ELECTRICAL DESIGN PLAN.
- SEE ELEVATIONS FOR DISTRIBUTION OF CUP DISPENSERS.

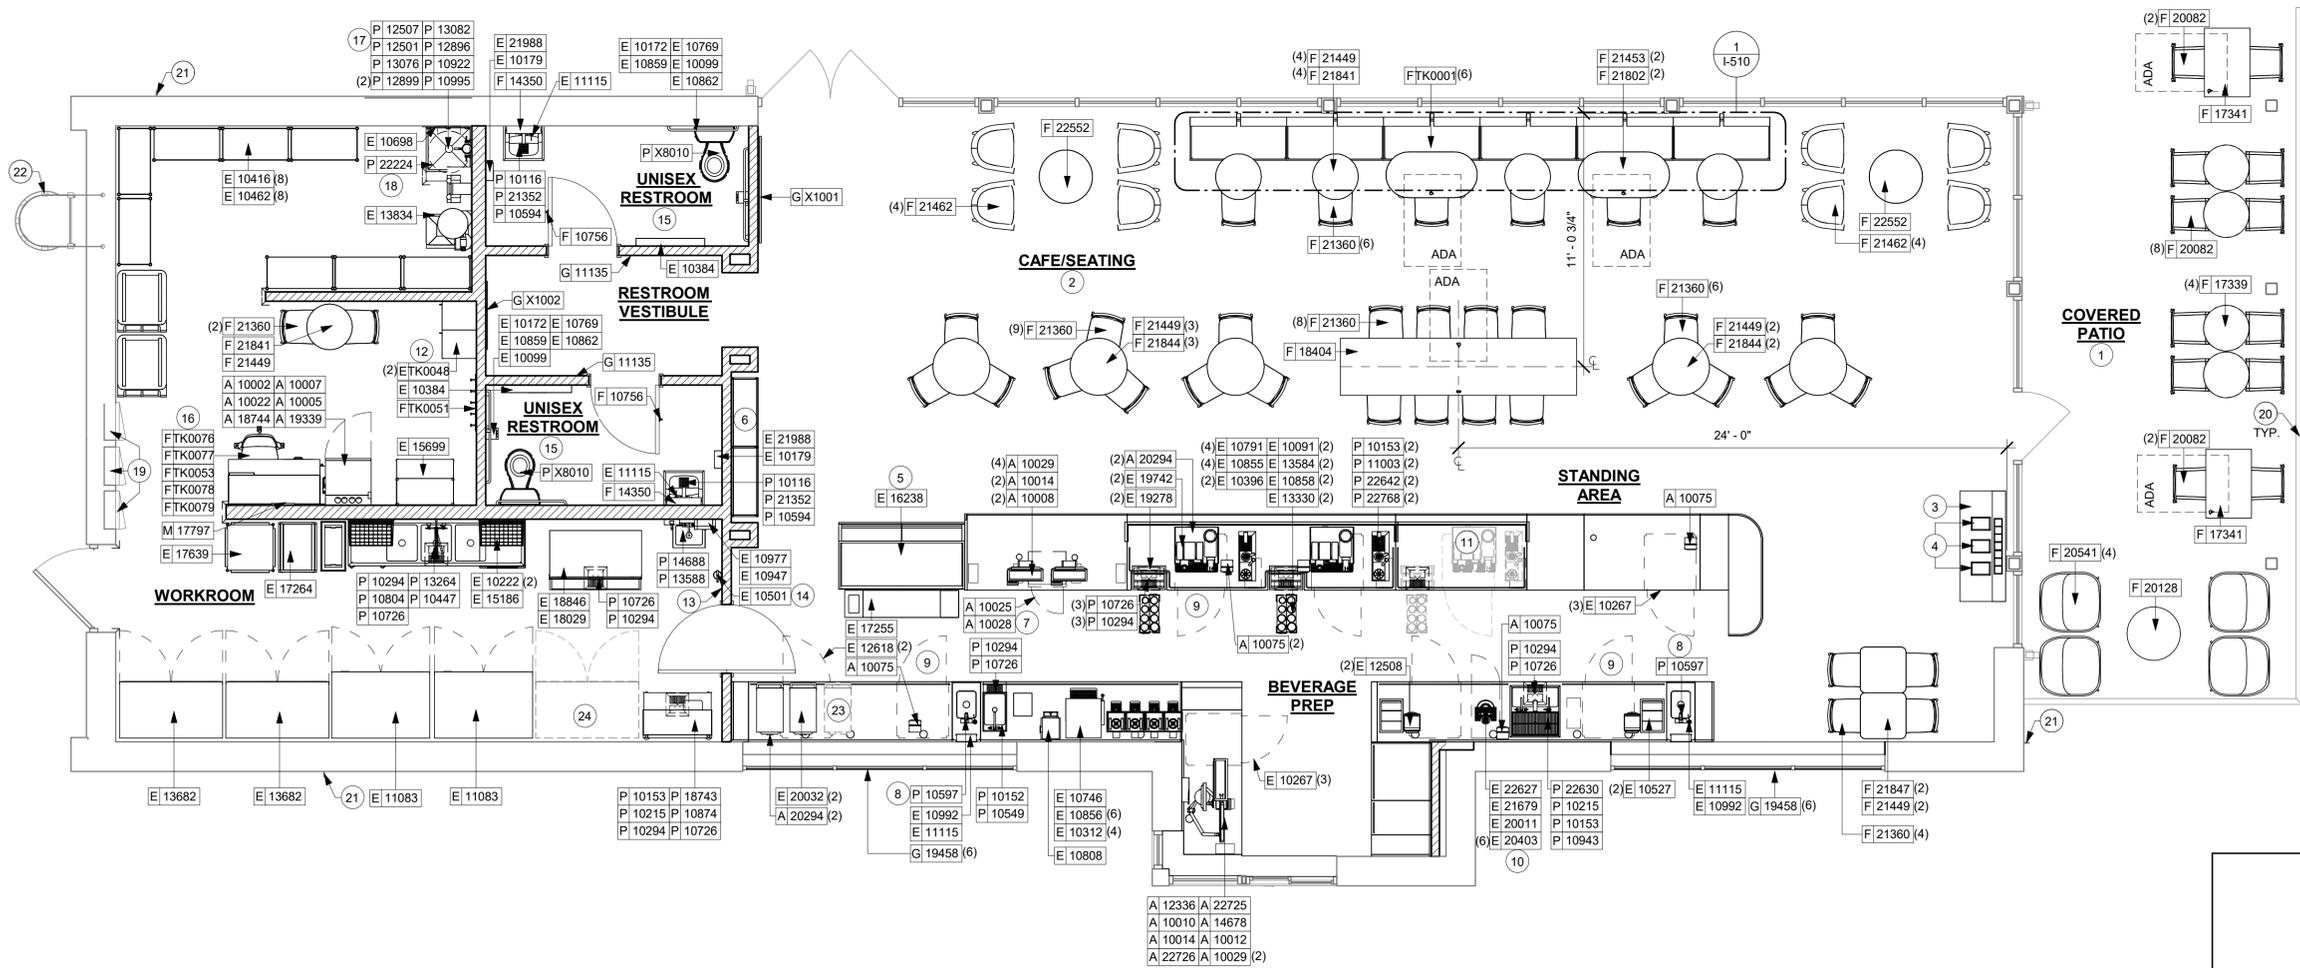

1 FURNITURE, FIXTURES AND EQUIPMENT PLAN
Scale: 1/4" = 1'-0"



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FOR CONSTRUCTION

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DESIGNER: RAI MONTERO
PRODUCTION DESIGNER: ANDY MCLLOUD
CHECKED BY: DONALD RETHMAN

Revision Schedule			
Rev	Date	By	Description

SHEET TITLE:
FF & E PLAN

SCALE: 1/4" = 1'-0"

SHEET NUMBER:
I-101

BLD202323715

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DATA DEVICE SCHEDULE - "A"					
DESIGN ID	COUNT	DESCRIPTION	FURN. BY	INST. BY	COMMENTS
AUDIO VISUAL					
10005	1	MUSIC SYSTEM	SB	GC	
10010	1	DT ORDER MONITOR	SB	VD	
10012	1	DT COMMUNICATION SYSTEM	SB	VD	
10013	4	DT QUEUE CAMERA	SB	VD	
10015	4	SPEAKER RECESSED - WHITE	SB	GC	
10017	2	SPEAKER SURFACE MOUNTED	SB	GC	BLACK EXTERIOR
12336	1	DT TIMER SYSTEM	SB	VD	
19339	1	AMPLIFIER - 40W	SB	GC	
22549	4	SPEAKER GRILLE RECESSED - BLACK	SB	GC	
22725	1	DT DIGITAL PRODUCTION MONITOR	SB	VD	PART OF RETAIL IT EQUIPMENT PACKAGE
22726	1	DT POS MONITOR ARM TRIPLE SURFACE MOUNTED	SB	VD	PART OF RETAIL IT EQUIPMENT PACKAGE
DATA					
10002	1	COMPUTER MANAGER WORKSTATION	SB	GC	
10007	1	PRINTER MANAGER WORKSTATION	SB	GC	
18744	1	EQUIPMENT RACK WITH LOCK - 24IN 610MM	SB	VD	
20294	4	IOT MODULE	SB	GC	
GRAPHICS - INTERIOR MENU					
22970	3	MENU BOARD - DIGITAL MENU BOARD - 44X25.25IN 1121X644MM - BLACK	SB	GC	
MENU BOARD					
22971	3	MENU - DMB SCREEN MOUNTING BRACKET	SB	GC	
POINT OF SALE					
10008	2	POS - REGISTER WITH COMPACT CASH DRAWER	SB	VD	
10014	3	POS PRINTER	SB	VD	
10022	1	MONEY COUNTER	SB	GC	
10029	6	POS BANK	SB	GC	
10075	5	CUP LABELER	SB	VD	
14678	1	POS - DT EXPEDITOR	SB	GC	PART OF RETAIL IT EQUIPMENT PACKAGE
SECURITY					
10025	1	SAFE RH - 20X18X26IN 510X455X660MM	SB	GC	
10028	1	SAFE BASE	SB	GC	

FURNITURE SCHEDULE - "F"					
DESIGN ID	COUNT	DESCRIPTION	FURN. BY	INST. BY	COMMENTS
BANQUETTE					
TK0001	6	BANQUETTE - ORION - - WALNUT AND CARAMEL BROWN NATURAL WD0077 F0008	SB	GC	SEE DETAIL: 1/1-510
CHAIR					
20082	12	CHAIR - CAFE PYRAMID - BLACK AND NATURAL ROPE MT0028 F0227	SB	GC	
20541	4	CHAIR - LOUNGE NEST - BLACK AND NATURAL ROPE MT0028 F0227	SB	GC	
21360	35	CHAIR - CAFE PEGGY - WALNUT WD0077	SB	GC	
21462	8	CHAIR - LOUNGE ASHER WOOD SEAT - WALNUT AND CARAMEL BROWN NATURAL WD0077 F0008	SB	GC	
TK0077	1	CHAIR - MANAGERS WORKSTATION	SB	GC	STEELCASE SERIES ONE ARMLESS
DESK					
TK0053	1	DESK - MANAGERS WORKSTATION SHELVES - 49IN 1220MM	SB	GC	
TK0076	1	DESK - MANAGERS WORKSTATION - 48X24X27IN 1220X610X685MM	SB	GC	
MIRROR					
14350	2	MIRROR - RESTROOM ANGLED- 18X36IN 455X915MM	SB	GC	INSTALLED AT CENTER OF (E) SINK, MIN. 40" A.F.F. TO B.O. MIRROR.
OTHER					
10756	2	COAT HOOK 1 PRONG SQUARE - 2IN 50MM - SST	SB	GC	
TK0051	1	COAT HOOK STRIP - 30IN 760MM	SB	GC	BLACK FINISH
STORAGE					
TK0078	1	FILE MOBILE PEDESTAL WITH CUSHION AND LOCK	SB	GC	
TK0079	1	MANAGERS DESK CART - 24X20IN 610X510MM	SB	GC	
TABLE					
17339	4	TABLE - CAFE METAL PEDESTAL BASE ROUND - 24IN 610MM - BLACK MT0028	SB	GC	
17341	2	TABLE - ACCESSIBLE METAL WITH TAPERED LEGS - 36X24IN 915X610MM - BLACK MT0028	SB	GC	
18404	1	TABLE - COMMUNITY CAFE HEIGHT ANGLE BASE - 10 SEAT NARROW - WITH POWER WALNUT WD0077	SB	GC	
20128	1	TABLE - OCCASIONAL COFFEE CAMERON - FLAT BLACK MT0028	SB	GC	
21449	12	TABLE - BASE CAFE HEIGHT BOTTLE - FLAT BLACK MT0028	SB	GC	
21453	2	TABLE - BASE ACCESSIBLE BOTTLE - FLAT BLACK MT0028	SB	GC	
21802	2	TABLE - TOP ACCESSIBLE ROUND EDGE OBLONG - 48X24IN 1220X610MM - WALNUT WD0077	SB	GC	
21841	5	TABLE - TOP ROUND EDGE ROUND - 24IN 610MM - WALNUT WD0077	SB	GC	
21844	5	TABLE - TOP ROUND EDGE ROUND - 30IN 760MM - WALNUT WD0077	SB	GC	
21847	2	TABLE - TOP ROUND EDGE SQUARE - 24IN 610MM - WALNUT WD0077	SB	GC	
22552	2	TABLE - OCCASIONAL COFFEE WING - WALNUT WD0077	SB	GC	
WINDOW TREATMENT					
22486	20	ROLLER SHADE - DARK BROWN - 5PC OPEN	SB	VD	OVERALL LENGTH REQUIRED:(VIF) (1) 8' - 0" LENGTH (9) 4' - 6 3/4" LENGTH (2) 3' - 10" LENGTH (2) 3' - 5" LENGTH (1) 3' - 2" LENGTH (2) 3' - 0" LENGTH

MECHANICAL EQUIPMENT SCHEDULE - "M"					
DESIGN ID	COUNT	DESCRIPTION	FURN. BY	INST. BY	COMMENTS
FAN					
X8001	2	CEILING FAN ALTUS - BRUSHED ALUMINUM	SB	GC	COORDINATE WITH DM
OTHER					
17797	1	ENERGY MANAGEMENT SYSTEM - HVAC ONLY	SB	GC	

SPECIALTY EQUIPMENT SCHEDULE - "E"					
DESIGN ID	COUNT	DESCRIPTION	FURN. BY	INST. BY	COMMENTS
COOLING					
10267	6	FRIDGE UNDERCOUNTER 1 DOOR - 27IN 685MM	SB	GC	
11083	2	FRIDGE REACH IN 2 DOOR - 51X35IN 1295X890MM	SB	GC	
12618	2	FRIDGE UNDERCOUNTER 1 DOOR WITH SHELF - 27IN 685MM	SB	GC	
13682	2	FREEZER REACH IN 2 DOOR - 54IN 1370MM	SB	GC	
20011	1	FRIDGE NITRO 2 TAP JT NITCOM RH	SB	GC	KIT INCLUDES UNDERCOUNTER FRIDGE, FONT, TRAY, AND TUBING
EQUIPMENT					
10312	4	BREWER SOFT HEAT WARMING STAND SINGLE	SB	GC	
10746	1	BREWER DUAL SOFT HEAT	SB	GC	
10808	1	GRINDER DITTING KR1203	SB	GC	
10856	6	BREWER SERVER SOFT HEAT	SB	GC	
12508	2	BLENDER QUIET MODEL ON COUNTER	SB	GC	
15186	1	DISHWASHER HOT LOW STEAM	SB	GC	
19742	2	ESPRESSO MACHINE MASTRENA II	SB	GC	
20032	2	OVEN EIKON E2S - BLACK	SB	GC	
21679	1	NITROGEN GENERATOR ELEMENT COMPACT	SB	GC	
FOOD CASE					
16238	1	FOOD CASE - ZEPHYR - 66IN 1675MM	SB	GC	
ICE					
10527	2	ICE - BIN DROP IN 45LB 20KG	SB	GC	
18029	1	ICE - BIN B110	SB	GC	
18846	1	ICE - MACHINE CIM1446HR SERIES REMOTE COOLED	SB	GC	
19278	2	ICE - BIN DROP IN 45LB 20KG HORIZONTAL	SB	GC	
OTHER					
10091	2	CUP DISPENSER TALL HOT VERTICAL	SB	GC	
10099	2	RESTROOM TOILET PAPER HOLDER	SB	GC	
10172	2	RESTROOM SEAT COVER DISPENSER	SB	GC	
10179	2	HAND DRYER SURFACE MOUNTED	SB	GC	
10384	2	DIAPER CHANGING STATION HORIZONTAL	SB	GC	
10396	2	CUP DISPENSER SHORT HOT VERTICAL	SB	GC	
10501	1	FIRE EXTINGUISHER	GC	GC	SPEC: MANUFACTURER: PRODUCT PRO 460, PART #21005785; MULTIPURPOSE DRY-CHEMICAL TYPE UL RATED 4-A, 60-B,C, 10LB, METAL STRAP BRACKET PART # 366242
10769	2	RESTROOM GRAB BAR VERTICAL - 18IN 455MM	SB	GC	
10791	4	CUP DISPENSER GRANDE VENTI COLD VERTICAL	SB	GC	
10855	4	CUP DISPENSER GRANDE VENTI HOT VERTICAL	SB	GC	
10858	2	CUP DISPENSER TALL COLD VERTICAL	SB	GC	
10859	2	RESTROOM GRAB BAR - 48IN 1220MM	SB	GC	
10862	2	RESTROOM GRAB BAR - 36IN 915MM	SB	GC	
10947	1	SOAP DISPENSER WALL MOUNTED	SB	GC	
10977	1	PAPER TOWEL DISPENSER FULL SIZE - TRANSLUCENT GRAY	SB	GC	
10992	2	PAPER TOWEL DISPENSER HALF SIZE - TRANSLUCENT GRAY	SB	GC	
11115	4	SOAP DISPENSER SINK MOUNTED	SB	GC	
13330	2	MOBILE CUP DISPENSER CADDY	SB	GC	
13584	2	CUP DISPENSER TRENTA COLD VERTICAL	SB	GC	
20403	6	KEG - 3GAL	SB	GC	
21988	2	HAND DRYER BACK PANEL	SB	GC	
22627	1	NITRO 2 TAP HANDLE WITH BADGE AND MOUNT KIT	SB	GC	JOE TAP, FOR USE AT BACKBAR NITRO FONT
STORAGE					
10222	2	WIRE SHELF GRID AT SINK	SB	GC	
10416	8	WORKROOM SHELVING - 36IN 915MM	SB	GC	
10462	8	WORKROOM SHELVING POSTS	SB	GC	
10698	1	MOP RACK WITH 3 HOLDERS	SB	GC	
13834	1	BASE - 24X18IN 610X455MM	SB	GC	
15699	1	PARTNER WORK CENTER	SB	GC	
17255	1	PASTRY TRAY CART - 60IN 1525MM	SB	GC	
17264	1	ROLLING PASTRY TRAY THAW RACK - 20X26IN 510X660MM	SB	GC	
17639	1	WORKROOM CART - 24IN 610MM	SB	GC	
TK0048	2	5 COMP LOCKER - 15IN 380MM	SB	GC	

GRAPHICS AND ARTWORK SCHEDULE - "G"					
DESIGN ID	COUNT	DESCRIPTION	FURN. BY	INST. BY	COMMENTS
GRAPHIC - FILM					
19458	12	INTERIOR WINDOW FILM FASARA - DUSTED CRYSTAL	GC	GC	SIZE REQUIRED: (V.I.F.); (6) 3' - 9 1/4" W X 2' - 10" H (6) 3' - 9 1/4" W X 6' - 8" H
GRAPHICS - ARTWORK					
X1001	1	SBXART 17141 - SEONNA HONG - RWANDA; WRAPPED CANVAS IN FLOAT FRAME; ART SIZE: 54 1/4" W X 54 1/4" H - REVEAL: 1/8" - PRINT TO EDGES - PRINT EDGES BLACK - OVERALL SIZE: 55 1/4" W X 55 1/4" H - CANVAS - 1; FRAME: 3A - FRAME 623674 EBONIZED WALNUT	SB	GC	SEE ELEVATION: 1/1-201
X1002	1	COMMUNITY BOARD MAGNETIC WITH 3/4" FRAME; 2A - EBONIZED WALNUT; OVERALL SIZE: 36" W X 46" H	SB	GC	SEE ELEVATION: 5/1-203
GRAPHICS - RESTROOM					
11135	2	RESTROOM SIGN UNISEX ACCESSIBLE	SB	GC	LOCALLY SOURCED(BLACK)

PLUMBING FIXTURE SCHEDULE - "P"					
DESIGN ID	COUNT	DESCRIPTION	FURN. BY	INST. BY	COMMENTS
DRAIN					
10294	8	DRAIN - FLOOR SINK SQUARE - 12IN 305MM	SB	GC	
10594	2	DRAIN - FLOOR SINK SQUARE - 5IN 125MM	GC	GC	ZURN ZN415B
10726	8	DRAIN - GRATE HALF SQUARE - 12IN 305MM	SB	GC	
FAUCET					
10152	1	FAUCET - DOUBLE LABORATORY WITH BENT RISER SPOUT	SB	GC	
10153	4	FAUCET - WATER TOWER - 12IN 305MM	SB	GC	
10215	2	FAUCET - DOUBLE LABORATORY WITH SWING SPOUT	SB	GC	
10447	1	FAUCET - PRE RINSE SPRAYER WALL MOUNTED	SB	GC	
10597	2	FAUCET - SINGLE HANDLE	SB	GC	0.5 GPM FLOW RATE
10804	1	FAUCET - PRE RINSE SWING SPOUT	SB	GC	
10874	1	FAUCET - HOT WATER DISPENSER GOOSENECK	SB	GC	
10922	1	FAUCET - MOP SINK WALL MOUNTED	SB	GC	
10943	1	FAUCET - SINGLE LABORATORY WITH SWING SPOUT	SB	GC	
11003	2	FAUCET - METERED	SB	GC	
13588	1	FAUCET - HAND SINK WALL MOUNTED	SB	GC	
21352	2	FAUCET - RESTROOM WITH MOTION SENSOR	SB	GC	
22642	2	FAUCET - INSTANTHOT SYSTEM 2 BUTTON WITH BOILER AND BRACKET	SB	GC	KIT INCLUDES FONT, UNDERCOUNTER BOILER AND BOILER BRACKET FOR SIDE PANEL MOUNTING. BRACKET CAN BE FLOOR MOUNTED USING SET OF (4) STAINLESS STEEL LEGS, ORDERED SEPARATELY THROUGH VENDOR.
FILTER					
12501	1	FILTER - RO SYSTEM 600GPD	SB	VD	
12507	1	FILTER - RO SYSTEM STORAGE TANK R040	SB	VD	
12896	1	FILTER - BRINE TANK	SB	VD	
12899	2	FILTER - POLY GLASS VESSEL	SB	VD	
13076	1	FILTER - PREFILTRATION SYSTEM	SB	VD	
13082	1	FILTER - WATER SOFTENER TWIN	SB	VD	
OTHER					
22224	1	WATER HEATER TANK ELECTRIC - 13.5KW	GC	GC	13.5KW BRADFORD WHITE E32-50S-3 30GAL ELECTRIC
SINK					
10116	2	SINK - RESTROOM WALL MOUNTED	SB	GC	
10549	1	SINK - RINSE DROP IN SST - 12X20IN 305X510MM	SB	GC	
10995	1	SINK - MOP - 24X24IN 610X610MM	SB	GC	
13264	1	SINK - 3 COMP WORK SST - 93IN 2350MM	SB	GC	
14688	1	SINK - HAND WITH SIDE SPLASH WALL MOUNTED SST	SB	GC	
18743	1	SINK - WATER FILLING STATION - 36X24IN 915X610MM	SB	GC	
22630	1	SINK - RINSE DROP IN - 27X26IN 685X670MM	SB	GC	
22768	2	SINK - COUNTERTOP RINSER WITH WATER TOWER - 26X9IN 660X235MM	SB	GC	
TOILET					
X8010	2	TOILET - TANK EFFICIENT SINGLE FLUSH; 1.0GPF	GC	GC	KOHLER MODEL K-3519 FINISH: WHITE #0. REQUIRES SEPARATE SEAT MODEL K-4650; 1.0 GPF

RESPONSIBILITY LEGEND

FURN. BY	INST. BY
SB - FURNISHED BY STARBUCKS	GC - INSTALLED BY GENERAL CONTRACTOR
GC - FURNISHED BY GENERAL CONTRACTOR	SB - INSTALLED BY STARBUCKS
VD - FURNISHED BY VENDOR	VD - INSTALLED BY VENDOR

NOTE:
ALL RESPONSIBILITIES TO BE CONFIRMED WITH STARBUCKS CONSTRUCTION MANAGER PRIOR TO ORDERING / CONSTRUCTION.



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FOR CONSTRUCTION

PROJECT NAME:
LECANTO HWY & NORVELL BRYANT

PROJECT ADDRESS:
**3159 W NORVELL BRYANT HWY
LECANTO, FL 34461**

STORE #: 78366
PROJECT #: 97107-001
ISSUE DATE: 09/06/2023
DESIGNER: RAI MONTERO
PRODUCTION DESIGNER: ANDY MCLCLOUD
CHECKED BY: DONALD RETHMAN



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PRODUCTION DESIGNER: ANDY MCLLOUD
CHECKED BY: DONALD RETHMAN

Revision Schedule			
Rev	Date	By	Description

SHEET TITLE:
CASEWORK PLAN


SCALE: AS SHOWN

SHEET NUMBER:
I-102


- ### GENERAL NOTES
- A. GENERAL CONTRACTOR TO NOTIFY CONSTRUCTION MANAGER IMMEDIATELY IF A DISCREPANCY EXISTS BETWEEN CASEWORK SHOP DRAWINGS, EXISTING SITE CONDITIONS, ARCHITECTURAL DRAWINGS OR BUILT FIXTURES. ALL DIMENSIONS SHALL BE FIELD VERIFIED BY GC PRIOR TO SHOP DRAWINGS PRODUCTION.
 - B. STARBUCKS CONSTRUCTION MANAGER TO COORDINATE AND SCHEDULE CASEWORK DELIVERY DATE. GENERAL CONTRACTOR TO CONFIRM CASEWORK DELIVERY DATE WITH CASEWORK MANUFACTURER AT FOUR (4) WEEKS PRIOR AND THEN ONE (1) WEEK PRIOR TO SCHEDULED DATE OF DELIVERY.
 - C. STARBUCKS CONTRACTS DIRECTLY WITH CASEWORK VENDOR TO SUPPLY CASEWORK LISTED IN THE CASEWORK SCHEDULE, UNLESS OTHERWISE NOTED.
 - D. CASEWORK VENDOR TO PROVIDE COMPLETE SHOP DRAWINGS AND INSTALLATION PACKAGE TO GENERAL CONTRACTOR TO FACILITATE PROPER INSTALLATION.
 - E. ALL CASEWORK BOX BASE / TOE KICKS SHALL BE SET AND LEVELED USING 1/4" (6 MM) NON-ABSORBENT PLASTIC SHIMS PROVIDED BY CASEWORK VENDOR.
 - F. SEE WALL FINISH PLAN FOR LOCATION, TAGGING, AND FINISH SCHEDULES OF APPLIED WALL TREATMENTS.
 - G. SEE REFLECTED CEILING PLAN FOR CASEWORK SOFFIT LOCATIONS.
 - H. REFERENCE PLUMBING AND ELECTRICAL PLANS FOR PLACEMENT OF ELECTRICAL, DATA AND PLUMBING ON FRONT AND BACKLINE OF BAR.

- ### KEYED NOTES
- 1. DO NOT CAULK TRASH RINGS TO COUNTERTOPS.
 - 2. INSTALL CONDIMENT CART AS INDICATED.
 - 3. REFER TO CASEWORK DETAIL SHEETS FOR ADDITIONAL INFORMATION.
 - 4. INSTALL MERCH BAY AS INDICATED. SECURE TO WALL.
 - 5. FLOOR SINK BELOW. CASEWORK MANUFACTURER TO COORDINATE DESIGN TO ENSURE (SP) THIS AREA IS READILY ACCESSIBLE FOR CLEANING AND FREE OF COUNTERTOP SUPPORT.
 - 6. INSTALL CASEWORK, COUNTERTOPS, SHELVES, CUBBIES, FINISHES, TRIM AND TABLE TOPS THROUGHOUT. REFERENCE FINISH SCHEDULE AND MANUFACTURER'S SPECIFICATIONS FOR ADDITIONAL INFORMATION.
 - 7. ALL COUNTERTOPS UTILIZED FOR CUSTOMER TRANSACTIONS, INCLUDING BAR, CONDIMENT AND SALES COUNTERTOPS SHALL BE INSTALLED AT 2'-10" (860 MM) MAXIMUM A.F.F.
 - 8. VARIABLE WIDTH FILLER CABINET / COUNTERTOP REQUIRED TO FILL GAP (FIELD VERIFY DIMENSION). VENDOR TO COORDINATE EXACT DIMENSION WITH GC PRIOR TO INSTALLATION.
 - 9. INSTALL DT POS CUBBY AS INDICATED.
 - 10. INSTALL CORNER GUARDS AT OUTSIDE CORNER AS INDICATED. SEE INTERIOR ELEVATIONS FOR CLARIFICATION.
 - 11. INSTALL WOOD TRIM AROUND RESTROOM VESTIBULE OPENING AS INDICATED.
 - 12. INSTALL CUSTOM WOOD TRIM AROUND MERCH BAY AS INDICATED.
 - 13. INSTALL CUSTOM WOOD TRIM AT BACKBAR DT HEADER AS INDICATED.
 - 14. INSTALL FRY REGLET "Y" TRIM AS INDICATED. SEE DETAIL ON SHEET: 17I-502.

- ### LEGEND
- INDICATES STAINLESS STEEL (SST) COUNTERTOP
 - INDICATES SOLID SURFACE (SS) COUNTERTOP
 - INDICATES CORNER GUARD @ BOH -10829
- NOTE:
SEE SHEET I-101.1 FOR DATA DEVICE SCHEDULE "A"
SEE SHEET I-103 FOR CASEWORK AND CASEWORK FINISH SCHEDULE "C"

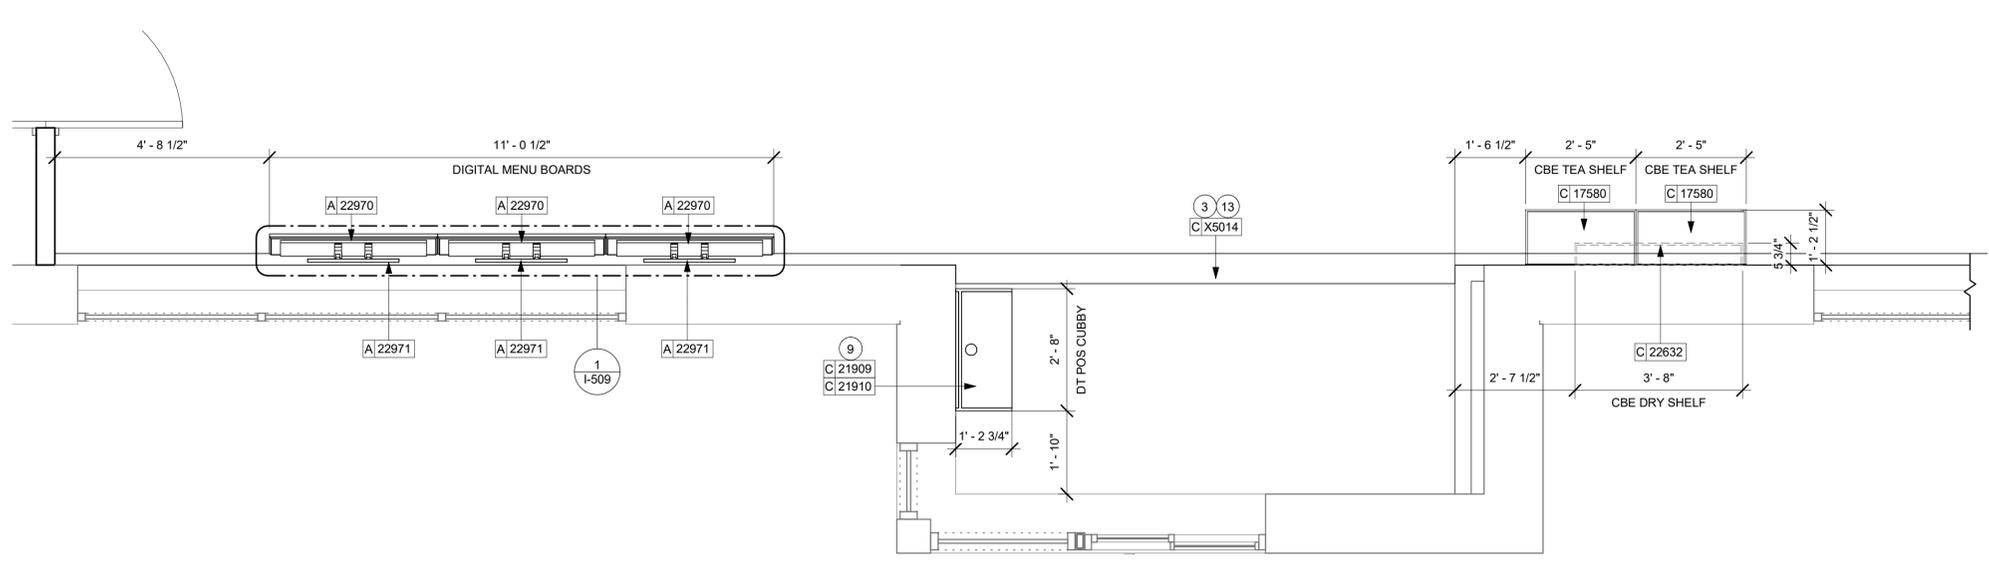

2 UPPER CASEWORK PLAN
Scale: 1/2" = 1'-0"

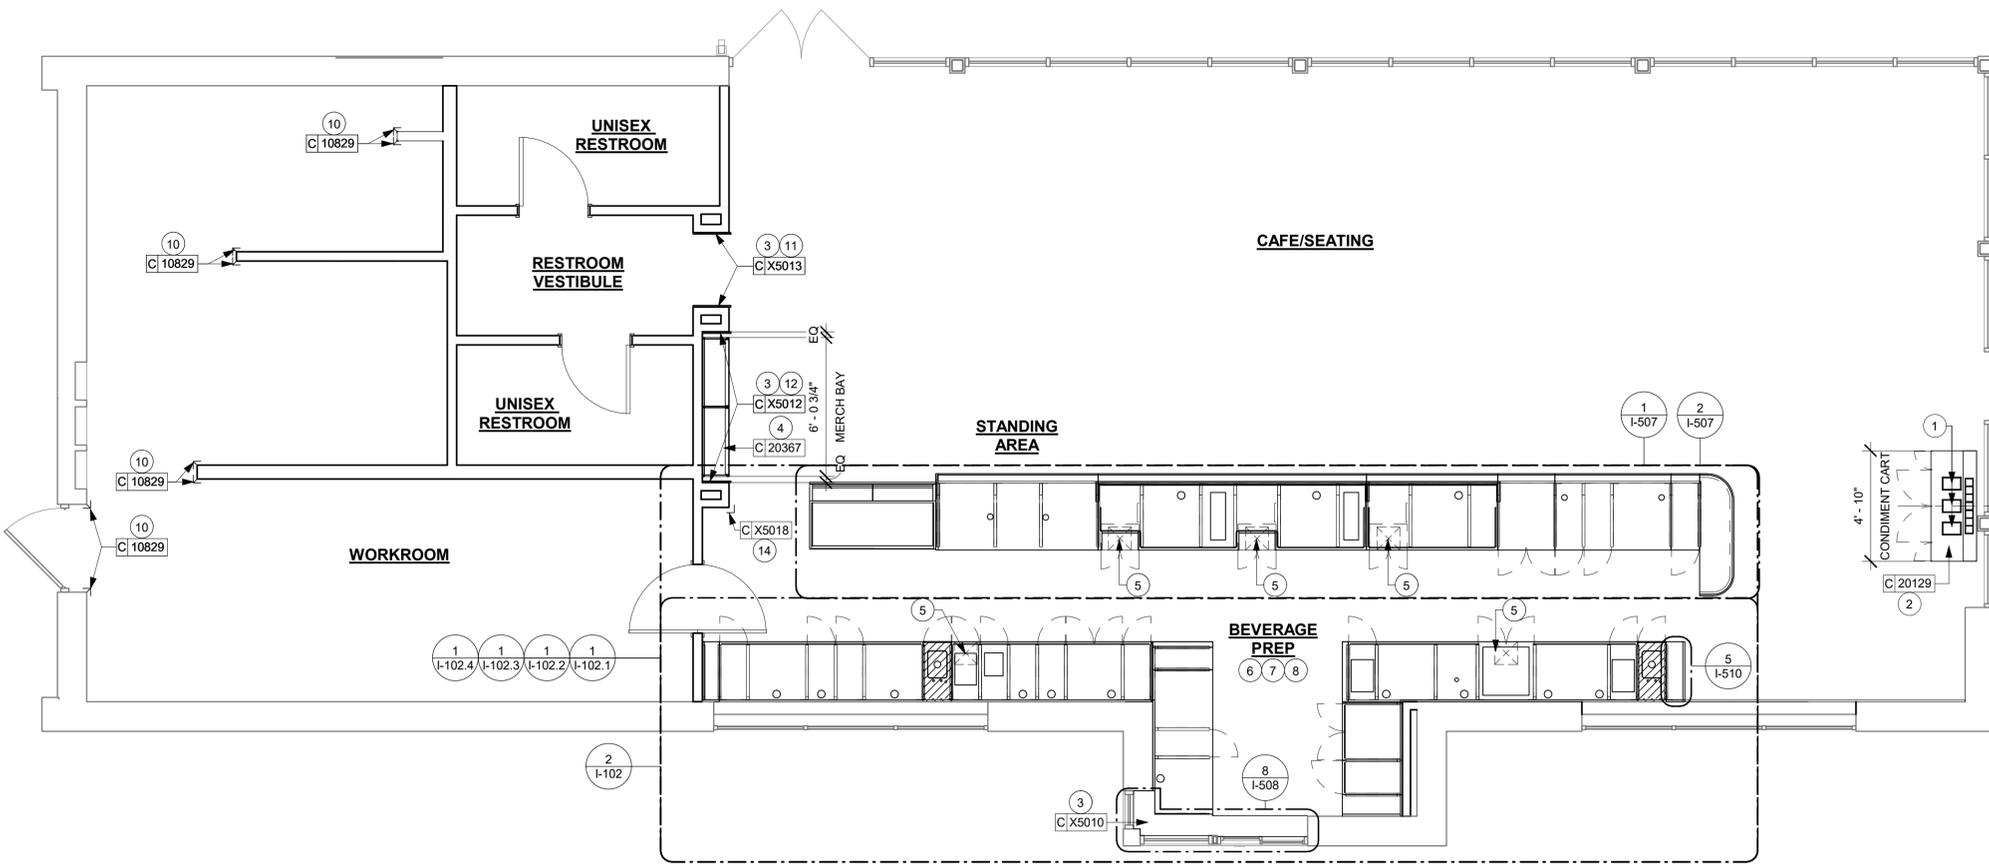

1 CASEWORK PLAN
Scale: 1/4" = 1'-0"

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ADAPTABLE CASEWORK SUPPORT LEG AND DIEWALL BASE SCHEDULE "C"					
DESIGN ID	COUNT	DESCRIPTION	FURN. BY	INST. BY	COMMENTS
DIEWALL					
21886	6	DIEWALL - BASE - VARIABLE LENGTH	SB	GC	
21888	48	DIEWALL - SUPPORT LEG	SB	GC	
X5005	1	CUSTOM DIEWALL - END CAP ROUNDED	SB	GC	SEE DETAIL: 1/I-507

GENERAL NOTES


- A. SEE SHEET I103 FOR COMPLETE CASEWORK SCHEDULE.
- B. METAL COMPONENTS PROVIDED BY CASEWORK SUPPLIER UNLESS OTHERWISE NOTED.
- C. DIEWALL AND BOX BASES TO BE INSTALLED PRIOR TO FLOORING MATERIAL INSTALLATION.
- D. G.C. TO INSTALL BLOCKING BETWEEN DIEWALL BASE.
- E. ALL DIMENSIONS TAKEN FROM FRONTLINE DATUM POINT TO OUTSIDE CORNER OF DIEWALL BASE.
- F. BOX BASE (IF APPLICABLE) BUTTS UP AGAINST INSIDE FACE OF DIEWALL. PROVIDE SEALANT AT SEAM.
- G. LEVEL BOX BASES TO BOTTOM RAIL OF WALL FRAME.

KEYED NOTES

- 1. CASEWORK FRAMEWORK ABOVE.
- 2. FOOD CASE.

LEGEND

-  VARIABLE LENGTH BOX BASE
-  CABINET LEG
-  DATUM POINT

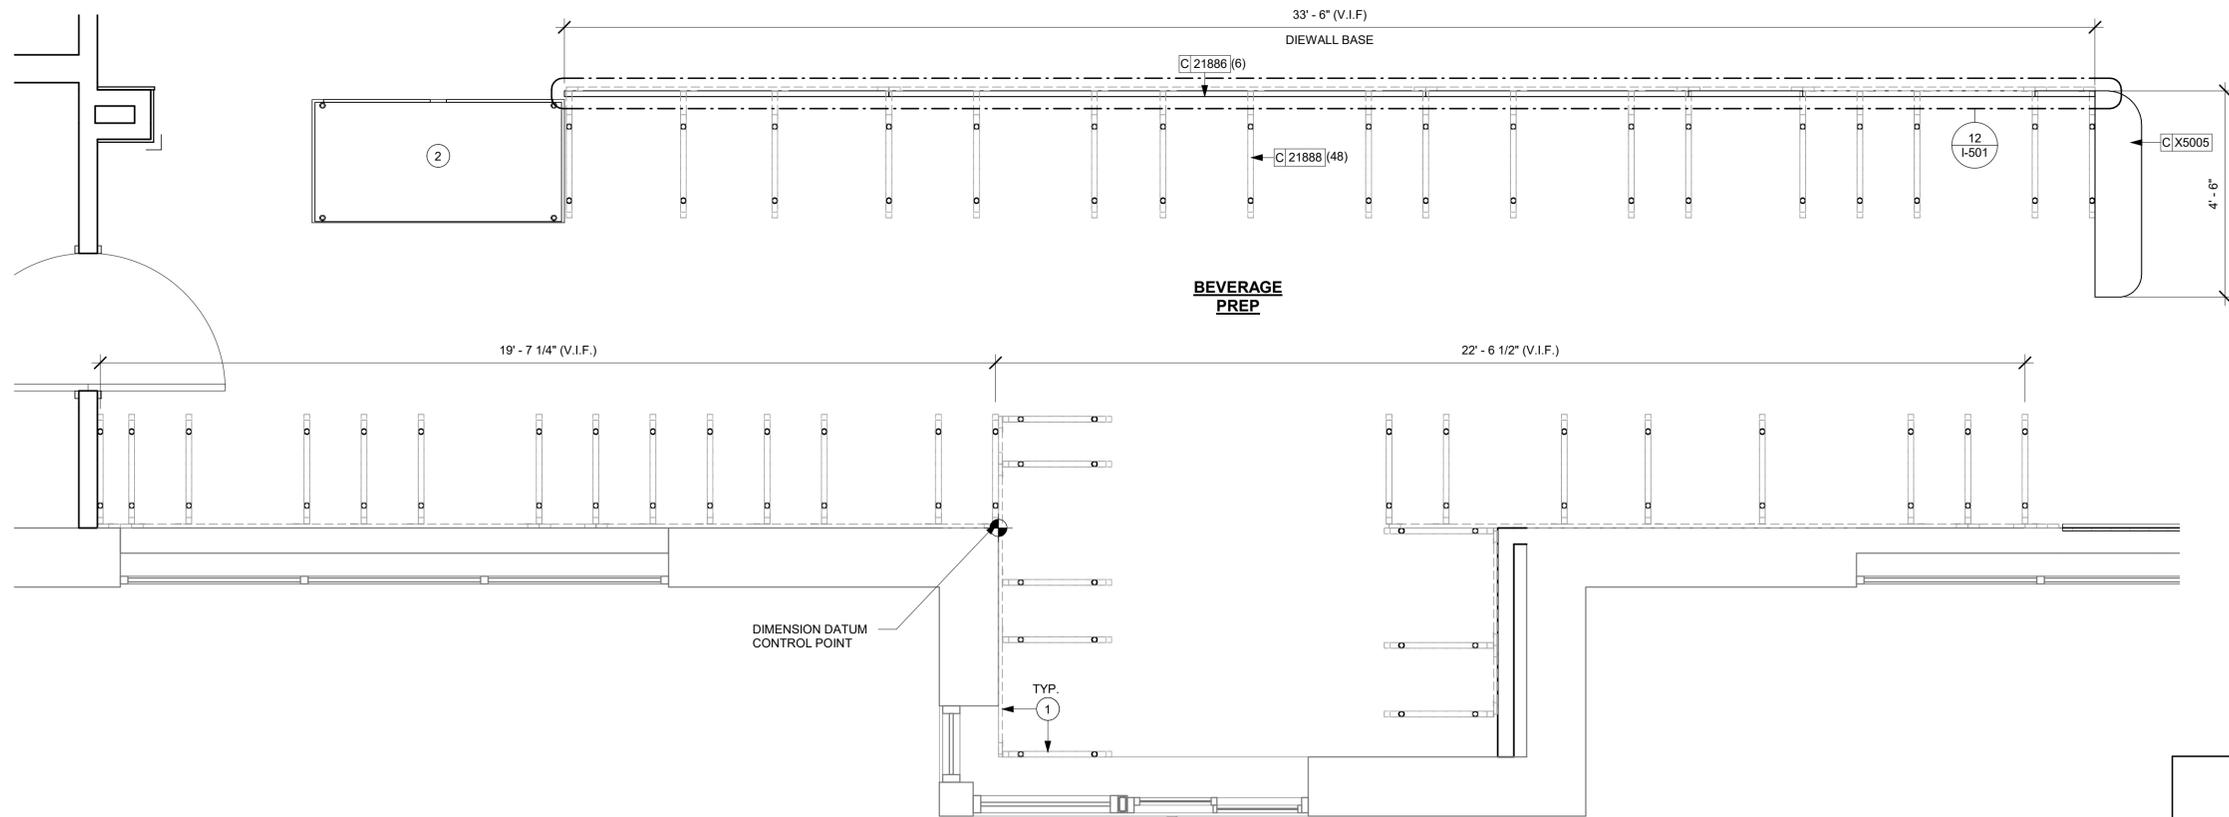

1 ADAPTABLE CASEWORK BASE PLAN
Scale: 1/2" = 1'-0"



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FOR CONSTRUCTION

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STORE #: 78366
PROJECT #: 97107-001
ISSUE DATE: 09/06/2023
DESIGNER: RAI MONTERO
PRODUCTION DESIGNER: ANDY MCLLOUD
CHECKED BY: DONALD RETHMAN

Revision Schedule			
Rev	Date	By	Description

SHEET TITLE:
ADAPTABLE CASEWORK BASE PLAN
SCALE: 1/2" = 1'-0"

SHEET NUMBER:
I-102.1

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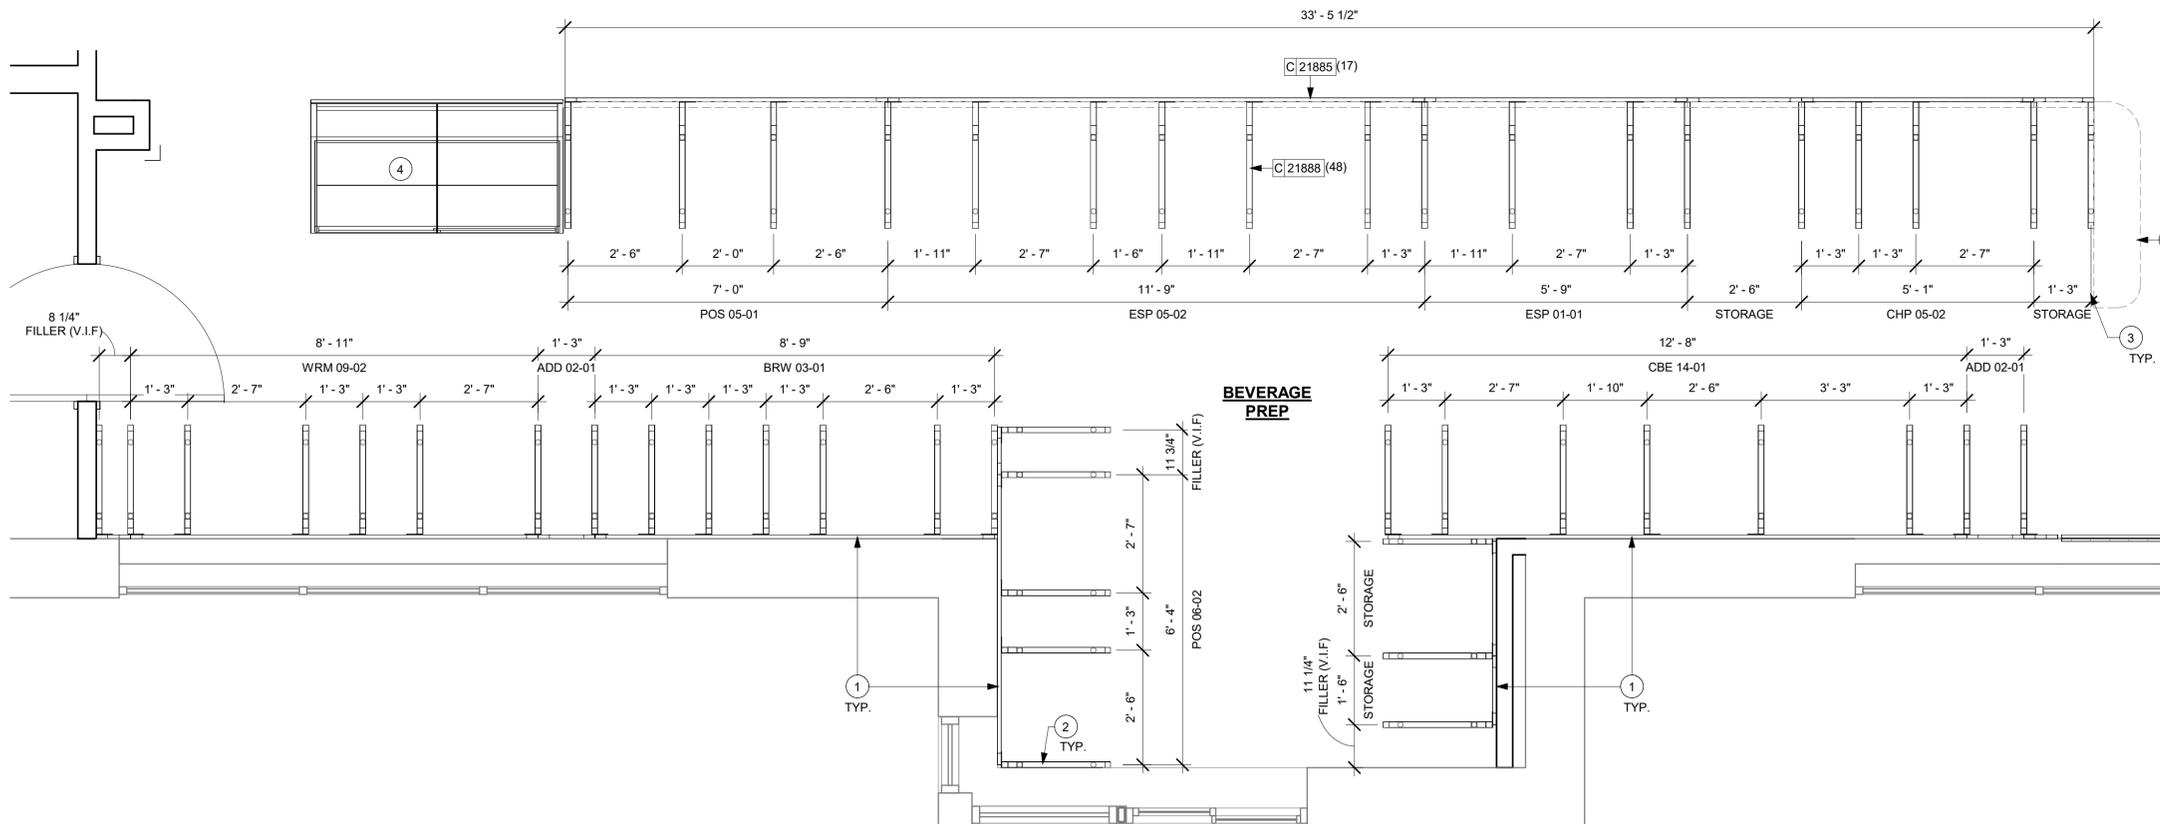
ADAPTABLE CASEWORK FRAMEWORK SCHEDULE - "C"					
DESIGN ID	COUNT	DESCRIPTION	FURN. BY	INST. BY	COMMENTS
21885	17	DIEWALL - FRAMING - VARIABLE LENGTH	SB	GC	
21888	48	DIEWALL - SUPPORT LEG	SB	GC	

GENERAL NOTES


- SEE SHEET I-103 FOR COMPLETE CASEWORK SCHEDULE.
- METAL COMPONENTS PROVIDED BY CASEWORK SUPPLIER UNLESS OTHERWISE NOTED.
- DIEWALL TO BE INSTALLED PRIOR TO FLOORING MATERIAL INSTALLATION.
- DIEWALL TO BE ANCHORED TO FLOOR WITH HARDWARE SUPPLIED BY CASEWORK VENDOR.
- G.C. TO PROVIDE CONTINUOUS WALL BLOCKING BEHIND CASEWORK. G.C. TO INSTALL BLOCKING BETWEEN DIEWALL BASE.
- CASEWORK FRAME AT BAR ENDS ARE SUPPORTED BY 90 DEGREE DIEWALL BASE.
- ALL DIMENSIONS TAKEN FROM FRONTLINE DATUM POINT TO OUTSIDE CORNER OF DIEWALL BASE.
- TOP EDGE OF DIEWALL FRAME TO BE INSTALLED AT 32 13/16" A.F.F. AT LOW POINT.
- ALL DIMENSIONS ARE TO CENTER OF CABINET FRAME UNLESS NOTED OTHERWISE.

KEYED NOTES

- PROVIDE 3/4" BLOCKING TO 34" A.F.F. FOR ALL WALL FRAMES TO SUPPORT CASEWORK LEG.
- METAL SUPPORT LEG ADJACENT TO WALL TO BE SUPPORTED BY METAL ANGLE FASTENED TO WALL PER CONSTRUCTION DETAILS.
- DIMENSIONS LOCATING SUPPORT LEG ARE TO CENTER OF FRAME.
- FOOD CASE.
- RADIUS ENDCAP. FABRICATE USING TRADITIONAL CASEWORK CONSTRUCTION.



1 ADAPTABLE CASEWORK FRAMEWORK PLAN
Scale: 1/2" = 1'-0"

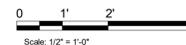

FOR CONSTRUCTION



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STORE #: 78366
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ISSUE DATE: 09/06/2023
DESIGNER: RAI MONTERO
PRODUCTION DESIGNER: ANDY MCLLOUD
CHECKED BY: DONALD RETHMAN

Revision Schedule			
Rev	Date	By	Description

SHEET TITLE:
ADAPTABLE CASEWORK FRAMEWORK PLAN
SCALE: 1/2" = 1'-0"

SHEET NUMBER:
I-102.2

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ADAPTABLE CASEWORK CABINET SCHEDULE - "C"					
DESIGN ID	COUNT	DESCRIPTION	FURN. BY	INST. BY	COMMENTS
CABINET					
17580	2	CABINET - CBE TEA SHELF - 29IN 735MM - FLAT BLACK MT0028	SB	GC	
19281	3	CABINET - ESPRESSO ICE BIN STAINLESS - 20IN 510MM	SB	GC	
21890	32	CABINET - SIDE PANEL	SB	GC	
21891	10	CABINET - BOTTOM SHELF - 15IN 380MM	SB	GC	
21892	7	CABINET - BACK PANEL - 15IN 380MM	SB	GC	
21893	7	CABINET - ADJUSTABLE SHELF - 15IN 380MM	SB	GC	
21894	9	CABINET - DOOR - 15IN 380MM	SB	GC	FINISH: CP0024
21895	6	CABINET - DOOR TRASH - 15IN 380MM	SB	GC	FINISH: CP0024
21896	2	CABINET - DRAWER - 15IN 380MM	SB	GC	FINISH: CP0024
21898	1	CABINET - BOTTOM SHELF - 18IN 455MM	SB	GC	
21899	1	CABINET - BACK PANEL - 18IN 455MM	SB	GC	
21900	1	CABINET - ADJUSTABLE SHELF - 18IN 455MM	SB	GC	
21901	1	CABINET - DOOR - 18IN 455MM	SB	GC	FINISH: CP0024
21902	7	CABINET - BOTTOM SHELF - 30IN 760MM	SB	GC	
21903	3	CABINET - BACK PANEL - 30IN 760MM	SB	GC	
21904	9	CABINET - ADJUSTABLE SHELF - 30IN 760MM	SB	GC	
21905	4	CABINET - DOOR - 30IN 760MM	SB	GC	FINISH: CP0024
21906	1	CABINET - END CAP FRONTBAR	SB	GC	
21907	2	CABINET - END CAP BACKBAR	SB	GC	
21908	4	CABINET - FILLER PANEL - VARIABLE LENGTH	SB	GC	FINISH: CP0024; REQUIRED(V.I.F) (1) 0' - 11 1/4" (1) 0' - 8 1/2" (1) 0' - 8 3/4" (1) 0' - 10 3/4"
21909	1	CABINET - DT POS UPPER CUBBY - 32IN 815MM	SB	GC	FINISH: PL0019
21910	1	CABINET - FRENCH CLEAT - VARIABLE LENGTH	SB	GC	DESIGNER TO VERIFY QUANTITY, PROVIDE OVERALL LENGTH REQUIRED.
21912	3	CABINET - BACK PANEL FOR POS - 30IN 760MM	SB	GC	
21913	5	CABINET - EQUIPMENT MOUNTING PANEL	SB	GC	
22632	1	CABINET - CBE DRY INCLUSION SHELF - 44IN 1120MM - FLAT BLACK MT0028	SB	GC	
CAFE					
20129	1	CONDIMENT CART THREE DROP - WALNUT AND WHITE WD0077 CP0002	SB	GC	
20367	1	WALL BAY 2 UNIT - 72IN 1830MM - WHITE OAK WD0073	SB	GC	
OTHER					
10829	8	CORNER GUARD - .75IN 19MM	SB	GC	LOCATED @ BOH SST
11155	3	ESPRESSO MACHINE PUMP MOUNT - 10X10IN 255X255MM	SB	GC	
21914	9	FRIDGE STOP BRACKET SET	SB	GC	
X5010	1	CUSTOM DT SILL TOP	SB	GC	FINISH: CP0030; SEE DETAIL: 8/I-508
X5012	1	CUSTOM SOLID WOOD TRIM AT MERCH	SB	GC	FINISH: WD0077; SEE DETAIL: 12/I-502
X5013	1	CUSTOM SOLID WOOD TRIM AT RR VESTIBULE	SB	GC	FINISH: WD0077; SEE DETAIL: 9/I-502
X5014	1	CUSTOM SOLID WOOD TRIM AT BACKBAR	SB	GC	FINISH: WD0077; SEE DETAIL: 7/I-502
X5018	1	FRY REGLET "Y" TRIM AT WOOD CLADDING EDGE	SB	GC	FINISH: MT0028; SEE DETAIL: 19/I-502; LOCATED @ CAFE
PANEL					

ADAPTABLE CASEWORK CABINET SCHEDULE - "C"					
DESIGN ID	COUNT	DESCRIPTION	FURN. BY	INST. BY	COMMENTS
21933	6	FINISH PANEL - VARIABLE LENGTH	SB	GC	
X5004	1	CUSTOM FINISH PANEL - END CAP	SB	GC	FINISH: WD0077 (MAD 105); SEE DETAIL: 1/I-507

ADAPTABLE CASEWORK SUBSTRATE PANEL SCHEDULE - "C"					
DESIGN ID	COUNT	DESCRIPTION	FURN. BY	INST. BY	COMMENTS
21887	6	DIEWALL - SUBSTRATE PANEL - VARIABLE LENGTH	SB	GC	

ADAPTABLE CASEWORK CABINET TYPES AND BILL OF MATERIALS SCHEDULE										
KEY NUMBER	CABINET TYPE	FULL HT. DOORS	3/4 DOOR	3/4 DOOR W/ VENT	DRAWER	BOTTOM SHELF	ADJUST. SHELF	BACK PANEL	SIDE PANELS	BOX BASE**
101	15" STORAGE	1 DID 21894	N/A	N/A	N/A	1 DID 21891	1 DID 21893	1 DID 21892	2** DID 21890	NO
102	18" STORAGE	1 DID 21901	N/A	N/A	N/A	1 DID 21898	1 DID 21900	1 DID 21899	2** DID 21890	NO
103	30" STORAGE	2 DID 21905	N/A	N/A	N/A	1 DID 21902	1 DID 21904	1 DID 21903	2** DID 21890	NO
104	30" POS	N/A	N/A	N/A	N/A	1 DID 21902	1 DID 21904	1 DID 21912	2** DID 21890	NO
106	15" DRAWER	N/A	1 DID 21895	N/A	1 DID 21896	1 DID 21891	1 DID 21893	1 DID 21892	2** DID 21890	NO
108	15" CUBBY - COFFEE	N/A	N/A	N/A	N/A	1 DID 21891	1 DID 21893	1 DID 21892	2** DID 21890	NO
109	15" CUBBY - TRASH	N/A	1/0" DID 21895	N/A	N/A	N/A	0	0	2** DID 21890	NO
110	15" SINK	1/0" DID 21894	N/A	N/A	N/A	1 ^A DID 21891	0	0	0 (1,2)** DID 21890	NO
111	ICE BIN	1/0" DID 21904	N/A	N/A	N/A	N/A	0	0	0 (1,2)** DID 21890	NO
112	24" SAFE	N/A	N/A	N/A	N/A	N/A	0	0	0 (1,2)** DID 21890	NO
113	30" REFRIGERATOR	N/A	N/A	N/A	N/A	N/A	0	0	0 (1,2)** DID 21890	NO

* DOOR NOT REQUIRED WHERE CUSTOMER VIEW IS LIMITED OR NEGLIGIBLE (i.e. FRONTLINE OR BEHIND WALLS)

** SIDE PANEL QUANTITY SHOWN IS FOR STAND-ALONE CABINETS; ACTUAL SIDE PANEL QUANTITY IS DEPENDENT ON ADJACENT CABINET TYPE AS SIDE PANELS CAN BE SHARED.

^A BOTTOM SHELF AND BOX BASE (IF APPLICABLE), SHOULD BE REMOVED AT SINK/ICE BIN CABINETS WITH FLOOR SINK LOCATED...


** BOX BASE TO BE PROVIDED AT SPECIFIC CABINETS WHEN REQUIRED BY JURISDICTIONAL CODE OR LOCAL OPERATOR PREFERENCE (NOTED AS "YES")

GENERAL NOTES


- SEE SHEET I-103 FOR COMPLETE CASEWORK SCHEDULE.
- ALL DIMENSIONS ARE TO CENTER OF FRAME ASSEMBLY.
- CABINET PANELS:
 - ALL CABINET SHELVING TO BE SECURED TO METAL COMPONENTS WITH #8 ROUND HEAD SCREWS.
 - ALL METAL COMPONENTS SHALL BE SECURED TO FRAME ASSEMBLY AT KEY HOLE LOCATIONS.
 - BOTTOM FLASHING SECURED TO HDPE WITH SILICONE.
- SUBSTRATE PANELS:
 - SUBSTRATE PANELS SHALL BE MEDEX.
 - CASEWORK VENDOR SHALL PROVIDE ALL SUB PANELS TO BE CUT TO SIZE PRIOR TO SHIPPING.
 - CASEWORK VENDOR SHALL APPLY Z-CLIPS TO FINISH PANELS PRIOR TO SHIPPING.
 - FRONTLINE PANELS TO BE SECURED TO SUBSTRATE VIA Z-CLIP APPLICATION.
 - PANEL INSTALLATION TO START AT OUTSIDE CORNER LOCATIONS.
 - END PANELS TO BE SCRIBED ON SITE.
 - ALL PANEL CUT-OUTS SHALL BE FINISHED ALL.
 - Z-CLIPS TO BE INSTALLED 1" AWAY FROM PANEL EDGE.

KEYED NOTES

- NITRO EQUIPMENT LOCATION.
- FOOD CASE.
- FILLER FINISH PANEL TO BE SHIPPED LONGER THAN DIMENSIONED AND CUT TO FIT IN FIELD.
- CASEWORK SUPPLIER TO PROVIDE ADDITIONAL BACKER SUBSTRATE TO ALIGN END CAP PANEL TO ADJACENT DOOR FACES.

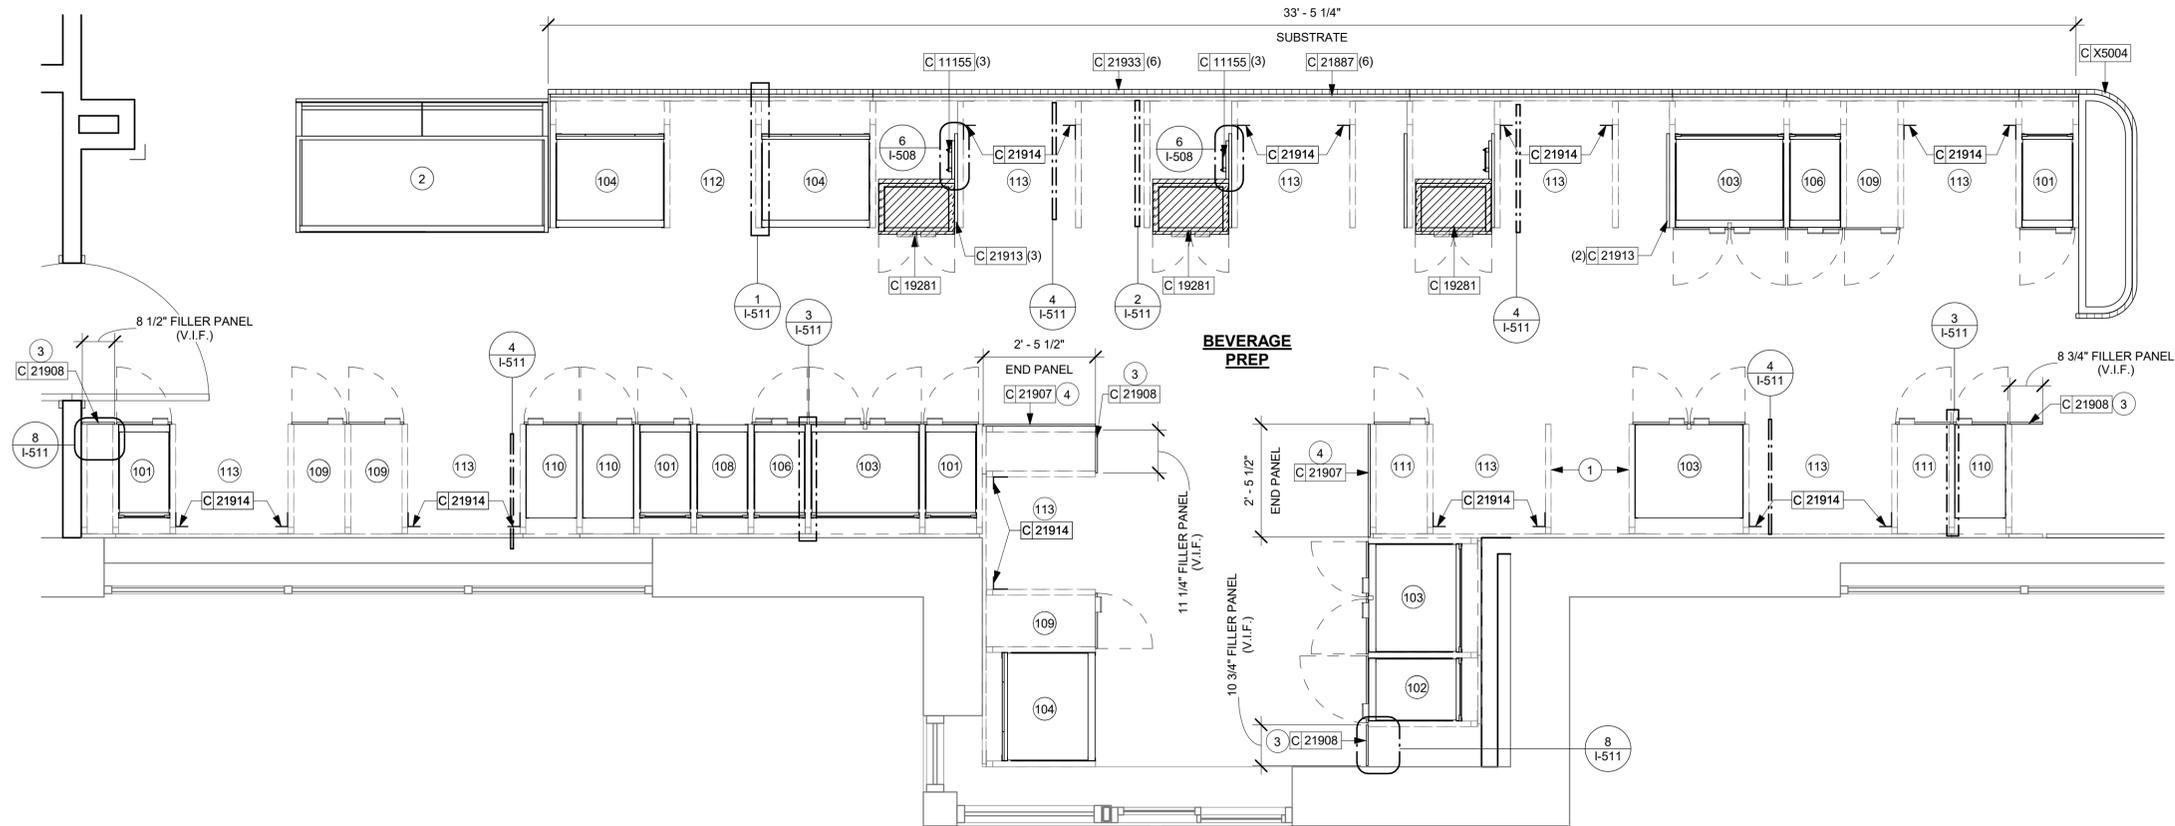

1 ADAPTABLE CASEWORK CABINET PLAN
Scale: 1/2" = 1'-0"

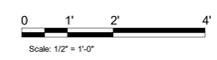

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FOR CONSTRUCTION

PROJECT NAME:
LECANTO HWY & NORVELL BRYANT

PROJECT ADDRESS:
**3159 W NORVELL BRYANT HWY
LECANTO, FL 34461**

STORE #: 78366
PROJECT #: 97107-001
ISSUE DATE: 09/06/2023
DESIGNER: RAI MONTERO
PRODUCTION DESIGNER: ANDY MCLLOUD
CHECKED BY: DONALD RETHMAN

Revision Schedule			
Rev	Date	By	Description

SHEET TITLE:
ADAPTABLE CASEWORK CABINET PLAN
SCALE: 1/2" = 1'-0"

SHEET NUMBER:
I-102.3

BLD202323715

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ADAPTABLE CASEWORK COUNTERTOP SCHEDULE - "C"					
DESIGN ID	COUNT	DESCRIPTION	FURN. BY	INST. BY	COMMENTS
COUNTERTOP					
21919	6	COUNTERTOP - FILLER BACKBAR - VARIABLE LENGTH	SB	GC	FINISH: CP0030; LENGTH REQUIRED: (V.I.F) (1) 0' - 11 3/4" (1) 0' - 9" (3) 0' - 3/4" (1) 0' - 11 1/4"
21920	1	COUNTERTOP - FRONTBAR - 15IN 380MM	SB	GC	FINISH: CP0030
21922	1	COUNTERTOP - FRONTBAR - 30IN 760MM	SB	GC	FINISH: CP0030
21923	1	COUNTERTOP - END CAP FRONTBAR	SB	GC	FINISH: CP0030
21926	1	COUNTERTOP - BACKBAR - 18IN 455MM	SB	GC	FINISH: CP0030
21927	1	COUNTERTOP - BACKBAR - 30IN 760MM	SB	GC	FINISH: CP0030
21928	2	COUNTERTOP - END CAP BACKBAR	SB	GC	FINISH: CP0030
22330	1	COUNTERTOP - BREW - LF - 105IN 2665MM	SB	GC	FINISH: CP0030
22353	1	COUNTERTOP - ESPRESSO FRONTBAR - RF - 141IN 3580MM	SB	GC	FINISH: CP0030
22354	1	COUNTERTOP - ESPRESSO SHROUD - 141IN 3580MM	SB	GC	FINISH: CP0030
22361	1	COUNTERTOP - POS - 84IN 2135MM	SB	GC	FINISH: CP0030
22362	1	COUNTERTOP - DT POS - LF - 76IN 1930MM	SB	GC	FINISH: CP0030
22378	1	COUNTERTOP - WARMING - LF - 107IN 2720MM	SB	GC	FINISH: CP0030
22391	1	COUNTERTOP - CONSOLIDATED HANDOFF - 61IN 1550MM	SB	GC	FINISH: CP0030
22394	2	COUNTERTOP - BACKSPLASH - VARIABLE LENGTH	SB	GC	FINISH: CP0030; LENGTH REQUIRED: (V.I.F) (2) 2' - 6 1/2"
22396	2	COUNTERTOP - HAND SINK TALL SPLASH - 15IN 380MM	SB	GC	
22636	1	COUNTERTOP - CBE - RF - 152IN 3860MM	SB	GC	FINISH: CP0030
X5001	1	CUSTOM COUNTERTOP - ESPRESSO FRONTBAR - LF - 69IN 1755MM	SB	GC	FINISH: CP0030; SEE DETAIL : 2/I-507
X5002	1	CUSTOM COUNTERTOP - ESPRESSO SHROUD - 69IN 1755MM	SB	GC	FINISH: CP0030; SEE DETAIL : 2/I-507
X5003	1	CUSTOM COUNTERTOP - FRONT BAR END CAP	SB	GC	FINISH: CP0030; SEE DETAIL : 2/I-507
X5006	1	CUSTOM COUNTERTOP - ADD BACKBAR WITH WATERFALL EDGE	SB	GC	FINISH: CP0030; SEE DETAIL : 5/I-510
X5008	2	CUSTOM COUNTERTOP - 2IN BACKSPLASH - VARIABLE LENGTH	SB	GC	FINISH: CP0030; REQUIRED: (V.I.F) (1) 2' - 6 1/2" (1) 1' - 1 1/2"

GENERAL NOTES


- A. SEE SHEET I-103 FOR COMPLETE CASEWORK SCHEDULE.
- B. G.C.'S INSTALLER SHALL VERIFY COUNTER CHANNEL REQUIREMENTS PRIOR TO CUTTING IN FIELD.
- C. G.C./INSTALLER TO VERIFY COUNTERTOP SUPPORT CHANNEL MEASUREMENTS PRIOR TO CUTTING. FIELD CUT AT SINKS AND ICE BINS.
- D. "C" CHANNEL MOUNTS OVER FRONT AND REAR INDEX BRACKETS WHICH ARE INSERTED INTO FRAMEWORK.
- E. SILICONE SEAM AT TRANSITION FROM COUNTERTOP TO HAND SINKS.
- F. SILICONE AND SEAL ALL SEAMS BETWEEN SINKS, EQUIPMENT AND COUNTERTOPS.
- G. ONCE COUNTERTOP IS SET, LEVELED AND SEALED, SECURE CHANNEL TO UNDERSIDE OF SUBSTRATE.

KEYED NOTES


- 1. CASEWORK FRAME BELOW.
- 2. LOCATE WATER TROUGH AT EDGE OF COUNTERTOP AS SHOWN.
- 3. RAISED EDGE GROMMETS.
- 4. CORIAN SHROUD AT ESPRESSO BAR.
- 5. CUT OUT FOR RECESSED SINK, ICE BIN OR TRASH DROP. SEE EQUIPMENT AND/OR MANUFACTURER'S CUTSHEETS FOR DIMENSIONS.
- 6. FOOD CASE.

LEGEND

- INDICATES STAINLESS STEEL (SST) COUNTERTOP
- INDICATES SOLID SURFACE (SS) COUNTERTOP

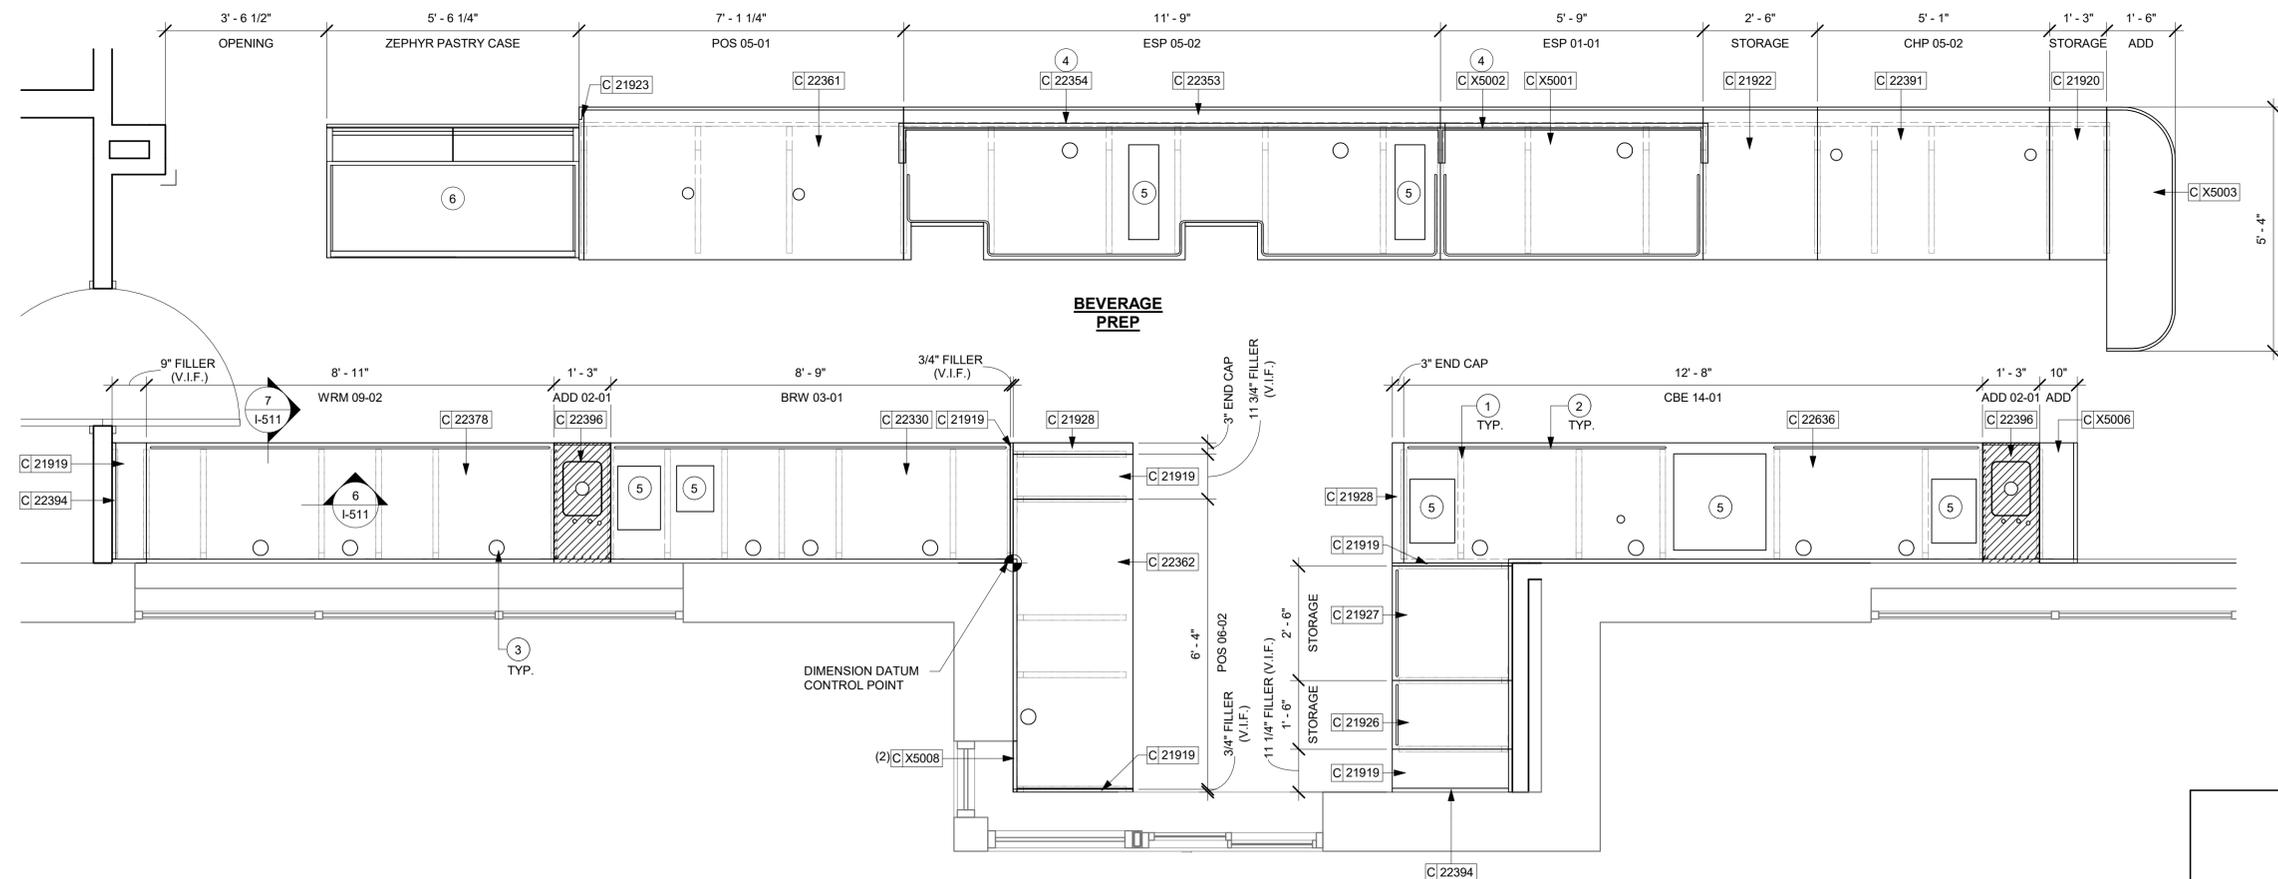

1 ADAPTABLE CASEWORK COUNTERTOP PLAN
Scale: 1/2" = 1'-0"

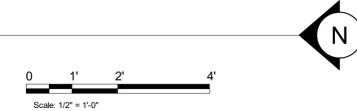

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Revision Schedule			
Rev	Date	By	Description

SHEET TITLE:
ADAPTABLE CASEWORK COUNTERTOP PLAN
SCALE: 1/2" = 1'-0"

SHEET NUMBER:
I-102.4

BLD202323715

CASEWORK SCHEDULE - "C"					
DESIGN ID	COUNT	DESCRIPTION	FURN. BY	INST. BY	COMMENTS
CABINET					
17580	2	CABINET - CBE TEA SHELF - 29IN 735MM - FLAT BLACK MT0028	SB	GC	
19281	3	CABINET - ESPRESSO ICE BIN STAINLESS - 20IN 510MM	SB	GC	
21890	32	CABINET - SIDE PANEL	SB	GC	
21891	10	CABINET - BOTTOM SHELF - 15IN 380MM	SB	GC	
21892	7	CABINET - BACK PANEL - 15IN 380MM	SB	GC	
21893	7	CABINET - ADJUSTABLE SHELF - 15IN 380MM	SB	GC	
21894	9	CABINET - DOOR - 15IN 380MM	SB	GC	FINISH: CP0024
21895	6	CABINET - DOOR TRASH - 15IN 380MM	SB	GC	FINISH: CP0024
21896	2	CABINET - DRAWER - 15IN 380MM	SB	GC	FINISH: CP0024
21898	1	CABINET - BOTTOM SHELF - 18IN 455MM	SB	GC	
21899	1	CABINET - BACK PANEL - 18IN 455MM	SB	GC	
21900	1	CABINET - ADJUSTABLE SHELF - 18IN 455MM	SB	GC	
21901	1	CABINET - DOOR - 18IN 455MM	SB	GC	FINISH: CP0024
21902	7	CABINET - BOTTOM SHELF - 30IN 760MM	SB	GC	
21903	3	CABINET - BACK PANEL - 30IN 760MM	SB	GC	
21904	9	CABINET - ADJUSTABLE SHELF - 30IN 760MM	SB	GC	
21905	4	CABINET - DOOR - 30IN 760MM	SB	GC	FINISH: CP0024
21906	1	CABINET - END CAP FRONTBAR	SB	GC	
21907	2	CABINET - END CAP BACKBAR	SB	GC	
21908	4	CABINET - FILLER PANEL - VARIABLE LENGTH	SB	GC	FINISH: CP0024; REQUIRED: (V.I.F) (1) 0' - 11 1/4" (1) 0' - 8 1/2" (1) 0' - 8 3/4" (1) 0' - 10 3/4"
21909	1	CABINET - DT POS UPPER CUBBY - 32IN 815MM	SB	GC	FINISH: PL0019
21910	1	CABINET - FRENCH CLEAT - VARIABLE LENGTH	SB	GC	DESIGNER TO VERIFY QUANTITY, PROVIDE OVERALL LENGTH REQUIRED.
21912	3	CABINET - BACK PANEL FOR POS - 30IN 760MM	SB	GC	
21913	5	CABINET - EQUIPMENT MOUNTING PANEL	SB	GC	
22632	1	CABINET - CBE DRY INCLUSION SHELF - 44IN 1120MM - FLAT BLACK MT0028	SB	GC	
CAFE					
20129	1	CONDIMENT CART THREE DROP - WALNUT AND WHITE WD0077 CP0002	SB	GC	
20367	1	WALL BAY 2 UNIT - 72IN 1830MM - WHITE OAK WD0073	SB	GC	
COUNTERTOP					
21919	6	COUNTERTOP - FILLER BACKBAR - VARIABLE LENGTH	SB	GC	FINISH: CP0030; LENGTH REQUIRED: (V.I.F) (1) 0' - 11 3/4" (1) 0' - 9" (3) 0' - 3/4" (1) 0' - 11 1/4"
21920	1	COUNTERTOP - FRONTBAR - 15IN 380MM	SB	GC	FINISH: CP0030
21922	1	COUNTERTOP - FRONTBAR - 30IN 760MM	SB	GC	FINISH: CP0030
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X5003	1	CUSTOM COUNTERTOP - FRONT BAR END CAP	SB	GC	FINISH: CP0030; SEE DETAIL : 2/I-507
X5006	1	CUSTOM COUNTERTOP - ADD BACKBAR WITH WATERFALL EDGE	SB	GC	FINISH: CP0030; SEE DETAIL : 5/I-510
X5008	2	CUSTOM COUNTERTOP - 2IN BACKSPLASH - VARIABLE LENGTH	SB	GC	FINISH: CP0030; REQUIRED: (V.I.F) (1) 2' - 6 1/2" (1) 1' - 1 1/2"
DIEWALL					
21885	17	DIEWALL - FRAMING - VARIABLE LENGTH	SB	GC	
21886	6	DIEWALL - BASE - VARIABLE LENGTH	SB	GC	
21887	6	DIEWALL - SUBSTRATE PANEL - VARIABLE LENGTH	SB	GC	
21888	48	DIEWALL - SUPPORT LEG	SB	GC	
X5005	1	CUSTOM DIEWALL - END CAP ROUNDED	SB	GC	SEE DETAIL: 1/I-507
OTHER					
10829	8	CORNER GUARD - 75IN 19MM	SB	GC	LOCATED @ BOH SST
11155	3	ESPRESSO MACHINE PUMP MOUNT - 10X10IN 255X255MM	SB	GC	
21914	9	FRIDGE STOP BRACKET SET	SB	GC	
X5010	1	CUSTOM DT SILL TOP	SB	GC	FINISH: CP0030; SEE DETAIL: 8/I-508
X5012	1	CUSTOM SOLID WOOD TRIM AT MERCH	SB	GC	FINISH: WD0077; SEE DETAIL: 12/I-502
X5013	1	CUSTOM SOLID WOOD TRIM AT RR VESTIBULE	SB	GC	FINISH: WD0077; SEE DETAIL: 9/I-502
X5014	1	CUSTOM SOLID WOOD TRIM AT BACKBAR	SB	GC	FINISH: WD0077; SEE DETAIL: 7/I-502
X5018	1	FRY REGLET "Y" TRIM AT WOOD CLADDING EDGE	SB	GC	FINISH: MT0028; SEE DETAIL: 19/I-502; LOCATED @ CAFE
PANEL					
21933	6	FINISH PANEL - VARIABLE LENGTH	SB	GC	
X5004	1	CUSTOM FINISH PANEL - END CAP	SB	GC	FINISH: WD0077 (MAD 105); SEE DETAIL : 1/I-507

CW FINISH - NCS			
LOCATION	DESCRIPTION	FINISH CODE	COMMENTS
CABINETS			
DT POS CUBBY	PLASTIC LAMINATE - MOTTLED BLACK	PL0019	
UNDERCOUNTER CABINET BACKBAR	COMPOSITE - BLACK DIAMOND PAPERSTONE	CP0024	
UNDERCOUNTER CABINET FRONTBAR	COMPOSITE - BLACK DIAMOND PAPERSTONE	CP0024	
UNDERCOUNTER CABINET INTERIOR	PLASTIC LAMINATE - WHITE HDPE	PL0043	
CAFE			
CONDIMENT CART TOP	COMPOSITE - WHITE WITH VEINING	CP0002	
COUNTERTOPS - BACKBAR			
ADD, CBE AND NITRO COUNTERTOPS	COMPOSITE - WHISPER	CP0030	
DT POS, BREW AND WARM COUNTERTOPS	COMPOSITE - WHISPER	CP0030	
HAND SINK COUNTERTOP	STAINLESS STEEL - BRUSHED	#4 BRUSHED 16GA SST	
COUNTERTOPS - FRONT BAR			
CHP, END CAP AND ADD COUNTERTOPS	COMPOSITE - WHISPER	CP0030	
ESPRESSO AND POS COUNTERTOPS	COMPOSITE - WHISPER	CP0030	
FINISH PANELS			
CHP, END CAP AND ADD FINISH PANELS	WOOD - WALNUT - PEAKS - VERTICAL	WD0077	MAD105-V
CONDIMENT CART FINISH PANELS	WOOD - WALNUT	WD0077	
ESPRESSO AND POS FINISH PANELS	WOOD - WALNUT - PEAKS - VERTICAL	WD0077	MAD105-V
FINISH PANEL TRIM DETAIL	METAL - HOT ROLLED STEEL	MT0011	
OTHER			
DT WINDOW SILL TOP	COMPOSITE - WHISPER	CP0030	
SHROUD	COMPOSITE - WHISPER	CP0030	
WOOD CLADDING @ CAFE AND SOFFIT	WOOD - WALNUT - PLANK - VERTICAL	WD0077	MAD100-V FULL HEIGHT
WOOD TRIM	WOOD - WALNUT	WD0077	

RESPONSIBILITY LEGEND

FURN. BY	INST. BY
SB - FURNISHED BY STARBUCKS	GC - INSTALLED BY GENERAL CONTRACTOR
GC - FURNISHED BY GENERAL CONTRACTOR	SB - INSTALLED BY STARBUCKS
VD - FURNISHED BY VENDOR	VD - INSTALLED BY VENDOR

NOTE:
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SHEET TITLE:
CASEWORK SCHEDULES


SCALE: NO SCALE

SHEET NUMBER:

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WALL BASE SCHEDULE - "B"					
DESIGN ID	LENGTH	DESCRIPTION	FURN. BY	INST. BY	COMMENTS
BASE TRIM					
X9100	34' - 6 1/2"	FLOOR FRAME 16 GA 2B SS AROUND CUSTOM WALK-OFF MAT RECESSED	GC	GC	SOURCED FROM VD; SEE DETAIL: 1/I-501
TILE BASE					
19795	232' - 11 1/2"	POLYVINYL TILE BASE SHEET - ECO-GRIP - PEWTER - 6X96IN 150X2438MM	GC	GC	
20218	103' - 2"	TILE BASE - ECOCRETE - AQUA - 6X12IN 150X300MM	SB	GC	GROUT: MAPEI - 02 PEWTER, OR EQUAL
X9101	58' - 0 1/2"	SCHLUTER BASE - DILEX - AHK TRIM	GC	GC	SCHLUTER SYSTEM WILL REQUIRE USE OF 90 DEGREE CORNER PIECE TO ACCOMMODATE FOR RADIUS TRIM PROFILE.

FLOOR TREATMENT SCHEDULE - "T"					
DESIGN ID	AREA	DESCRIPTION	FURN. BY	INST. BY	COMMENTS
CONCRETE					
11377	1290 SF	CONCRETE - NATURAL POLISHED	GC	GC	
TILE					
19795	952 SF	POLYVINYL FLOOR SHEET - ECO-GRIP - PEWTER - 6X96IN 1524X2438MM	GC	GC	
WALK OFF MAT					
19288	39 SF	WALK OFF MAT - HELIX Z1 - BLACK - 12X9IN 305X230MM	SB	GC	(1) 3" X 40"; (1) 3" X 76"; (4) 2" X 45"; PAINT CONCRETE FLOOR UNDER WALK-OFF MAT WITH BLACK PAINT

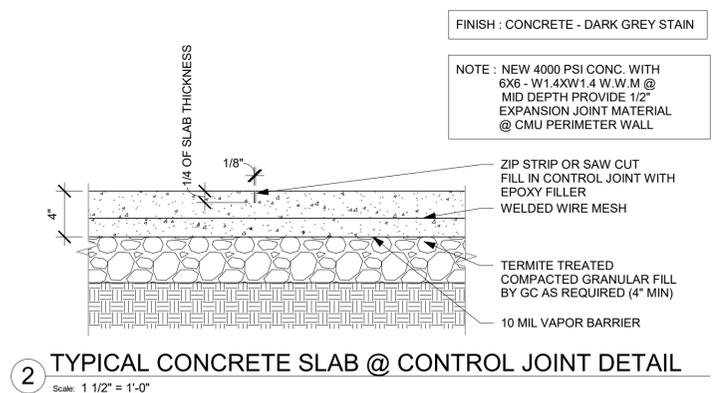


LEGEND		
	CONCRETE - NATURAL POLISHED	T 11377
	WALK OFF MAT - HELIX Z1 - BLACK - 12X9IN 305X230MM	T 19288
	POLYVINYL SHEET FLOORING - ECO-GRIP - PEWTER - 60X96IN 1524X2438MM	T 19795
	POLYVINYL SHEET BASE - ECO-GRIP - PEWTER - 6X96IN 150X2438MM	B 19795
	TILE BASE - ECOCRETE - AQUA - 6X12IN 150X300MM	B 20218
	SCHLUTER BASE - DILEX - AHK TRIM	B X9101
	DATUM POINT	
	CONTROL JOINT	

RESPONSIBILITY LEGEND	
FURN. BY	INST. BY
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GC - FURNISHED BY GENERAL CONTRACTOR	SB - INSTALLED BY STARBUCKS
VD - FURNISHED BY VENDOR	VD - INSTALLED BY VENDOR

NOTE: ALL RESPONSIBILITIES TO BE CONFIRMED WITH STARBUCKS CONSTRUCTION MANAGER PRIOR TO ORDERING / CONSTRUCTION.

- ### GENERAL NOTES
- FLOORS, WALLS AND CEILING FINISHES IN FOOD PREPARATION AREAS SHALL BE SMOOTH, NON-TOXIC, NON-ABSORBENT, DURABLE AND EASILY CLEANABLE. PAINT SHALL BE WASHABLE; SEMI-GLOSS OR HIGH-GLOSS FINISH.
 - STARBUCKS TO SUPPLY RETAIL FLOOR TILE AND TILE BASE. GENERAL CONTRACTOR TO INSTALL. GENERAL CONTRACTOR TO SUPPLY WORKROOM TILE AND BASE AND INSTALL. GENERAL CONTRACTOR TO SUPPLY AND INSTALL MORTAR, ADHESIVE, AND GROUT. GENERAL CONTRACTOR TO INSPECT ALL TILES AND REJECT DAMAGED OR SUBSTANDARD TILES PRIOR TO INSTALLATION.
 - ALIGN TILE TRANSITIONS ON WHOLE TILES AS SHOWN.
 - ALL FLOOR AND WALL JUNCTIONS IN STORAGE AND FOOD PREPARATION AREAS SHALL HAVE A 6" COVED BASE.
- ### KEYED NOTES
- INSTALL POLISHED CONCRETE FLOORING AT CAFE, RESTROOMS AND RESTROOM VESTIBULE AS INDICATED.
 - INSTALL HELIX Z1 WALK-OFF MAT AT MAIN ENTRY AS INDICATED. CUT OUT CONCRETE AS REQUIRED PER MANUFACTURER'S SPECIFICATIONS.
 - INSTALL CUSTOM METAL ALUMINUM TRIM AROUND WALK-OFF MAT AS INDICATED.
 - PASTRY CASE FOOTPRINT.
 - FLOOR SINK LOCATION. SEE BUILDING FLOOR PENETRATION PLAN ON SHEET A-102 AND PLUMBING FOR ADDITIONAL INFORMATION.
 - INSTALL POLYVINYL FLOORING AND BASE AT BACKBAR AND WORKROOM AS INDICATED.
 - POLYVINYL START POINT WHERE INDICATED.
 - INSTALL TILE BASE AT CAFE AND RESTROOM VESTIBULE AS INDICATED.
 - CONTROL JOINT IN CONCRETE SLAB BY GC.
 - DUPLEX FLOOR OUTLET. COORDINATE FLOOR RECEPTACLE LOCATION WITH TABLE LEG AND BANQUETTE SEATING.
 - INSTALL SCHLUTER BASE AT RESTROOMS AS INDICATED.
 - FLOOR TRANSITION ALIGN WITH CASEWORK DIEWALL.
 - FLOOR TRANSITION ALIGN WITH WALL.

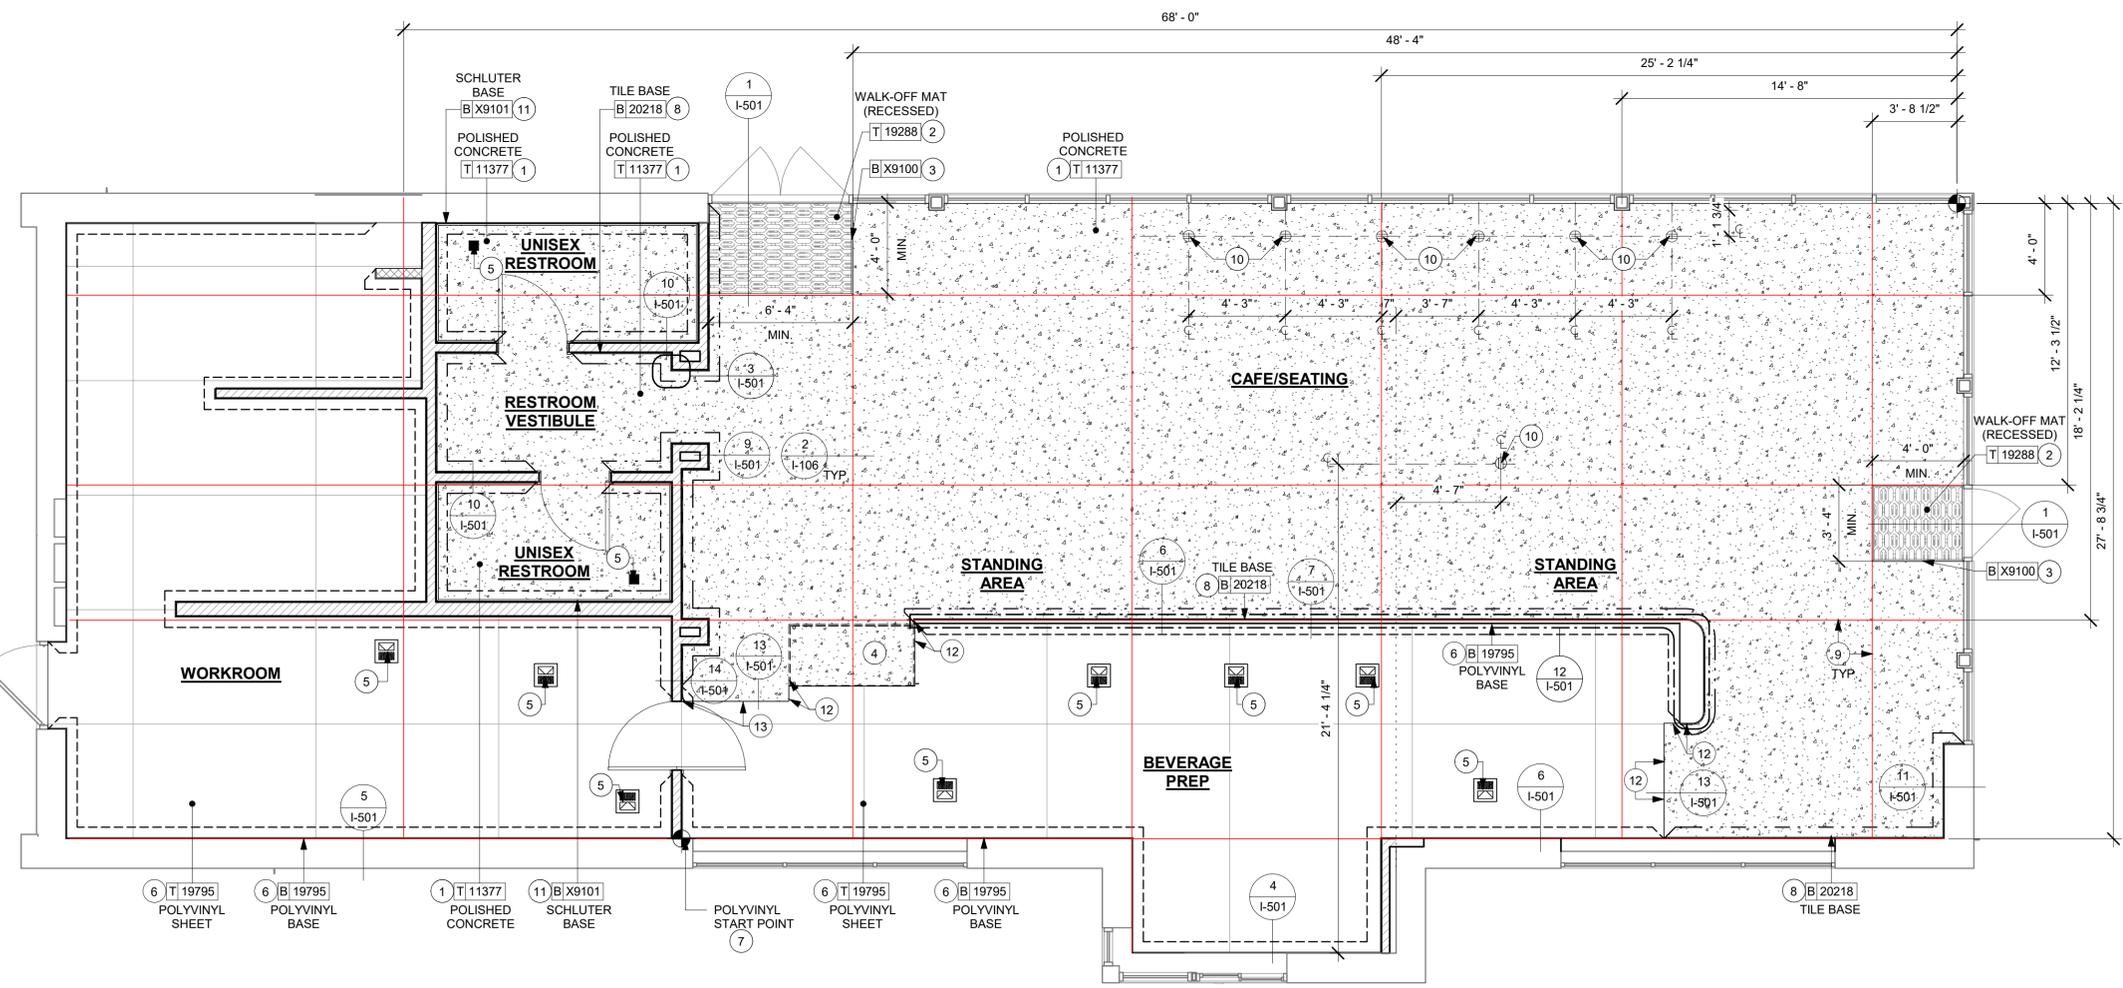

1 FLOOR FINISH PLAN

Scale: 1/4" = 1'-0"

FOR CONSTRUCTION



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STARBUCKS TEMPLATE VERSION: I2022-11-17

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Timothy L. Raberding, PE
Professional Engineer
License: 62078



PROJECT NAME:
LECANTO HWY & NORVELL BRYANT

PROJECT ADDRESS:
**3159 W NORVELL BRYANT HWY
LECANTO, FL 34461**

STORE #: 78366
PROJECT #: 97107-001
ISSUE DATE: 09/06/2023
DESIGNER: RAI MONTERO
PRODUCTION DESIGNER: ANDY MCLLOUD
CHECKED BY: DONALD RETHMAN

Revision Schedule			
Rev	Date	By	Description

SHEET TITLE:
FLOOR FINISH PLAN

SCALE: AS SHOWN

SHEET NUMBER:
I-106

BLD202323715

PAINT SCHEDULE					
COLOR CODE	DESCRIPTION	LRV	FURN. BY	INST. BY	COMMENTS
SW6074-ES	SW - SPALDING GRAY - EGGSHELL	22	GC	GC	USE PRIMER CP-1
SW7037-ES	SW - BALANCED BEIGE - EGGSHELL	46	GC	GC	USE PRIMER CP-1
SW7039-ES	SW - VIRTUAL TAUPE - EGGSHELL	20	GC	GC	USE PRIMER CP-1
SW7039-SG	SW - VIRTUAL TAUPE - SEMIGLOSS	20	GC	GC	USE PRIMER CP-1

WALL TREATMENT (AREA) SCHEDULE - "Q"					
DESIGN ID	AREA	DESCRIPTION	FURN. BY	INST. BY	COMMENTS
PLASTIC					
11469	1655 SF	FRP - WHITE	GC	GC	
TILE					
14744	526 SF	TILE - PRO ARCHITECTURA - GREY PN11 - 4X12IN 100X300MM	SB	GC	GROUT: MAPEI - 02 PEWTER, OR EQUAL
X9200	322 SF	TILE - GEO BEIGE - MATTE - WHITE - 3X9IN 36X108MM	SB	GC	GROUT: MAPEI 105 DRIFTWOOD - 3/16"; VENDOR: FIVE STAR CERAMICS GROUP; LEAD TIME: 3-4 WEEKS; CONTACT INFO: CHRISM@FIVESC.COM
WOOD CLADDING					
X9201	309 SF	WOOD - WALNUT - PLANK - VERTICAL	SB	GC	WD0077 MAD100-V PLANK; PROVIDED BY CASEWORK VENDOR

WALL TREATMENT (LENGTH) SCHEDULE - "R"					
DESIGN ID	LENGTH	DESCRIPTION	FURN. BY	INST. BY	COMMENTS
CHAIR RAIL					
X1206		CHAIR RAIL - 1"X5" - CORIAN CP0030	SB	GC	FINISH: CP0030; SEE DETAIL: 16/502; PROVIDED BY CASEWORK VENDOR; MOUNTED AT 28IN (710MM) AFF
TRIM					
X9202	6' - 8"	SCHLUTER JOLLY TRIM	GC	GC	LOCATION: TILE TO PAINT; SEE DETAIL: 16/1-502
WOOD WAINSCOT					
X1207		WOOD WAINSCOT - WD0077 MAD105	SB	GC	FINISH: WD0077 (MAD105); SEE DETAIL: 16/502; PROVIDED BY CASEWORK VENDOR; MOUNTED AT 28IN (710MM) AFF

RESPONSIBILITY LEGEND

FURN. BY	INST. BY
SB - FURNISHED BY STARBUCKS	GC - INSTALLED BY GENERAL CONTRACTOR
GC - FURNISHED BY GENERAL CONTRACTOR	SB - INSTALLED BY STARBUCKS
VD - FURNISHED BY VENDOR	VD - INSTALLED BY VENDOR

NOTE:
ALL RESPONSIBILITIES TO BE CONFIRMED WITH STARBUCKS CONSTRUCTION MANAGER PRIOR TO ORDERING / CONSTRUCTION.

LEGEND


- 1 INDICATES PARTIAL HEIGHT - FRP* Q 11469
- 2 INDICATES BACKBAR WALL TILE* Q X9200
- 3 INDICATES WOOD CLADDING (WD0077 MAD100-V)* Q X9201
- 4 INDICATES FULL HEIGHT FRP - WHITE* Q 11469
- 5 INDICATES RESTROOM WALL TILE** Q 14744
- 6 INDICATES BACKBAR WALL TILE UP TO 7' - 2" AFF AND WOOD CLADDING (WD0077 MAD100-V) ABOVE* Q X9200 Q X9201
- 7 INDICATES CHAIR RAIL, WAINSCOT AND PAINT UP TO 7' - 2" AFF AND WOOD CLADDING (WD0077 MAD100-V) ABOVE* SW6074-ES Q X9201 R X1206 R X1207
- 8 INDICATES BACKBAR WALL TILE UP TO 8' - 3" AFF AND PAINT SW7037 ABOVE* Q X9200 SW7037-ES
- 9 INDICATES HOT ROLLED STEEL CORNER GUARD FOR BOH. INSTALL 6" (150mm) TO 42" (1065mm) A.F.F. UNLESS OTHERWISE NOTED. C 10829
- SEE INTERIOR FINISH ELEVATIONS FOR TAGGED LOCATION OF WALL FINISH MATERIAL.
- ** SEE RESTROOM PLAN & ELEVATIONS FOR TAGGED LOCATION OF WALL FINISH MATERIAL.

GENERAL NOTES


- A. WORKROOM TO BE FINISHED PER LOCAL CODE REQUIREMENTS.
- B. GENERAL CONTRACTOR TO PROVIDE AND INSTALL WORKROOM WALL FINISHES.
- C. FLOORS, WALLS AND CEILING FINISHES IN FOOD PREPARATION AREAS SHALL BE SMOOTH, NON-TOXIC, NON-ABSORBENT, DURABLE AND EASILY CLEANABLE. PAINT SHALL BE WASHABLE; SEMI-GLOSS OR HIGH-GLOSS FINISH.
- D. CHANGE PAINT COLOR ONLY AT INSIDE CORNERS UNLESS OTHERWISE INDICATED.
- E. PAINT SUBSTITUTIONS ARE NOT ALLOWED. USE STARBUCKS' NATIONAL ACCOUNT "COLOR CODE" WHEN ORDERING PAINTS.
- F. PAINT FINISHES SHALL BE APPLIED AS FOLLOWS, UNLESS NOTED OTHERWISE:
 - a. WOODS AND METAL SURFACES SHALL BE SEMI-GLOSS OR EQUAL.
 - b. ACCENT AND TRIM PAINTS TO BE SEMI-GLOSS OR EQUAL.
 - c. PAINTS IN BOH, RESTROOM(S) OR CAFE BAR SHALL BE SEMI-GLOSS OR EQUAL.
- G. ALL WOOD SURFACES (DOORS, TRIM, SHELVES, CABINERY) SHALL BE SEALED.
- H. REFER TO CASEWORK FINISH SCHEDULE FOR CASEWORK FINISH MATERIAL INFORMATION.
- I. REFER TO INTERIOR FINISH ELEVATIONS FOR ARTWORK/ GRAPHICS LOCATIONS.
- J. REFER TO MANUFACTURER'S INSTRUCTIONS INCLUDED WITH ARTWORK/GRAPHICS FOR PROPER INSTALLATION.
- K. ALL FLOOR AND WALL JUNCTIONS IN STORAGE AND FOOD PREPARATION AREAS SHALL HAVE A 6" COVERED BASE.
- L. INSTALL BLOCKING AND HANGERS FOR WALL SHELVING BEFORE INSTALLING BACK BAR TILE.

KEYED NOTES

1. INSTALL FULL HEIGHT FRP AT WORKROOM WALLS AS INDICATED.
2. PROVIDE FIRE TREATED BLOCKING AS REQUIRED TO SUPPORT WALL ATTACHMENTS (SEE BUILDING FLOOR PLAN ON SHEET A-101 FOR MORE INFORMATION).
3. REFER TO SHEET I-502 FOR WALL FINISH DETAILS.
4. FRP BENEATH BACKBAR AT EXPOSED WALLS EXTEND FROM TOP OF WALL BASE TO UNDERSIDE OF COUNTERTOP.
5. ELECTRICAL PANEL. GC CONFIRM WITH WL AS INDICATED. MAINTAIN MINIMUM CLEARANCES AS REQUIRED BY CODE. REFER TO ELECTRICAL DRAWINGS.
6. MOP SINK. FULL HEIGHT FRP AT ENCLOSURE (SEE PLUMBING PLANS FOR MORE INFORMATION).
7. INSTALL WALL TILE AT RESTROOMS AS INDICATED.
8. INSTALL CORNER GUARD AT OUTSIDE CORNER AS INDICATED. SEE DETAILS: 4/1-502.
9. PAINT WALL AS INDICATED ON INTERIOR FINISH ELEVATIONS.
10. GC TO INSTALL BACKBAR WALL TILE AS INDICATED ON INTERIOR FINISH ELEVATIONS.
11. BACKBAR TILE TO RETURN TO MULLIONS WITHIN DRIVE-THRU WINDOW OPENING AS INDICATED.
12. INSTALL WOOD CLADDING AT CAFE AS INDICATED ON INTERIOR FINISH ELEVATIONS.
13. INSTALL CUSTOM WOOD TRIM AROUND RESTROOM VESTIBULE OPENING AS INDICATED.
14. INSTALL CUSTOM WOOD TRIM AROUND MERCH BAY AS INDICATED.
15. PAINT WALL ABOVE STOREFRONT GLAZING AS INDICATED ON INTERIOR FINISH ELEVATIONS.
16. INSTALL CUSTOM WOOD TRIM AT BACKBAR DT HEADER AS INDICATED.
17. INSTALL SCHLUTER TRIM AT BACKBAR TILE AND PAINT TRANSITION AS INDICATED.
18. INSTALL FRY REGLET "Y" TRIM AS INDICATED. SEE DETAIL: 17/1-502.

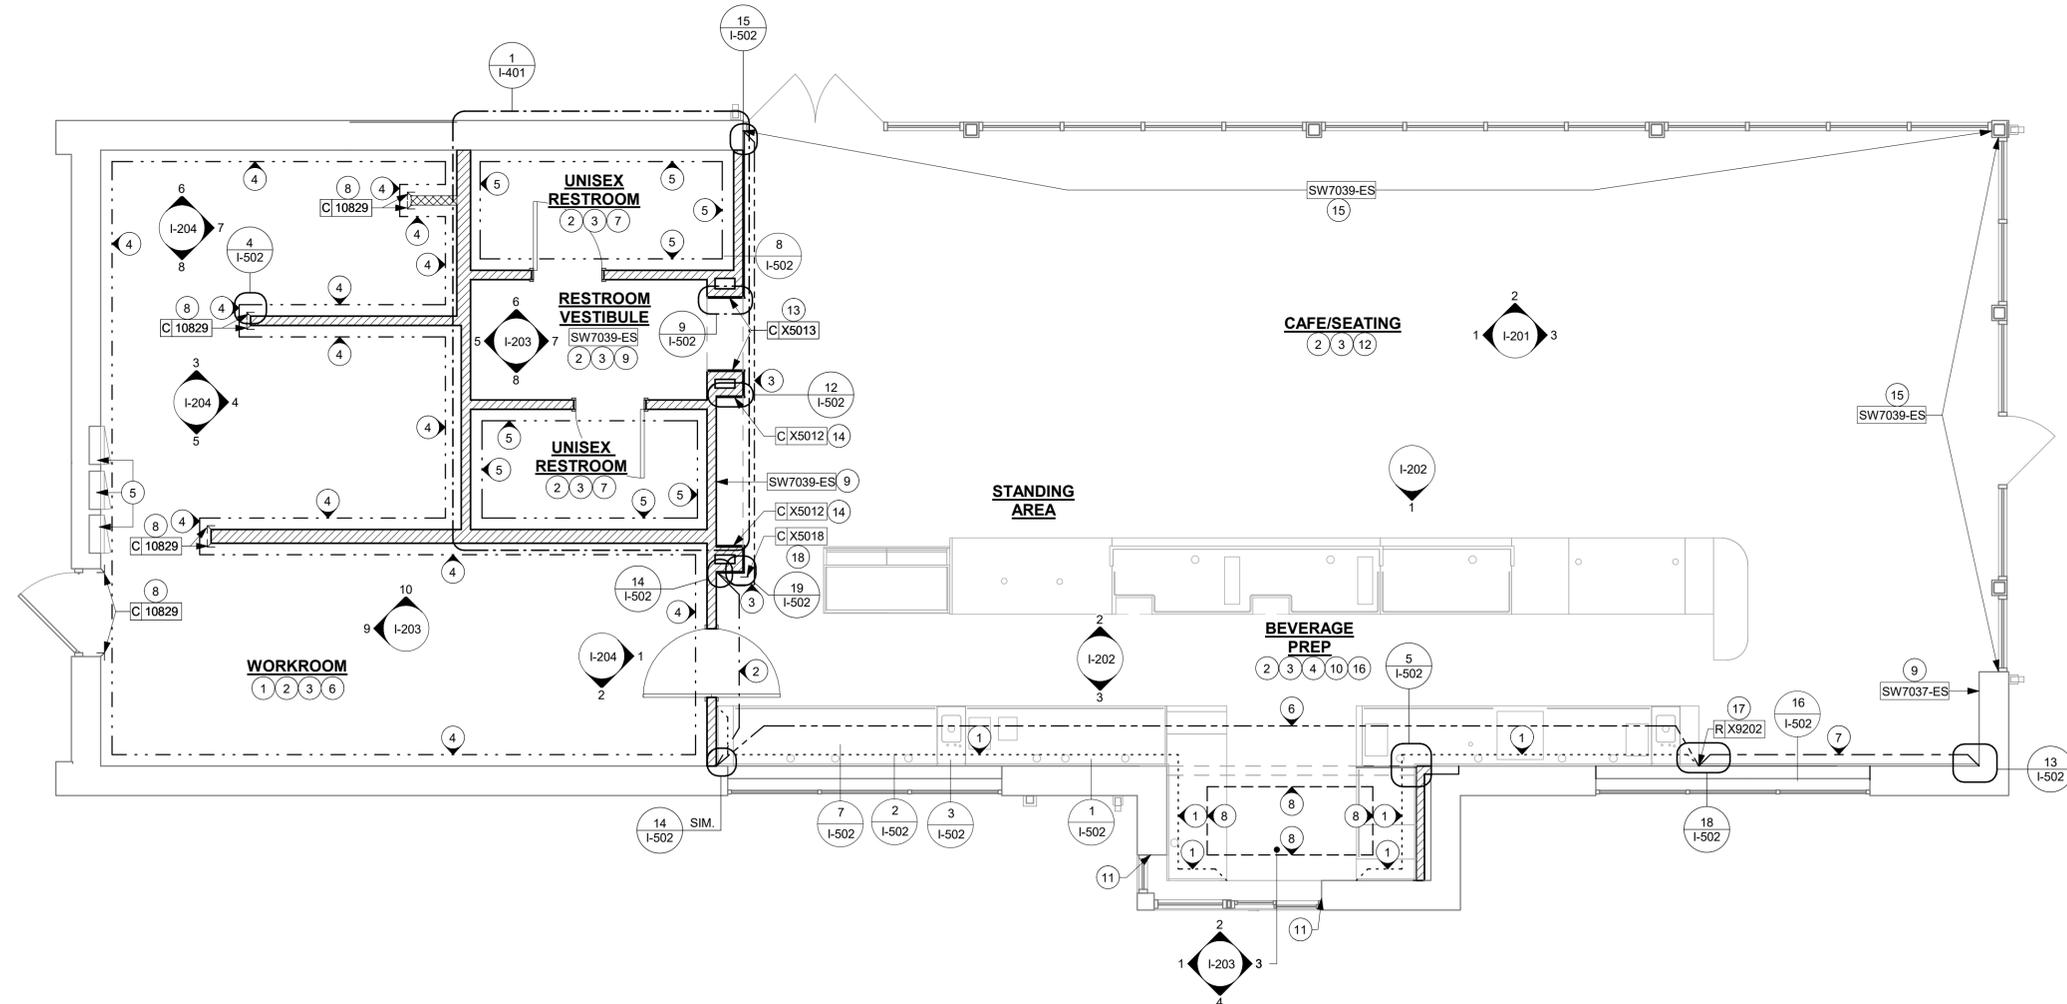

1 WALL FINISH PLAN
Scale: 1/4" = 1'-0"

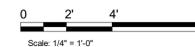

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09/12/2023

FOR CONSTRUCTION

PROJECT NAME:
LECANTO HWY & NORVELL BRYANT

PROJECT ADDRESS:
**3159 W NORVELL BRYANT HWY
LECANTO, FL 34461**

STORE #: 78366
PROJECT #: 97107-001
ISSUE DATE: 09/06/2023
DESIGNER: RAI MONTERO
PRODUCTION DESIGNER: ANDY MCLLOUD
CHECKED BY: DONALD RETHMAN

Revision Schedule			
Rev	Date	By	Description

SHEET TITLE:
WALL FINISH PLAN

SCALE: 1/4" = 1'-0"

SHEET NUMBER:
I-107

BLD202323715



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FOR CONSTRUCTION

PROJECT NAME:
LECANTO HWY & NORVELL BRYANT


PROJECT ADDRESS:
**3159 W NORVELL BRYANT HWY
LECANTO, FL 34461**

STORE #: 78366
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ISSUE DATE: 09/06/2023
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Revision Schedule			
Rev	Date	By	Description


SHEET TITLE:
INTERIOR FINISH ELEVATIONS
SCALE: 3/8" = 1'-0"

SHEET NUMBER:
I-201

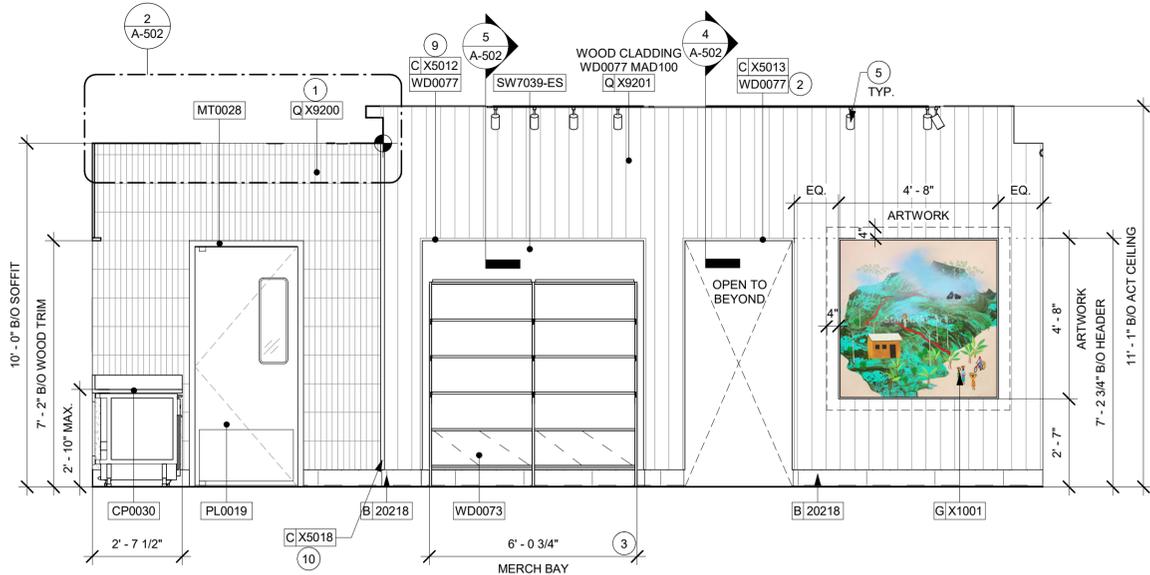


1 MERCH BAY

Scale: 3/8" = 1'-0"

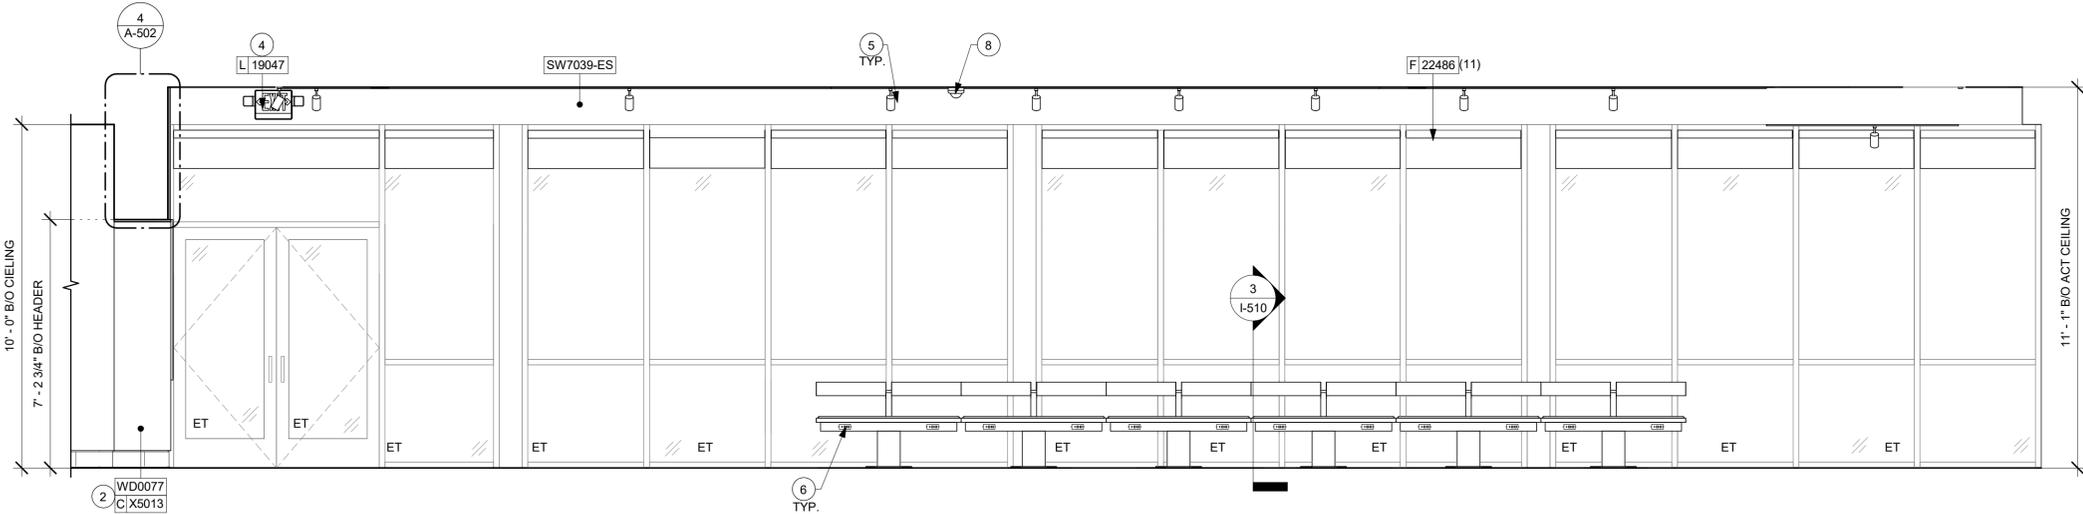

2 BANQUETTE SEATING

Scale: 3/8" = 1'-0"

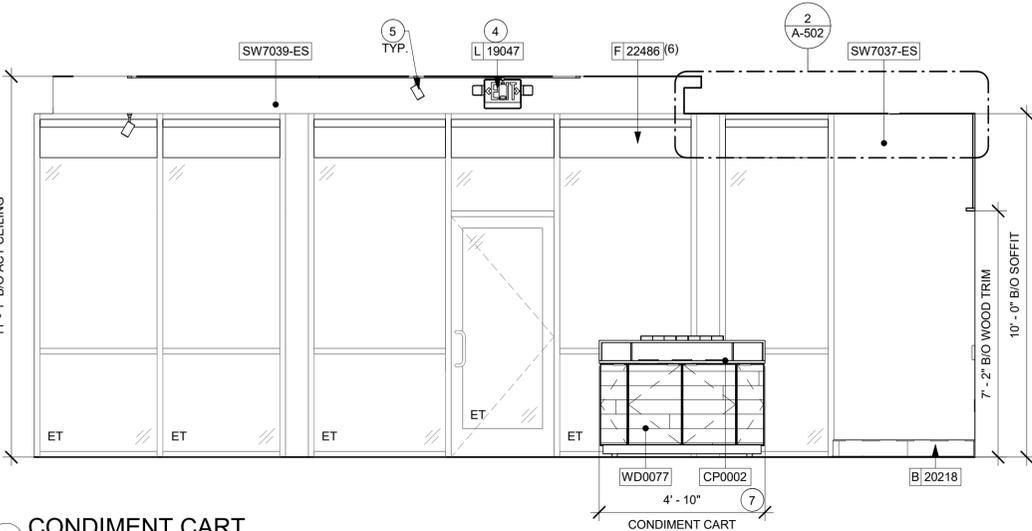

3 CONDIMENT CART

Scale: 3/8" = 1'-0"

GENERAL NOTES

- A. FOR PAINT AND WALL TREATMENT SCHEDULES, REFER TO THE INTERIOR FINISH SHEET. FOR GRAPHICS SCHEDULE, REFER TO THE FURNITURE, FIXTURES, AND EQUIPMENT (FF & E) SCHEDULES.
- B. REFER TO MANUFACTURER'S INSTRUCTIONS INCLUDED WITH ARTWORK/GRAPHICS FOR PROPER INSTALLATION.
- C. PAINT FINISHES SHALL BE APPLIED AS FOLLOWS, UNLESS NOTED OTHERWISE:
 - 1. WOODS AND METAL SURFACES SHALL BE SEMI-GLOSS OR EQUAL.
 - 2. ACCENT AND TRIM PAINTS TO BE SEMI-GLOSS OR EQUAL.
 - a. WALL AND CEILING PAINTS TO BE EGG-SHELL OR EQUAL.
 - 3. PAINTS IN BOH, RESTROOM(S) OR CAFE BAR SHALL BE SEMI-GLOSS OR EQUAL.
- D. FLOORS, WALLS AND CEILING FINISHES IN FOOD PREPARATION AREAS SHALL BE SMOOTH, NON-TOXIC, NON-ABSORBENT, DURABLE AND EASILY CLEANABLE. PAINT SHALL BE WASHABLE; SEMI-GLOSS OR HIGH GLOSS FINISH.

KEYED NOTES

- 1. GC TO INSTALL BACKBAR WALL TILE AS INDICATED. SEE DETAIL ON SHEET 6/I-502.
- 2. INSTALL WOOD TRIM AT RESTROOM VESTIBULE OPENING AS INDICATED.
- 3. INSTALL MERCH BAY AS INDICATED.
- 4. LOCATION OF ALL EXIT/ EMERGENCY LIGHTS FOR REFERENCE ONLY. GC TO VERIFY WITH LOCAL FIRE MARSHAL PRIOR TO INSTALLATION.
- 5. INSTALL SURFACE MOUNTED TRACK LIGHTING AS INDICATED. SEE LIGHTING PLAN.
- 6. GC TO PROVIDE COVER PLATES TO MATCH ADJACENT FINISH THROUGHOUT.
- 7. INSTALL CONDIMENT CART AS INDICATED.
- 8. INSTALL CEILING MOUNTED SECURITY CAMERA AS INDICATED.
- 9. INSTALL WOOD TRIM AROUND MERCH BAY AS INDICATED.
- 10. INSTALL FRY REGLET "Y" TRIM AS INDICATED. SEE DETAIL: 17/I-502.

LEGEND


INDICATES WALL BLOCKING. FIRE TREATED WALL BLOCKING TO BE PROVIDED AS REQUIRED TO SUPPORT WALL ATTACHMENTS. EXTEND BLOCKING 4" (100mm) BEYOND EDGE OF ATTACHMENTS.

WALL TILE START POINT DATUM




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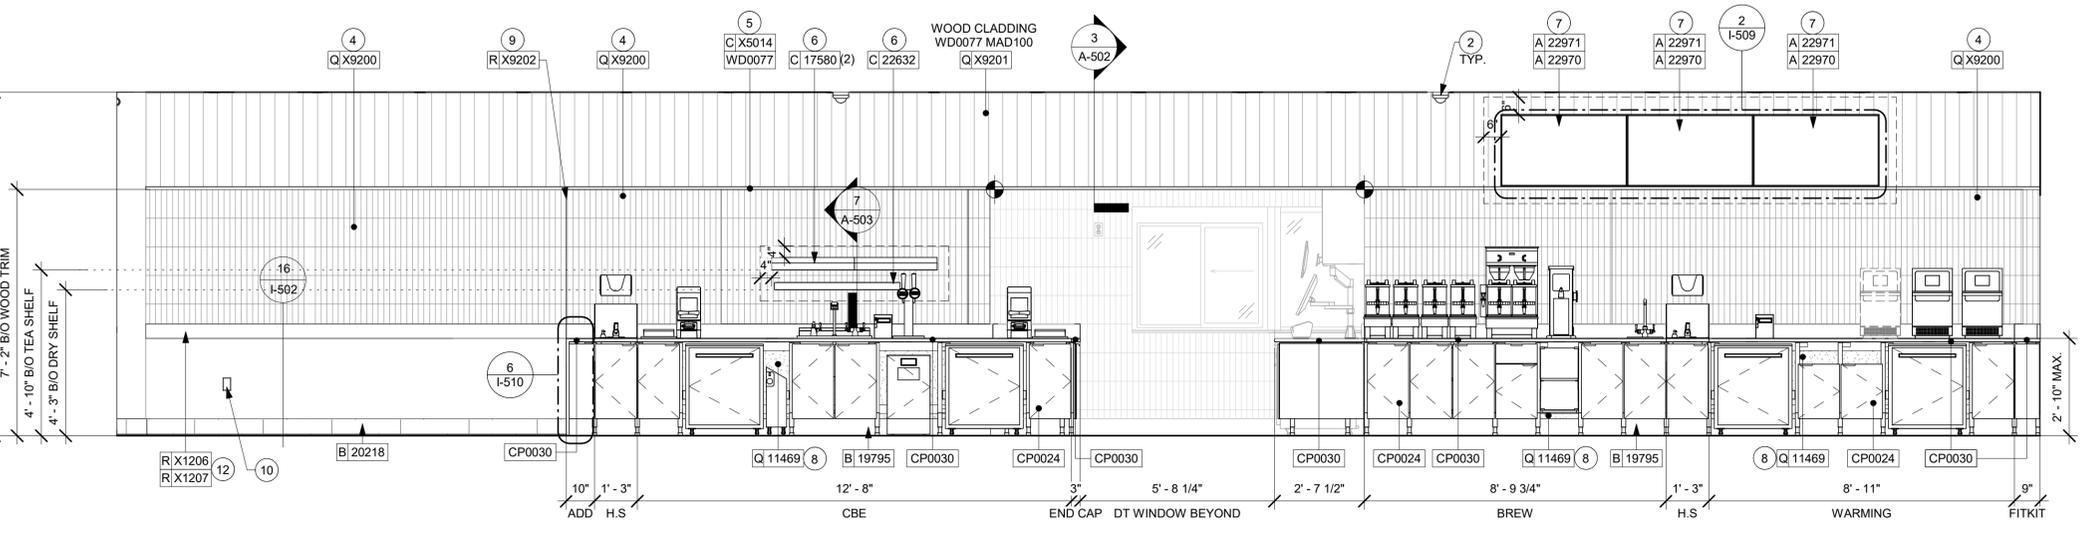
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1 FRONT BAR (CUSTOMER SIDE)
Scale: 3/8" = 1'-0"

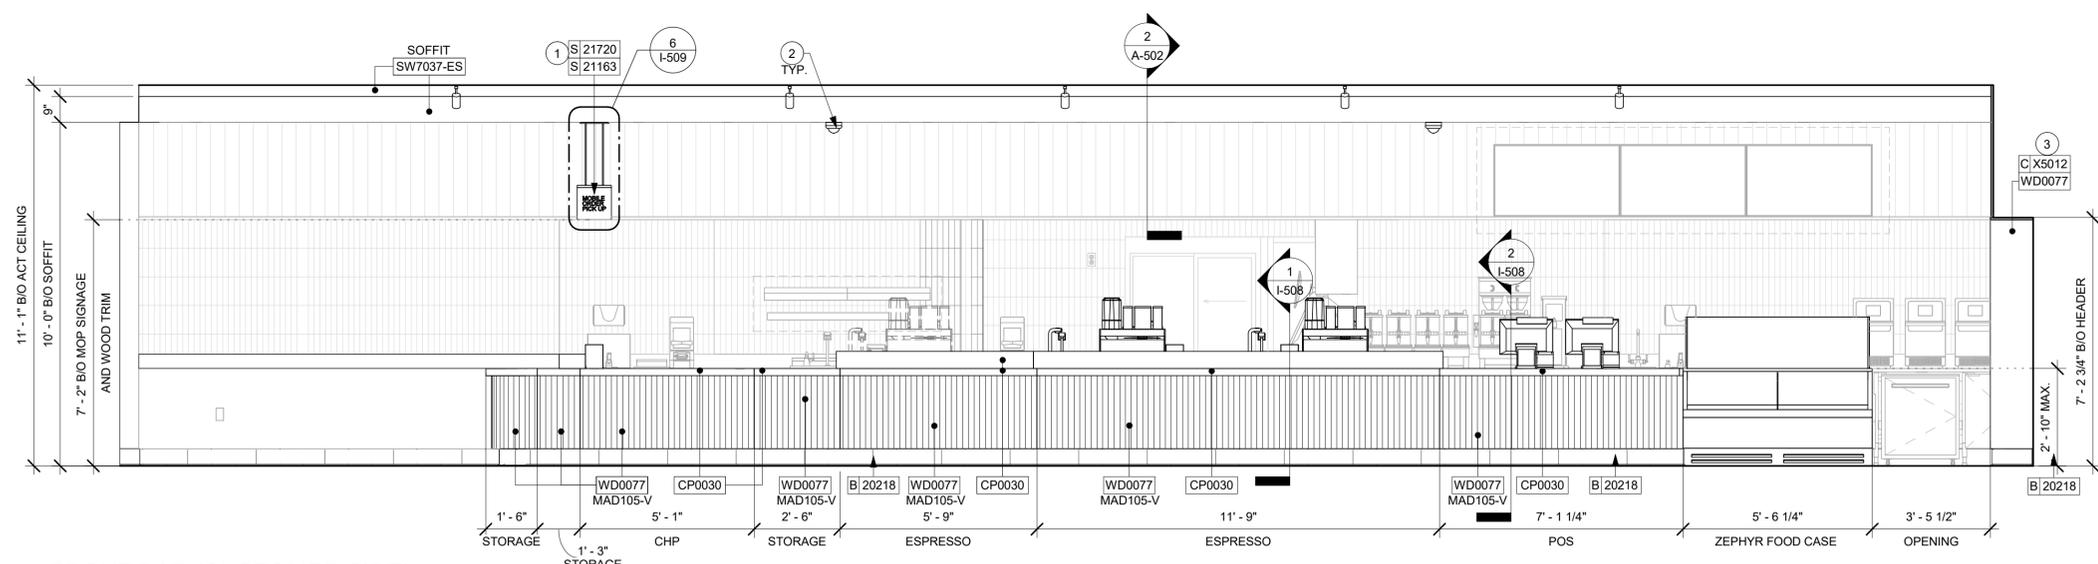

2 FRONT BAR (PARTNER SIDE)
Scale: 3/8" = 1'-0"

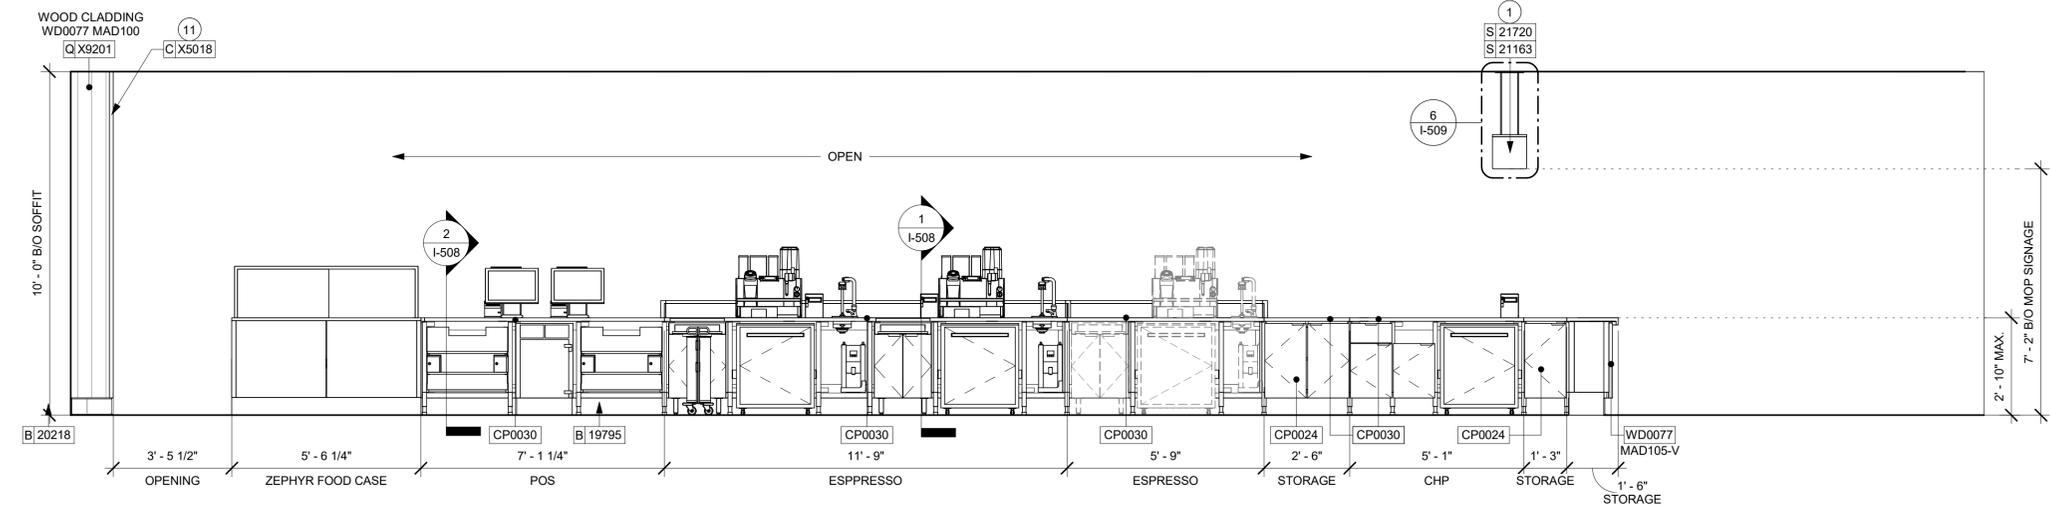

3 BACKBAR
Scale: 3/8" = 1'-0"

GENERAL NOTES


- A. FOR PAINT AND WALL TREATMENT SCHEDULES, REFER TO THE INTERIOR FINISH SHEET, FOR GRAPHICS SCHEDULE, REFER TO THE FURNITURE, FIXTURES, AND EQUIPMENT (FF & E) SCHEDULES.
- B. REFER TO MANUFACTURER'S INSTRUCTIONS INCLUDED WITH ARTWORK/GRAPHICS FOR PROPER INSTALLATION.
- C. PAINT FINISHES SHALL BE APPLIED AS FOLLOWS, UNLESS NOTED OTHERWISE:
 - 1. WOODS AND METAL SURFACES SHALL BE SEMI-GLOSS OR EQUAL.
 - 2. ACCENT AND TRIM PAINTS TO BE SEMI-GLOSS OR EQUAL.
 - a. WALL AND CEILING PAINTS TO BE EGGSHELL OR EQUAL.
 - 3. PAINTS IN BOH, RESTROOM(S) OR CAFE BAR SHALL BE SEMI-GLOSS OR EQUAL.
- D. FLOORS, WALLS AND CEILING FINISHES IN FOOD PREPARATION AREAS SHALL BE SMOOTH, NON-TOXIC, NON-ABSORBENT, DURABLE AND EASILY CLEANABLE. PAINT SHALL BE WASHABLE; SEMI-GLOSS OR HIGH GLOSS FINISH.

KEYED NOTES

1. INSTALL CEILING MOUNTED MOP SIGNAGE AS INDICATED.
2. INSTALL CEILING MOUNTED SECURITY CAMERA AS INDICATED.
3. INSTALL WOOD TRIM AROUND MERCH BAY AS INDICATED.
4. GC TO INSTALL BACKBAR WALL TILE AS INDICATED. SEE DETAIL ON SHEET 6/I-502.
5. INSTALL WOOD TRIM ABOVE BACKBAR WALL TILE AS INDICATED.
6. SHELVING FOR CBE STATION AS SHOWN. GC TO PROVIDE WALL BLOCKING FOR FASTENERS.
7. ATTACH DIGITAL MENU BOARDS PER INSTALLATION DETAIL.
8. FRP BENEATH BACKBAR AT EXPOSED WALLS. EXTEND FROM TOP OF WALL BASE TO UNDERSIDE OF COUNTERTOP.
9. INSTALL SCHLUTER TRIM AT BACKBAR TILE AND PAINT TRANSITION AS INDICATED.
10. GC TO PROVIDE COVER PLATES TO MATCH ADJACENT FINISH THROUGHOUT.
11. INSTALL FRY REGLET "Y" TRIM AS INDICATED. SEE DETAIL: 17/I-502.
12. INSTALL CHAIR RAIL AND WAINSCOT.

LEGEND

- INDICATES WALL BLOCKING. FIRE TREATED WALL BLOCKING TO BE PROVIDED AS REQUIRED TO SUPPORT WALL ATTACHMENTS. EXTEND BLOCKING 4" (100mm) BEYOND EDGE OF ATTACHMENTS.
- WALL TILE START POINT DATUM

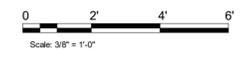

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FOR CONSTRUCTION

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STORE #: 78366
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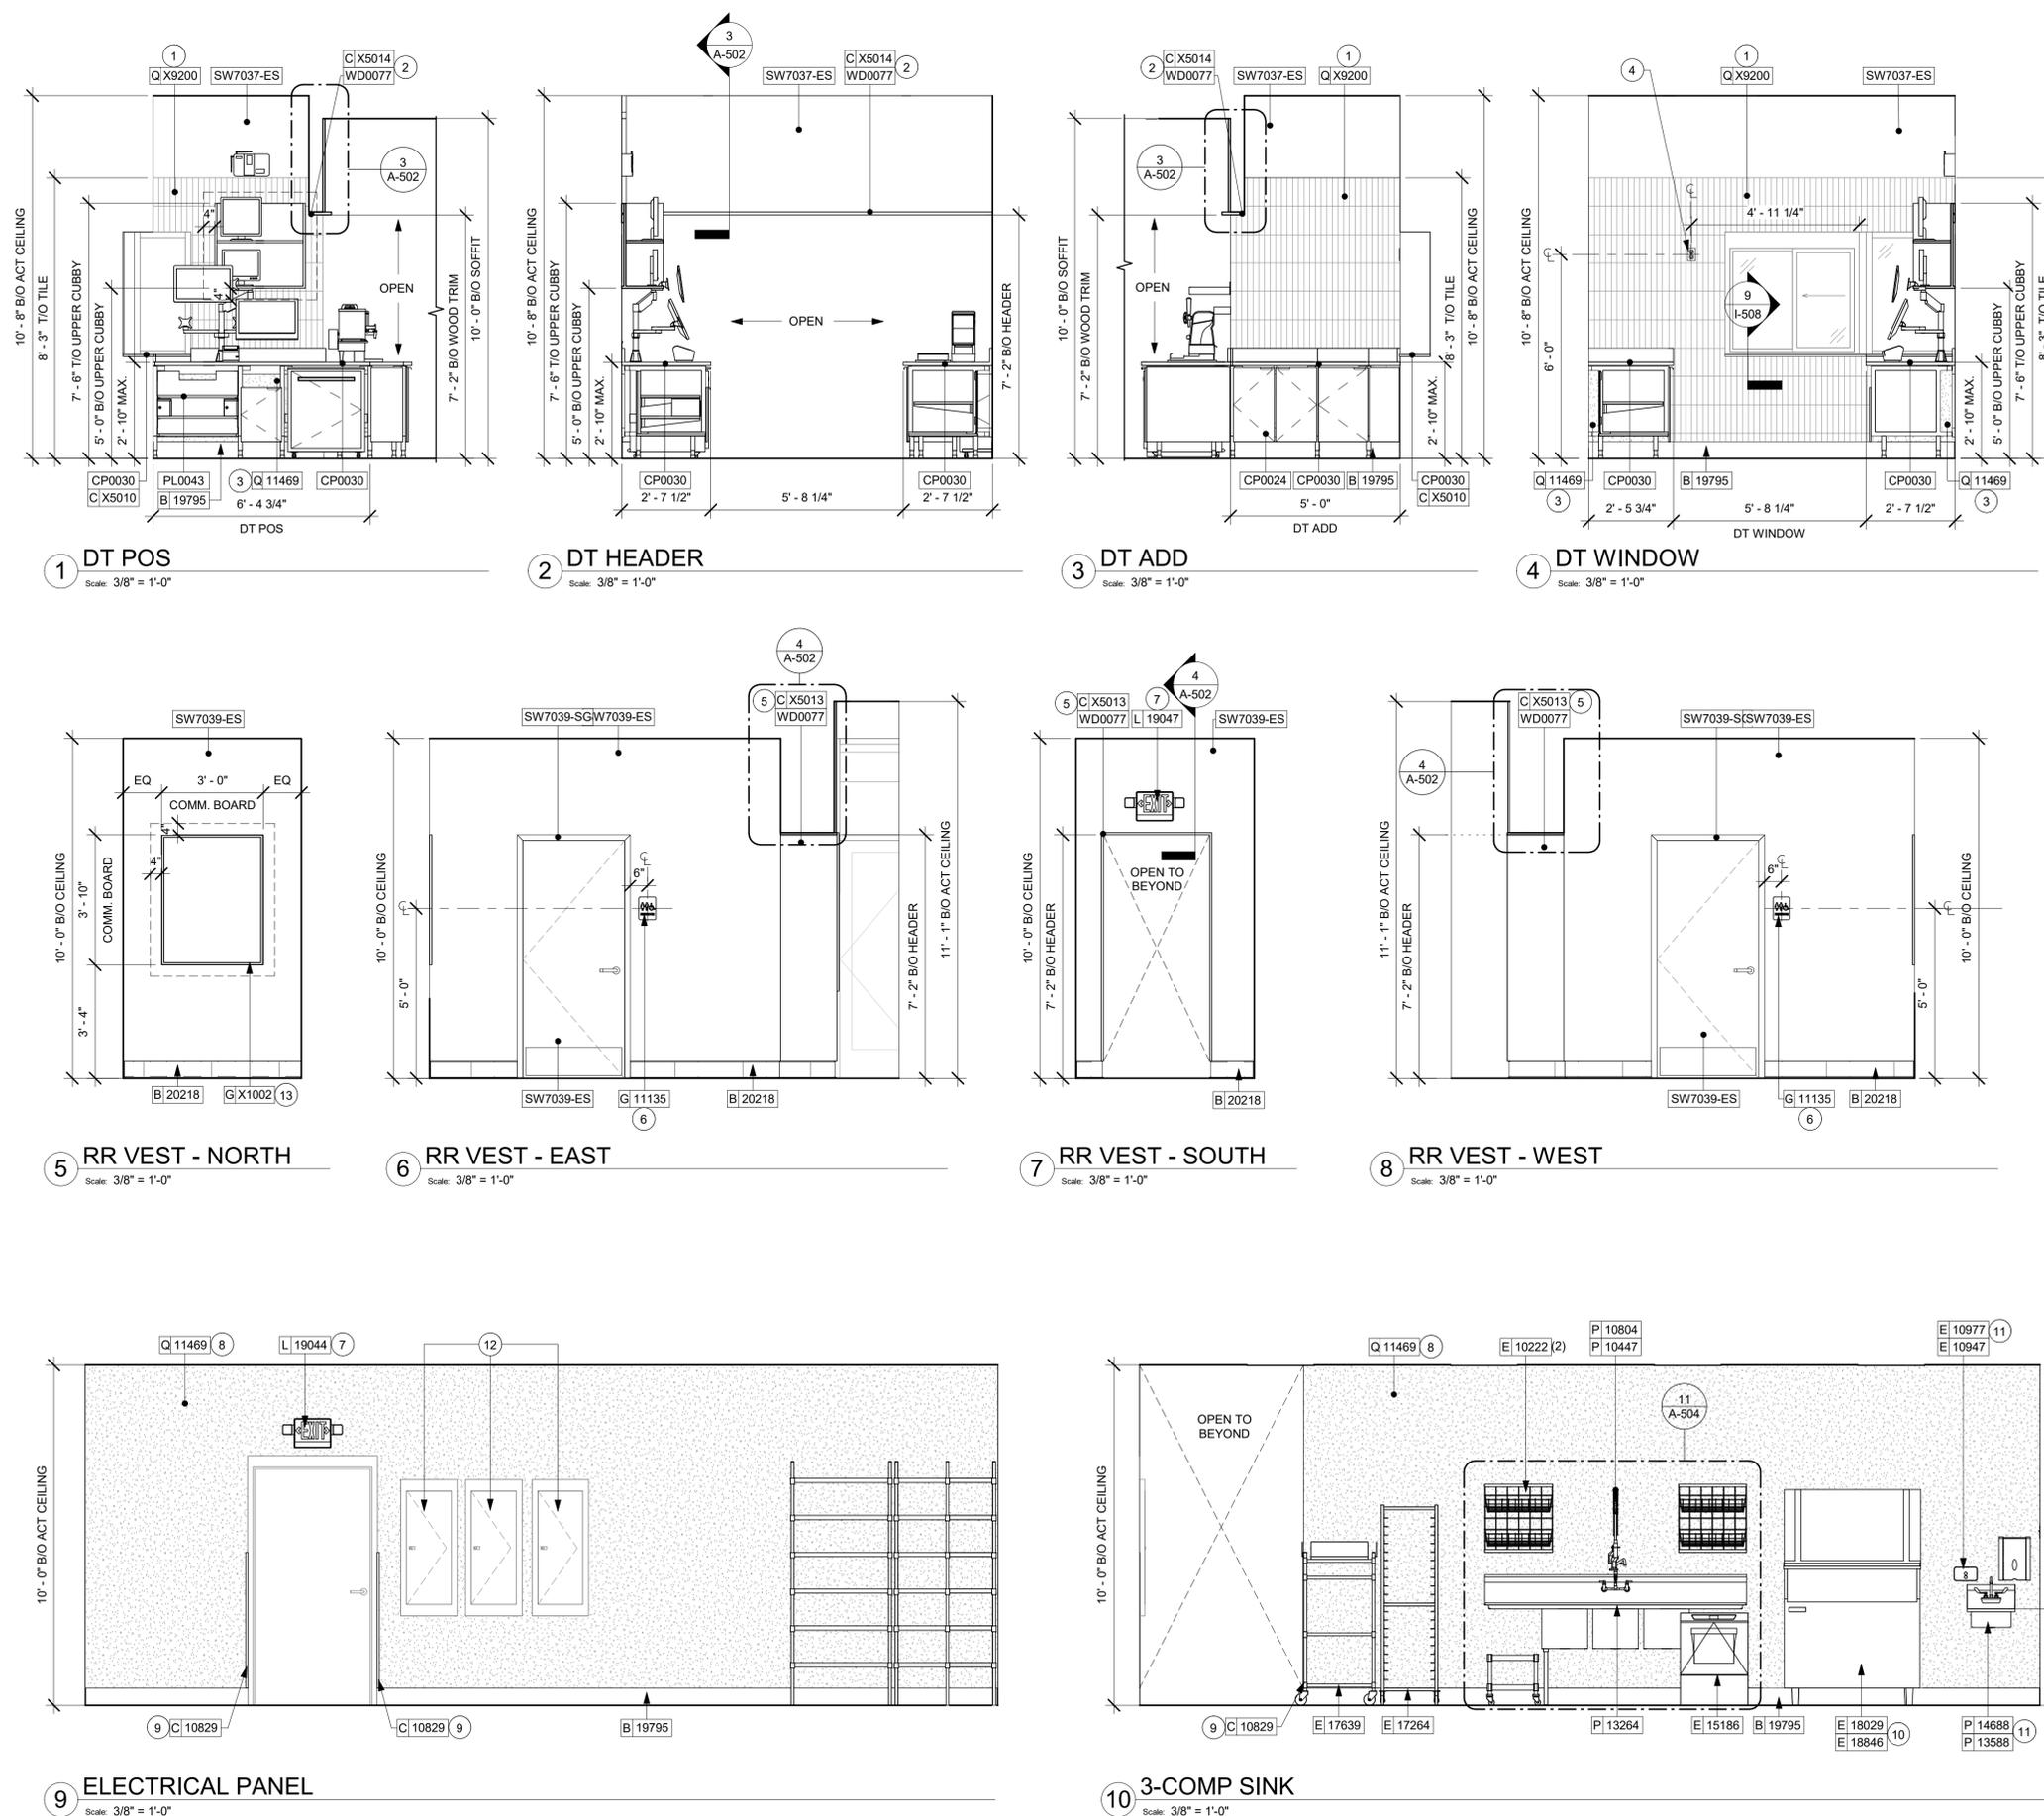
Revision Schedule			
Rev	Date	By	Description

SHEET TITLE:
INTERIOR FINISH ELEVATIONS
SCALE: 3/8" = 1'-0"

SHEET NUMBER:
I-202

BLD202323715

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GENERAL NOTES

- A. FOR PAINT AND WALL TREATMENT SCHEDULES, REFER TO THE INTERIOR FINISH SHEET. FOR GRAPHICS SCHEDULE, REFER TO THE FURNITURE, FIXTURES, AND EQUIPMENT (FF & E) SCHEDULES.
- B. REFER TO MANUFACTURER'S INSTRUCTIONS INCLUDED WITH ARTWORK/GRAPHICS FOR PROPER INSTALLATION.
- C. PAINT FINISHES SHALL BE APPLIED AS FOLLOWS, UNLESS NOTED OTHERWISE:
 - 1. WOODS AND METAL SURFACES SHALL BE SEMI-GLOSS OR EQUAL.
 - 2. ACCENT AND TRIM PAINTS TO BE SEMI-GLOSS OR EQUAL.
 - a. WALL AND CEILING PAINTS TO BE EGGSHELL OR EQUAL.
 - 3. PAINTS IN BOH, RESTROOM(S) OR CAFE BAR SHALL BE SEMI-GLOSS OR EQUAL.
- D. FLOORS, WALLS AND CEILING FINISHES IN FOOD PREPARATION AREAS SHALL BE SMOOTH, NON-TOXIC, NON-ABSORBENT, DURABLE AND EASILY CLEANABLE. PAINT SHALL BE WASHABLE, SEMI-GLOSS OR HIGH GLOSS FINISH.

KEYED NOTES

- 1. GC TO INSTALL BACKBAR WALL TILE AS INDICATED. SEE DETAIL ON SHEET I-502.
- 2. INSTALL WOOD TRIM AT DT HEADER AS INDICATED.
- 3. FRP BENEATH BACKBAR AT EXPOSED WALLS. EXTEND FROM TOP OF WALL BASE TO UNDERSIDE OF COUNTERTOP.
- 4. RECEPTACLE MOUNTED AT 72" AFF FOR THE ELECTRIC RELEASE DRIVE THRU WINDOW. COORDINATE EXACT LOCATION WITH OWNER'S REPRESENTATIVE.
- 5. INSTALL WOOD TRIM AT RESTROOM VESTIBULE OPENING AS INDICATED.
- 6. INSTALL RESTROOM SIGNAGE AS INDICATED.
- 7. LOCATION OF ALL EXIT/ EMERGENCY LIGHTS FOR REFERENCE ONLY. GC TO VERIFY WITH LOCAL FIRE MARSHAL PRIOR TO INSTALLATION.
- 8. INSTALL FULL HEIGHT FRP AT WORKROOM WALL AS INDICATED.
- 9. INSTALL CORNER GUARD AT OUTSIDE CORNER AS INDICATED. SEE DETAILS: 4/I-502.
- 10. ICE MACHINE (SEE PLUMBING AND ELECTRICAL DRAWINGS FOR ADDITIONAL INFORMATION).
- 11. WALL MOUNT HAND SINK WITH SOAP AND PAPER TOWEL DISPENSER. GC TO PROVIDE BLOCKING FOR FASTENERS.
- 12. ELECTRICAL PANELS (SEE ELECTRICAL DRAWINGS FOR ADDITIONAL INFORMATION).
- 13. INSTALL COMMUNITY BOARD TO ALIGN WITH TOP OF RESTROOM DOOR FRAME.

LEGEND

- - - - - INDICATES WALL BLOCKING. FIRE TREATED WALL BLOCKING TO BE PROVIDED AS REQUIRED TO SUPPORT WALL ATTACHMENTS. EXTEND BLOCKING 4" (100mm) BEYOND EDGE OF ATTACHMENTS.
- ⊙ WALL TILE START POINT DATUM



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 Timothy L. Raberding, PE
 Professional Engineer
 License: 62078



FOR CONSTRUCTION

PROJECT NAME:
LECANTO HWY & NORVELL BRYANT

PROJECT ADDRESS:
**3159 W NORVELL BRYANT HWY
 LECANTO, FL 34461**

STORE #: 78366
 PROJECT #: 97107-001
 ISSUE DATE: 09/06/2023
 DESIGNER: RAI MONTERO
 PRODUCTION DESIGNER: ANDY MCLLOUD
 CHECKED BY: DONALD RETHMAN


Revision Schedule			
Rev	Date	By	Description

SHEET TITLE:
INTERIOR FINISH ELEVATIONS
 SCALE: 3/8" = 1'-0"


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I-203

BLD202323715


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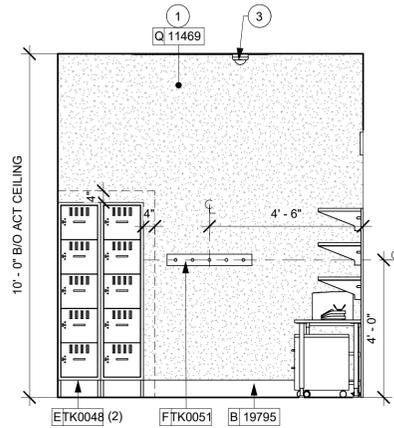
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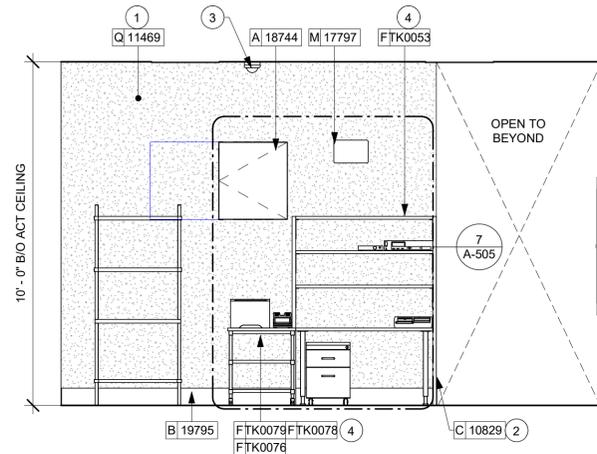
2 FREEZERS
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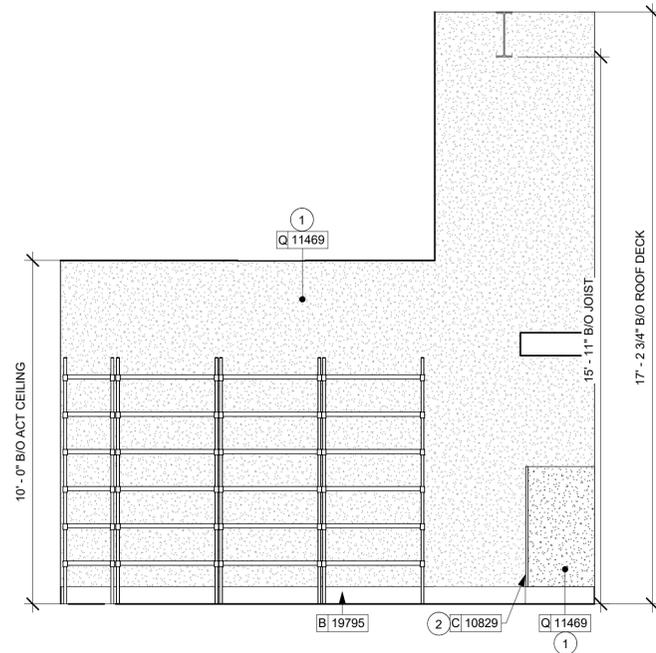
3 WORKROOM - NORTH
Scale: 3/8" = 1'-0"

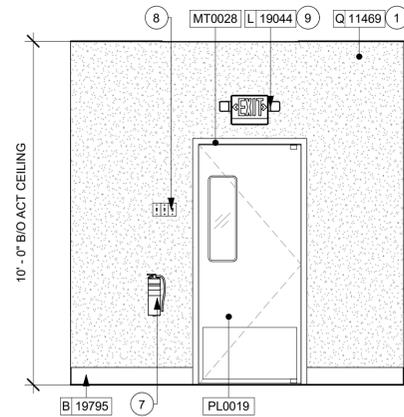


4 5-COMP LOCKER
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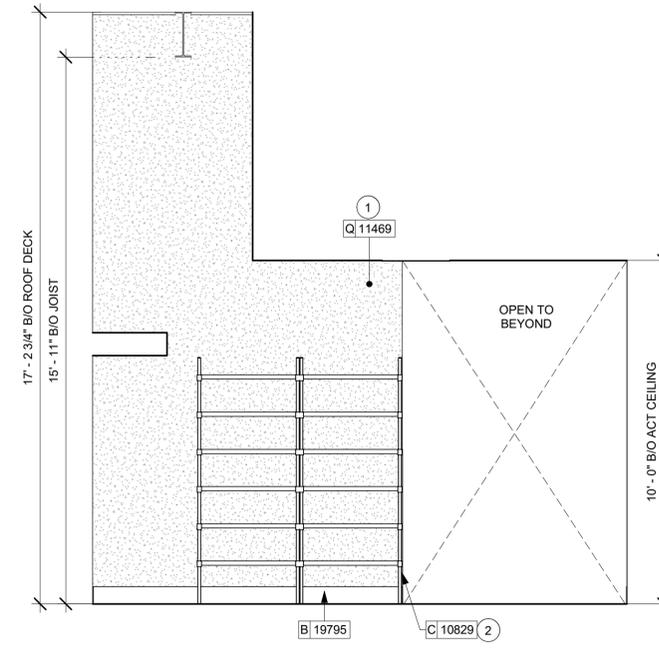
5 MANAGER'S DESK
Scale: 3/8" = 1'-0"

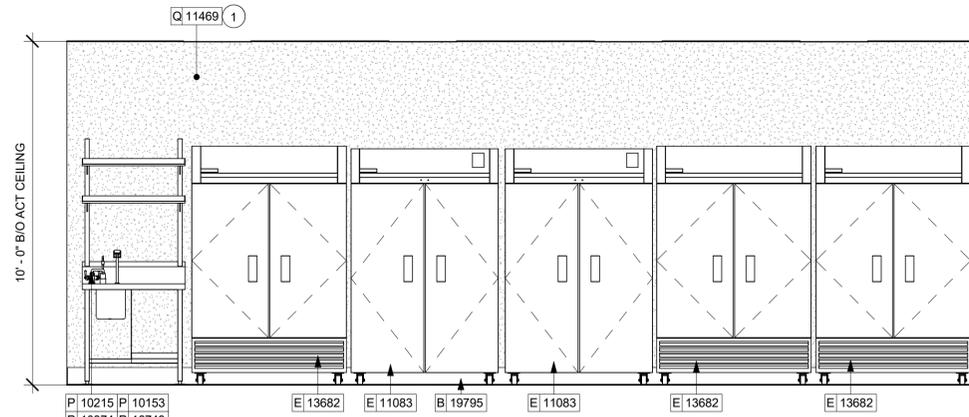

6 SHELVING
Scale: 3/8" = 1'-0"

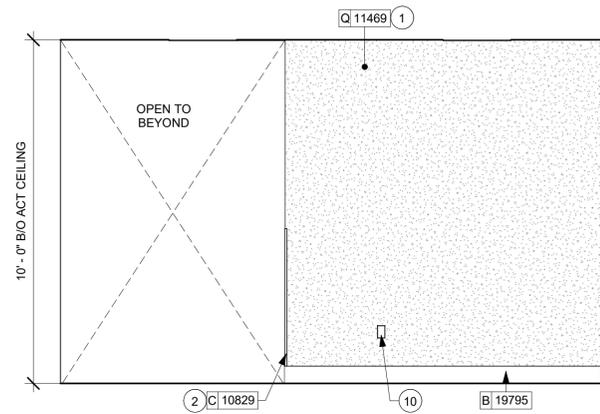

7 WATER FILTRATION SYSTEM
Scale: 3/8" = 1'-0"

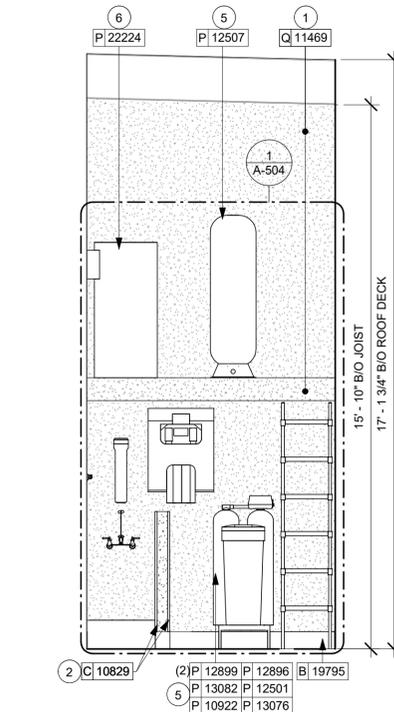

8 WORKROOM - WEST
Scale: 3/8" = 1'-0"

GENERAL NOTES


- A. FOR PAINT AND WALL TREATMENT SCHEDULES, REFER TO THE INTERIOR FINISH SHEET. FOR GRAPHICS SCHEDULE, REFER TO THE FURNITURE, FIXTURES, AND EQUIPMENT (FF & E) SCHEDULES.
- B. REFER TO MANUFACTURER'S INSTRUCTIONS INCLUDED WITH ARTWORK/GRAPHICS FOR PROPER INSTALLATION.
- C. PAINT FINISHES SHALL BE APPLIED AS FOLLOWS, UNLESS NOTED OTHERWISE:
 1. WOODS AND METAL SURFACES SHALL BE SEMI-GLOSS OR EQUAL.
 2. ACCENT AND TRIM PAINTS TO BE SEMI-GLOSS OR EQUAL.
 - a. WALL AND CEILING PAINTS TO BE EGGSHELL OR EQUAL.
 3. PAINTS IN BOH, RESTROOM(S) OR CAFE BAR SHALL BE SEMI-GLOSS OR EQUAL.
- D. FLOORS, WALLS AND CEILING FINISHES IN FOOD PREPARATION AREAS SHALL BE SMOOTH, NON-TOXIC, NON-ABSORBENT, DURABLE AND EASILY CLEANABLE. PAINT SHALL BE WASHABLE, SEMI-GLOSS OR HIGH GLOSS FINISH.

KEYED NOTES

1. INSTALL FULL HEIGHT FRP AT WORKROOM WALL AS INDICATED.
2. INSTALL CORNER GUARD AT OUTSIDE CORNER AS INDICATED. SEE DETAILS: 4/I-502.
3. INSTALL CEILING MOUNTED SECURITY CAMERA AS INDICATED.
4. MANAGER'S DESK (SEE ENLARGED DETAILS).
5. WATER FILTRATION EQUIPMENT (SEE PLUMBING DRAWINGS).
6. WATER HEATER (SEE PLUMBING DRAWINGS).
7. PLACE FIRE EXTINGUISHER IN WORKROOM AS PER FIRE INSPECTOR.
8. LOCATION OF ALL SWITCHING.
9. LOCATION OF ALL EXIT/ EMERGENCY LIGHTS FOR REFERENCE ONLY. GC TO VERIFY WITH LOCAL FIRE MARSHAL PRIOR TO INSTALLATION.
10. GC TO PROVIDE COVER PLATES TO MATCH ADJACENT FINISH THROUGHOUT.

LEGEND

- INDICATES WALL BLOCKING. FIRE TREATED WALL BLOCKING TO BE PROVIDED AS REQUIRED TO SUPPORT WALL ATTACHMENTS. EXTEND BLOCKING 4" (100mm) BEYOND EDGE OF ATTACHMENTS.
- WALL TILE START POINT DATUM

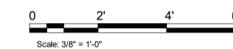

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09/12/2023

FOR CONSTRUCTION

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STORE #: 78366
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PRODUCTION DESIGNER: ANDY MCLLOUD
CHECKED BY: DONALD RETHMAN

Revision Schedule			
Rev	Date	By	Description

SHEET TITLE:
INTERIOR FINISH ELEVATIONS
SCALE: 3/8" = 1'-0"

SHEET NUMBER:
I-204

BLD202323715

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1 VIEW TOWARDS FRONT BAR

NOTE: 3D VIEWS ARE FOR REFERENCE ONLY. REFER TO DETAIL SHEETS FOR CONSTRUCTION.




2 VIEW TOWARDS CAFE SEATING

NOTE: 3D VIEWS ARE FOR REFERENCE ONLY. REFER TO DETAIL SHEETS FOR CONSTRUCTION.



3 VIEW TOWARDS ENGINE AREA

NOTE: 3D VIEWS ARE FOR REFERENCE ONLY. REFER TO DETAIL SHEETS FOR CONSTRUCTION.

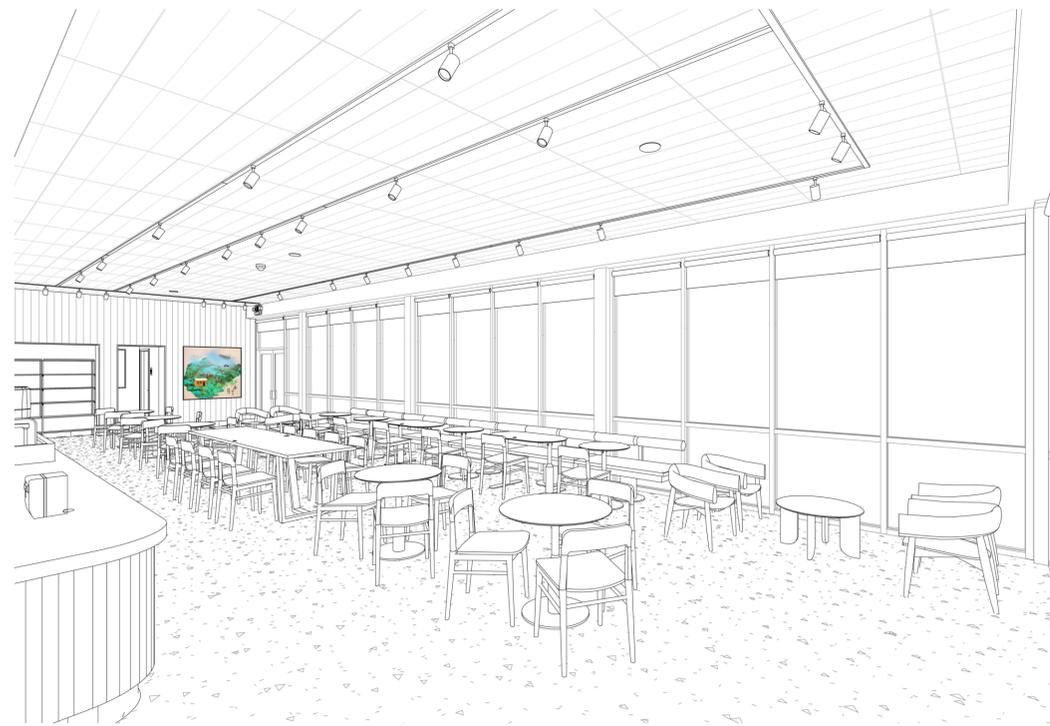

4 VIEW TOWARDS BOOTH SEATING

NOTE: 3D VIEWS ARE FOR REFERENCE ONLY. REFER TO DETAIL SHEETS FOR CONSTRUCTION.



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PRODUCTION DESIGNER: ANDY MCLLOUD
CHECKED BY: DONALD RETHMAN

Revision Schedule			
Rev	Date	By	Description

SHEET TITLE:
PERSPECTIVE VIEW


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I-205

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1 ENLARGED RESTROOM PLAN
Scale: 3/4" = 1'-0"



GENERAL NOTES

- A. GENERAL CONTRACTOR TO VERIFY ALL DIMENSIONS AND NOTIFY STARBUCKS CONSTRUCTION MANAGER OF ANY DISCREPANCIES PRIOR TO CONSTRUCTION.
- B. ALL DIMENSIONS ARE TO BE TAKEN FROM A DESIGNATED DATUM POINT.
- C. DIMENSIONS ARE TO FACE OF FINISHED SURFACE UNLESS OTHERWISE NOTED.
- D. DIAPER CHANGING STATION IS TO BE INSTALLED PER MANUFACTURER'S INSTRUCTIONS. UNIT IS TO BE FASTENED TO STRUCTURE AT ALL SIX CHASSIS ATTACHMENT POINTS.
- E. LOCATE DIAPER CHANGING STATION AS SHOWN TO ALLOW NECESSARY CLEARANCE FOR OPERATION OF ALL RESTROOM FIXTURES. LOCATION SHALL NOT IMPEDE ACCESS, EGRESS, OR DOOR SWING.
- F. ALL RESTROOM ACCESSORY MOUNTING HEIGHTS AND CLEARANCES SHALL COMPLY WITH THE ACCESSIBILITY REQUIREMENTS OF THE LOCAL JURISDICTION.

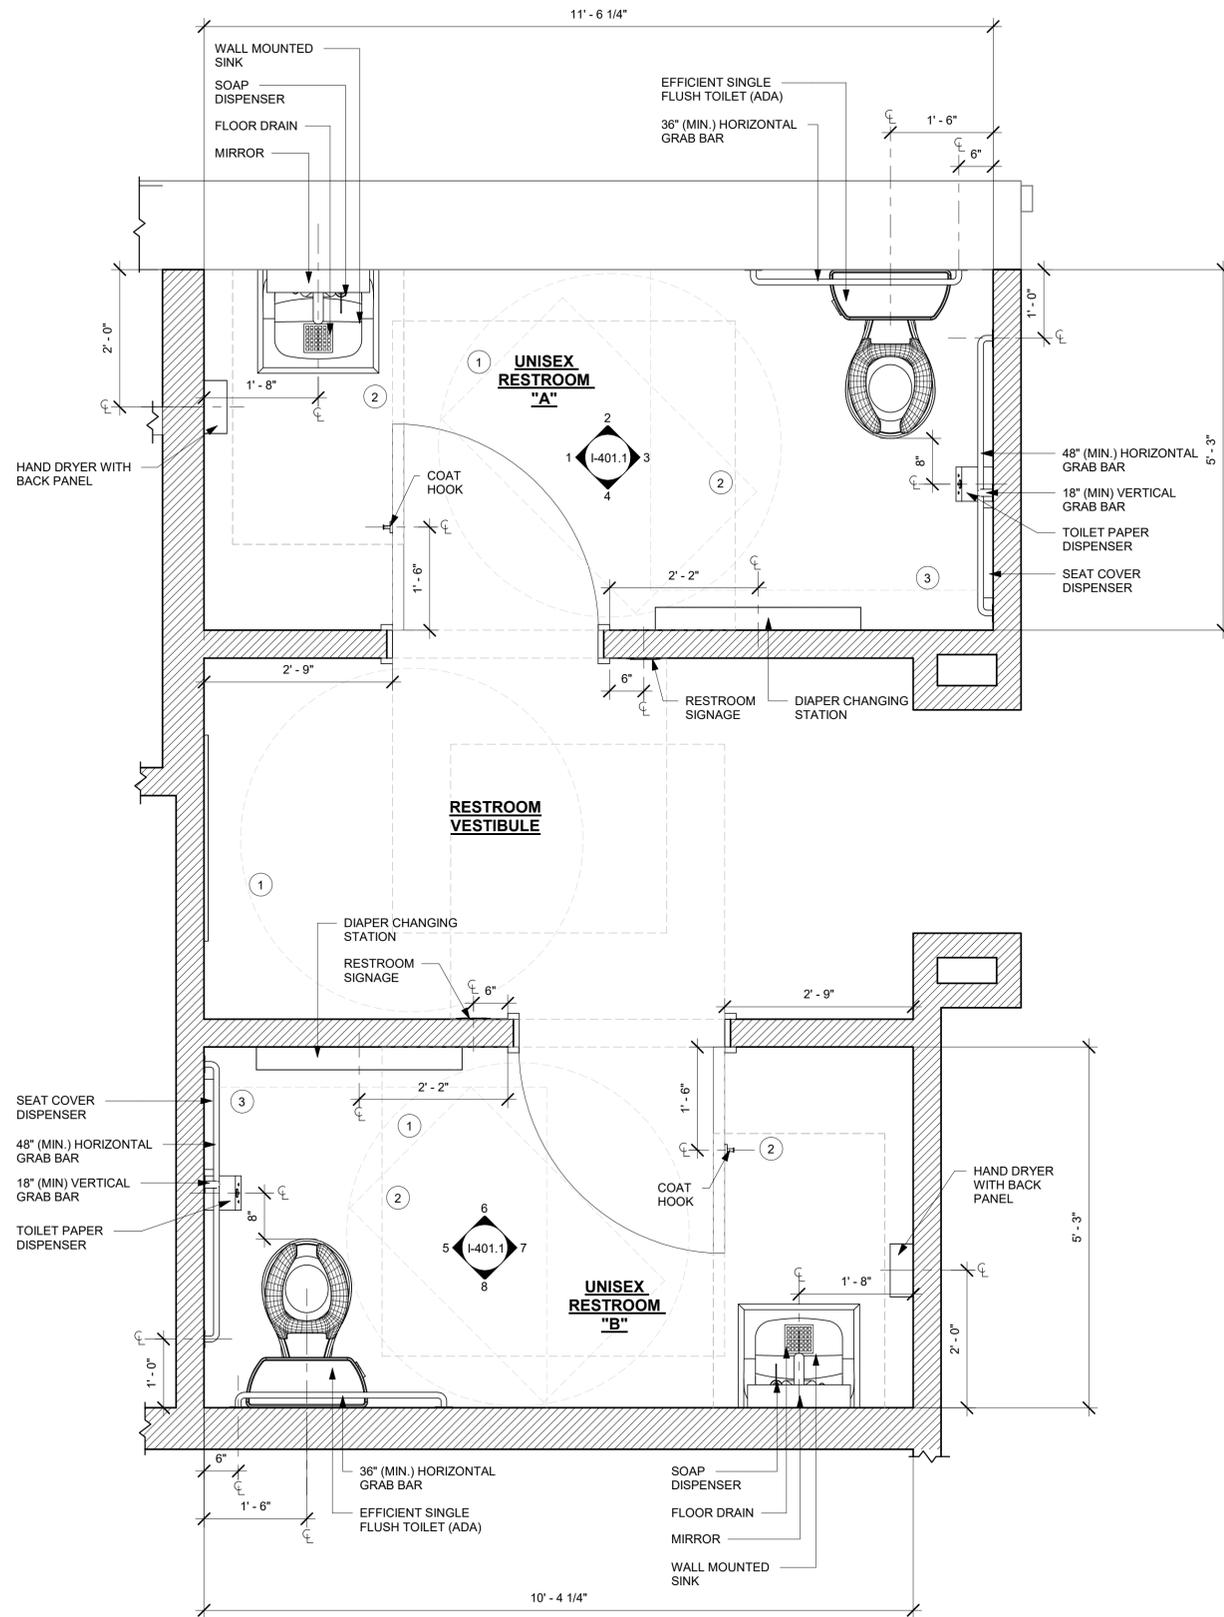DIAPER CHANGING STATION NOTES

- 1. CHANGING STATION IS TO BE INSTALLED PER MANUFACTURER'S INSTRUCTIONS. UNIT IS TO BE FASTENED TO STRUCTURE AT ALL SIX CHASSIS ATTACHMENT POINTS. STANDARD INSTALLATION IS ATTACHMENT TO WOOD STUDS AND/OR WOOD BLOCKING. FOR NON-STANDARD FRAMING CONDITIONS OTHER THAN CONCRETE, USE TOGGLER SNAPTOGGLE HEAVY DUTY TOGGLE BOLTS TO SECURELY ATTACH CHASSIS TO WALL. FOR CONCRETE WALLS, USE FISCHER S-PLUG FIXINGS TO ANCHOR FASTENERS. SUBSTITUTION OF FASTENERS OTHER THAN THE MANUFACTURER AND PRODUCT SPECIFIED IS NOT ALLOWED WITHOUT PRIOR APPROVAL. LOAD TEST AFTER INSTALLATION WITH 100 LB. WEIGHT FOR 15 MINUTES.
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KEYED NOTES

- 1. 60" (1524mm) ADA TURNING DIAMETER.
- 2. 30" (760mm) X 48" (1200MM) CLEAR FLOOR SPACE.
- 3. 60" (1524mm) X 56" (1422MM) WATER CLOSET CLEAR FLOOR SPACE.



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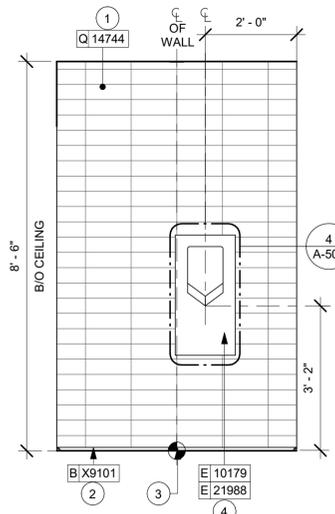
Revision Schedule			
Rev	Date	By	Description

SHEET TITLE:
ENLARGED RESTROOM PLAN


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SHEET NUMBER:
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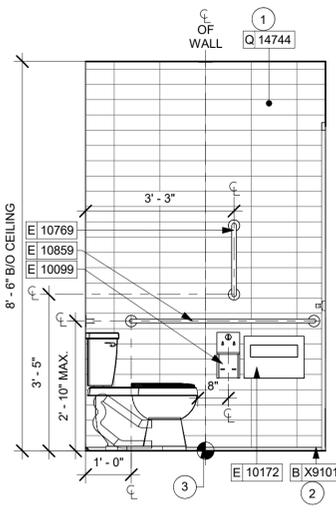
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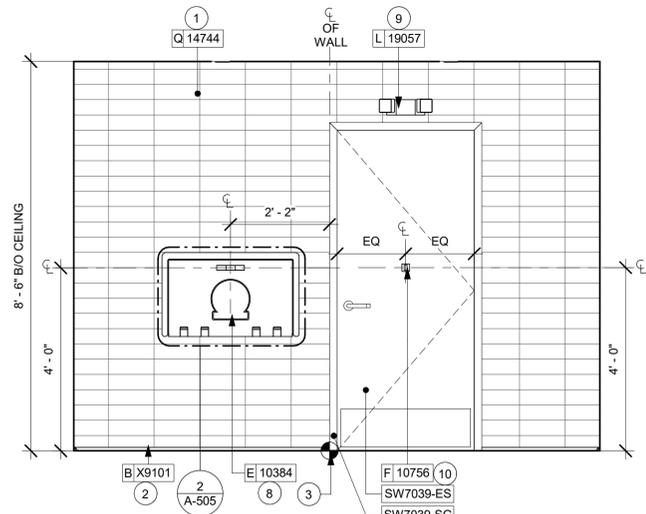
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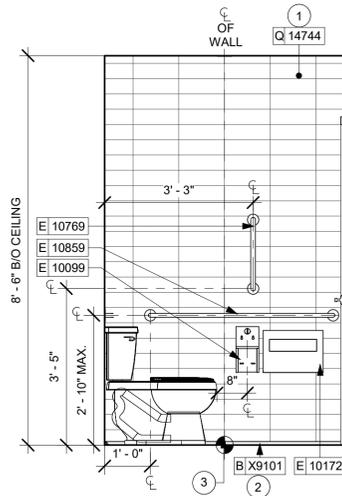
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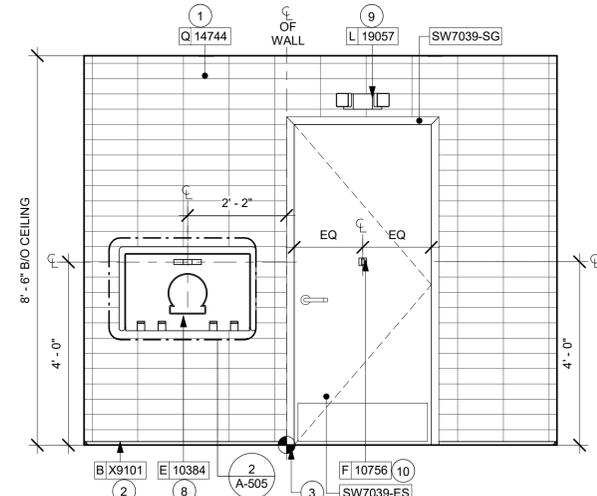
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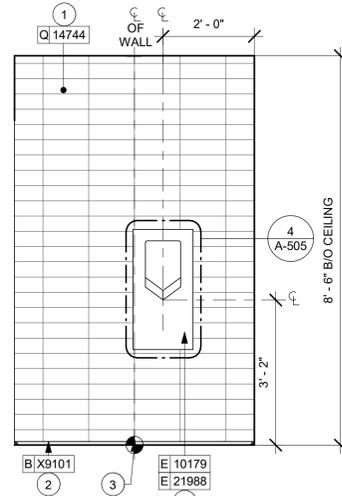
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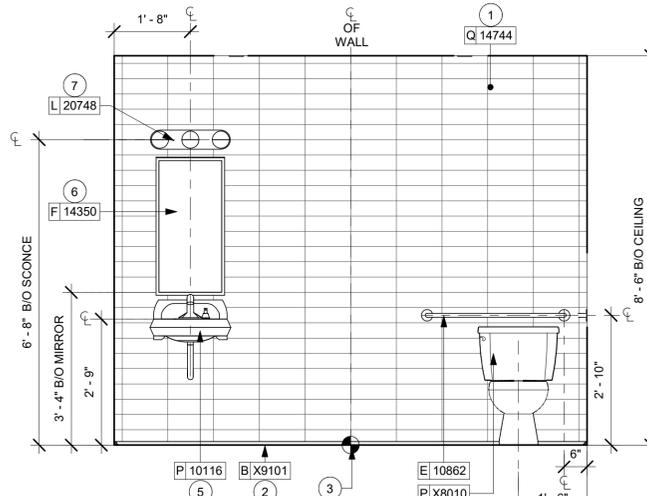
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6 UNISEX RR "B" - EAST
Scale: 1/2" = 1'-0"



7 UNISEX RR "B" - SOUTH
Scale: 1/2" = 1'-0"



8 UNISEX RR "B" - WEST
Scale: 1/2" = 1'-0"

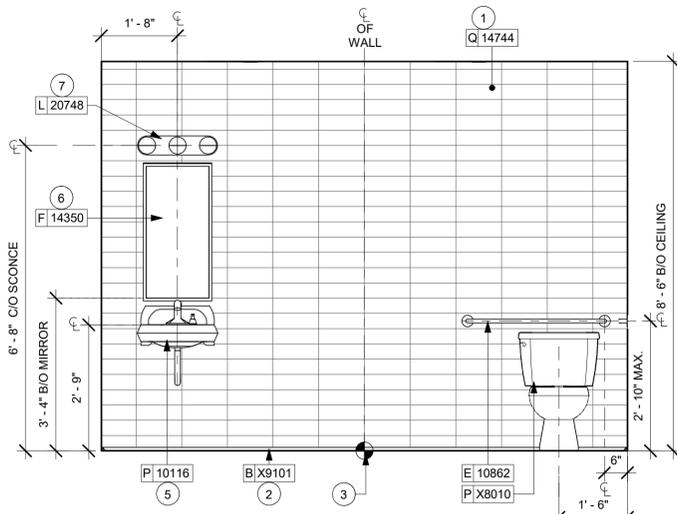

GENERAL NOTES

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KEYED NOTES

- 1. INSTALL WALL TILE AT RESTROOMS AS INDICATED. SEE DETAIL 1/ A-505
- 2. INSTALL METAL SCHLUTER DILEX AHK COVE BASE AS INDICATED.
- 3. TILE START POINT WHERE INDICATED.
- 4. INSTALL HAND DRYER WITH BACK PANEL AS INDICATED.
- 5. WALL MOUNTED LAVATORY SINK INSTALLED WITH INSULATED BOOT AT EXPOSED PIPES.
- 6. CENTER MIRROR OVER LAVATORY SINK. MOUNT AT 40" (1015MM) MAX. TO BOTTOM EDGE OF REFLECTIVE SURFACE. SEE DETAIL 6/ A-505
- 7. CENTER SCENCE LIGHTING OVER MIRROR.
- 8. BABY CHANGING FIXTURE. GENERAL CONTRACTOR TO PROVIDE BLOCKING PER MANUFACTURER'S RECOMMENDATION.
- 9. INSTALL EMERGENCY LIGHT AS INDICATED.
- 10. INSTALL COAT HOOK. MOUNT AT CENTERLINE OF DOOR.



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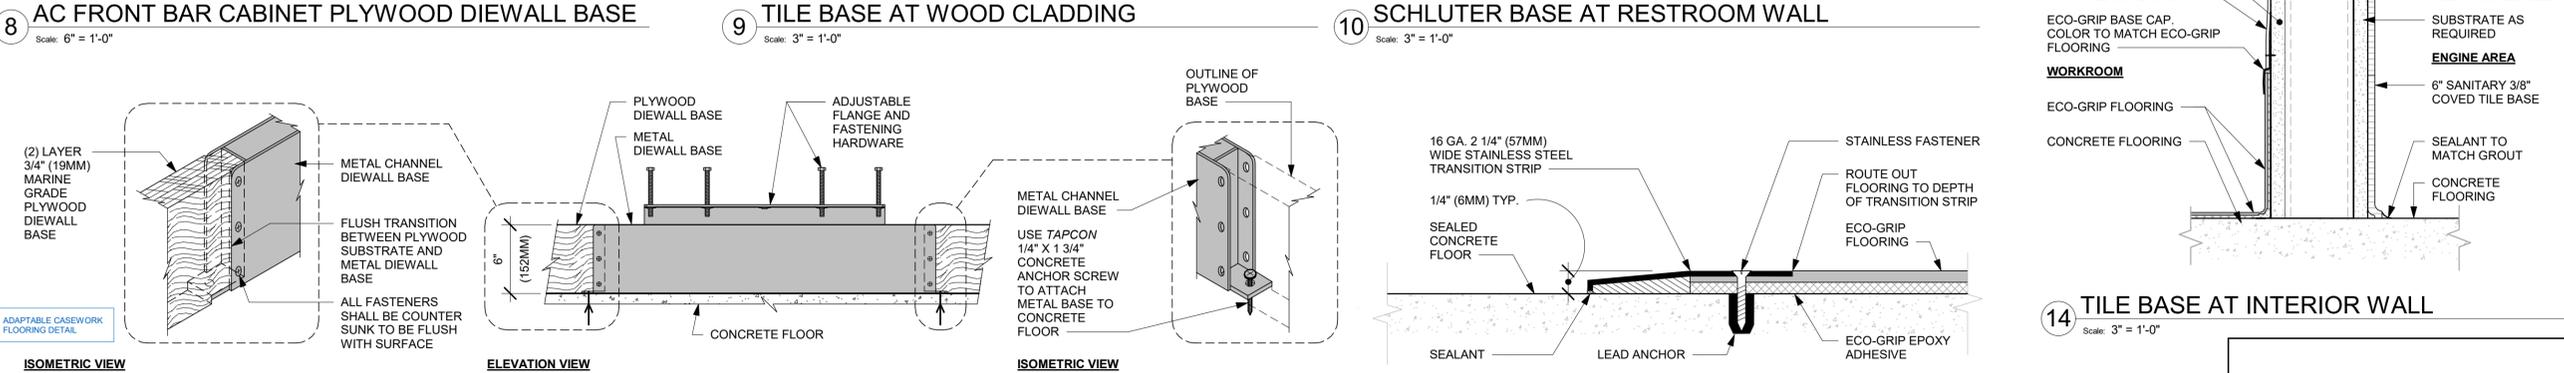
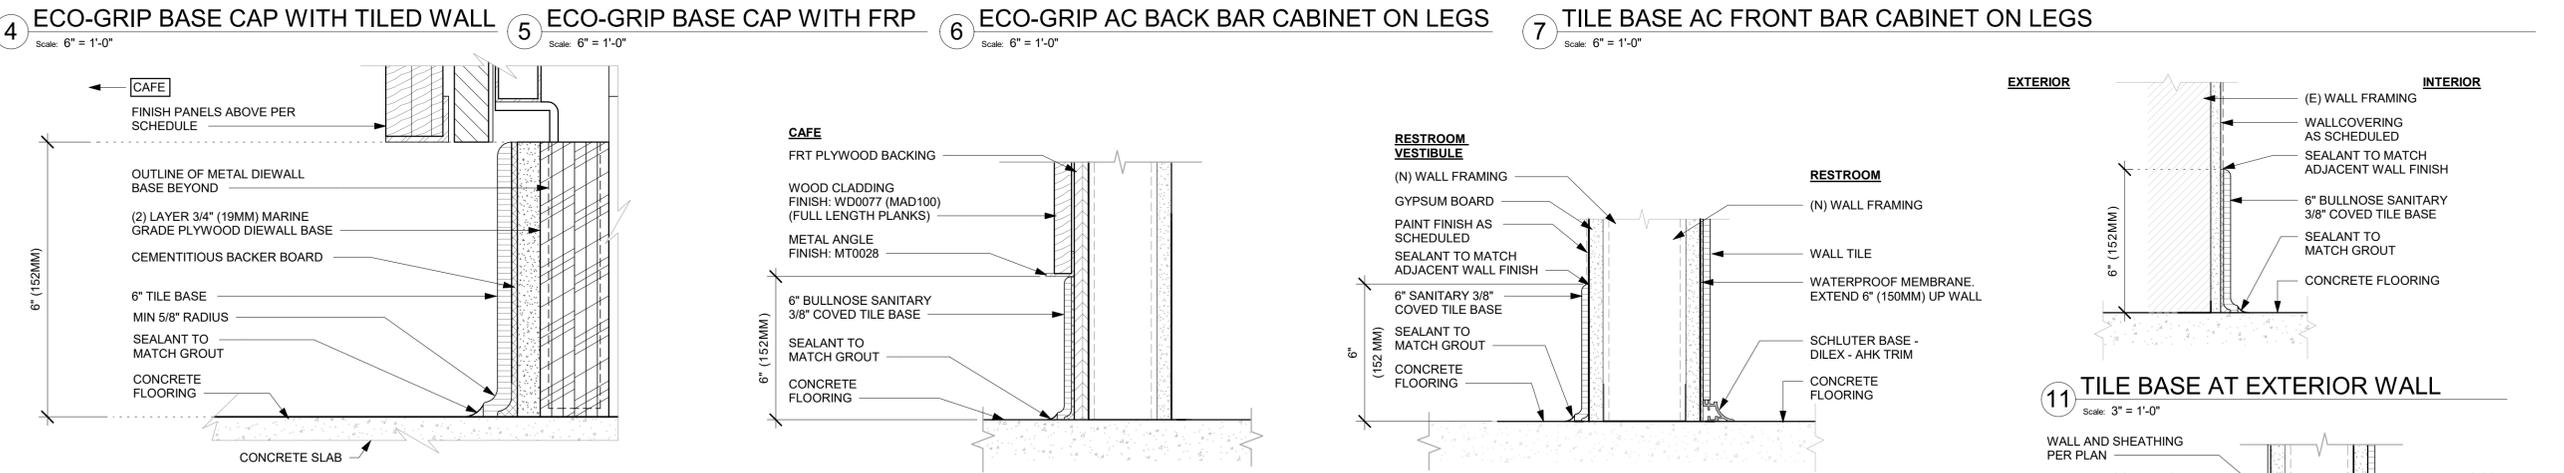
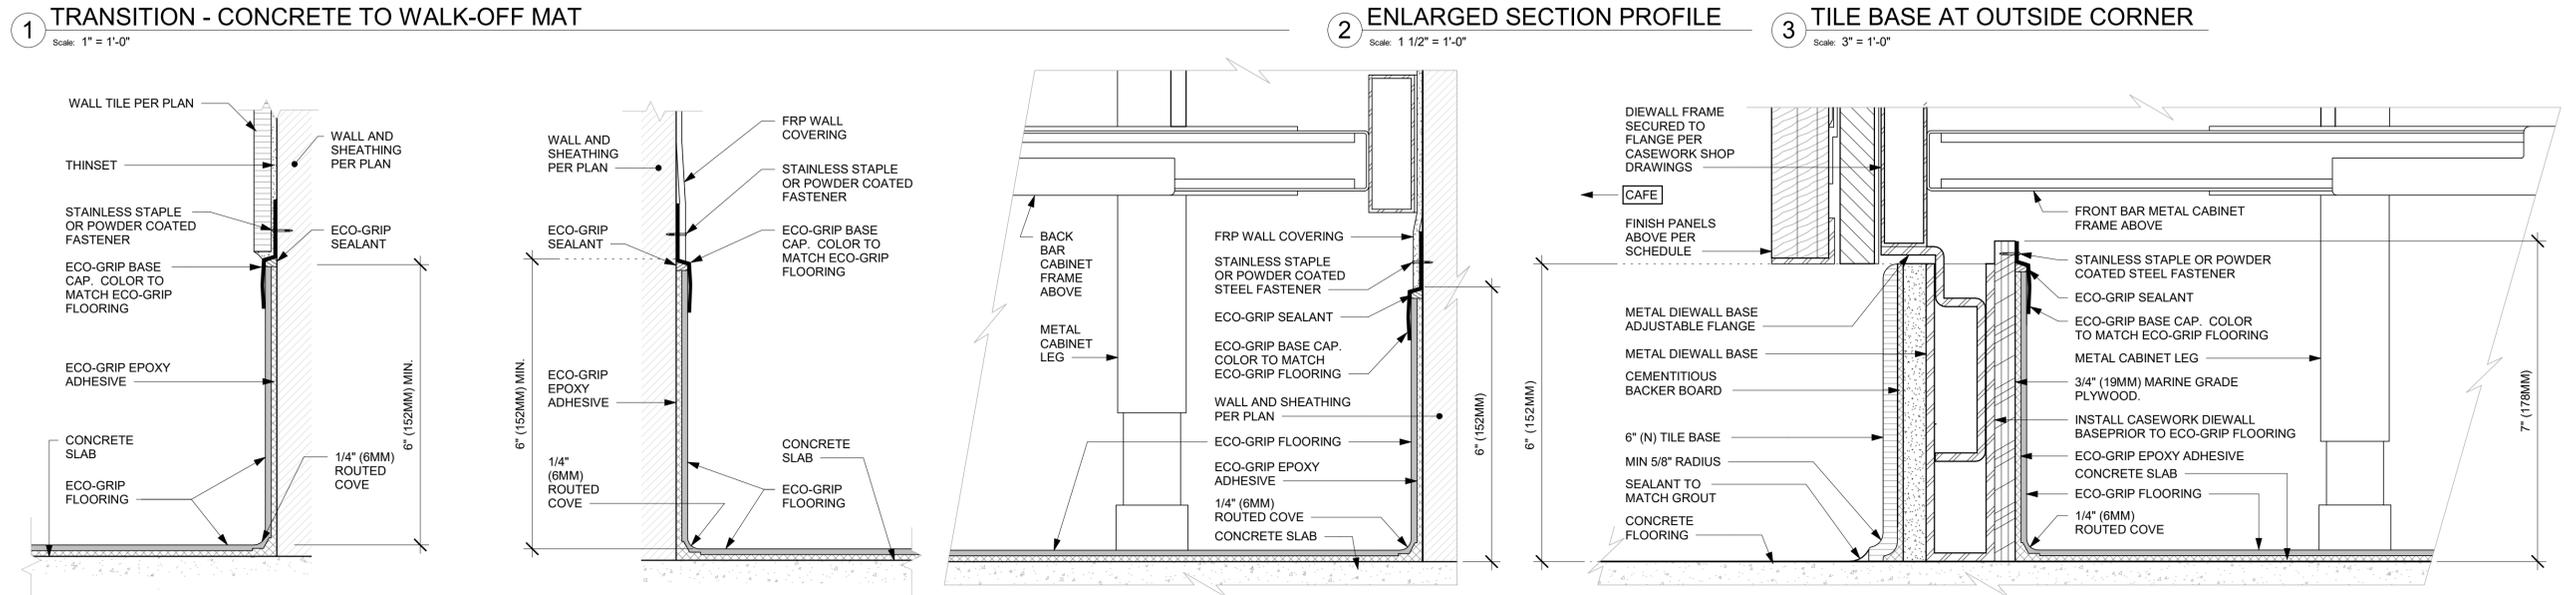
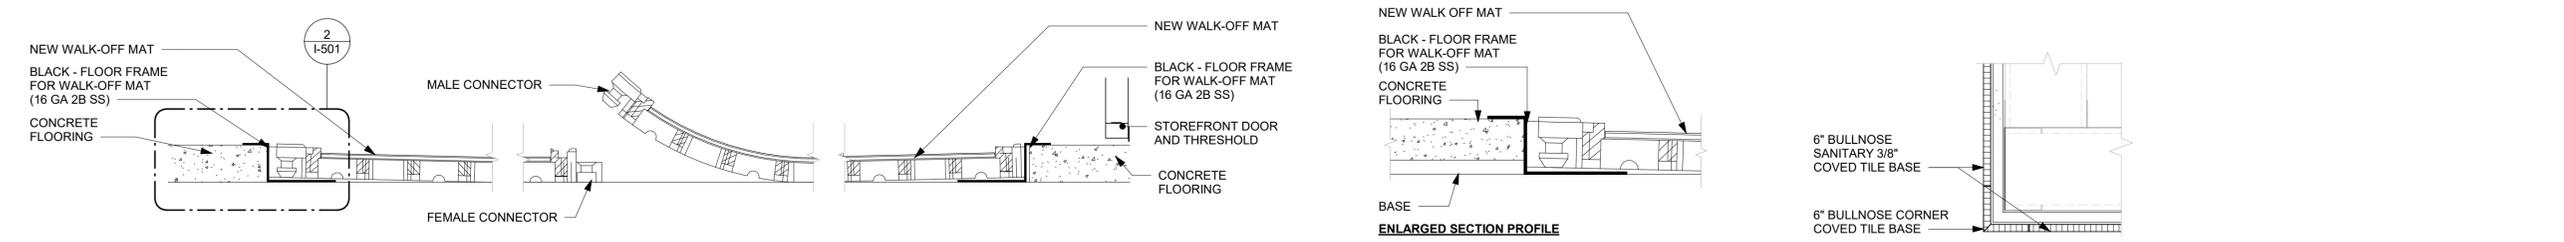
Revision Schedule			
Rev	Date	By	Description

SHEET TITLE:
ENLARGED RESTROOM ELEVATIONS
SCALE: 1/2" = 1'-0"

SHEET NUMBER:
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STARBUCKS TEMPLATE VERSION: I2022-11-17

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Timothy L. Raberding, PE
Professional Engineer
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FOR CONSTRUCTION

PROJECT NAME:
LECANTO HWY & NORVELL BRYANT

PROJECT ADDRESS:
**3159 W NORVELL BRYANT HWY
LECANTO, FL 34461**

STORE #: 78366
PROJECT #: 97107-001
ISSUE DATE: 09/06/2023
DESIGNER: RAI MONTERO
PRODUCTION DESIGNER: ANDY MCLLOUD
CHECKED BY: DONALD RETHMAN

Revision Schedule			
Rev	Date	By	Description


SHEET TITLE:
FLOOR FINISH DETAILS

SCALE: AS SHOWN


SHEET NUMBER:
I-501

BLD202323715


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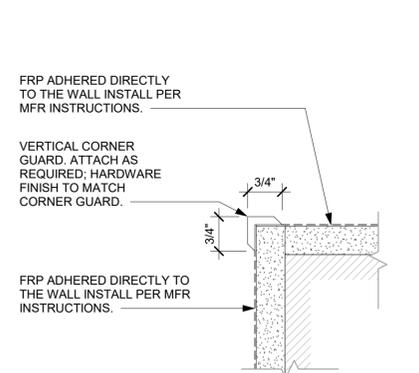
6 FRP AT BACKLINE CABINETS
Scale: 1 1/2" = 1'-0"

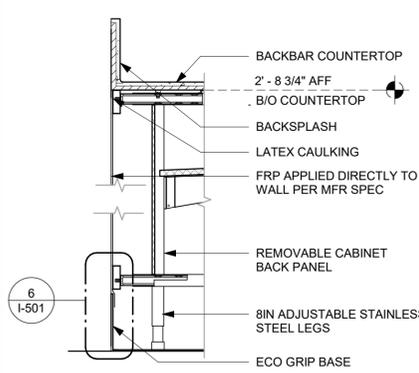


2 WALL TILE ABOVE SS BACKSPASH
Scale: 3" = 1'-0"

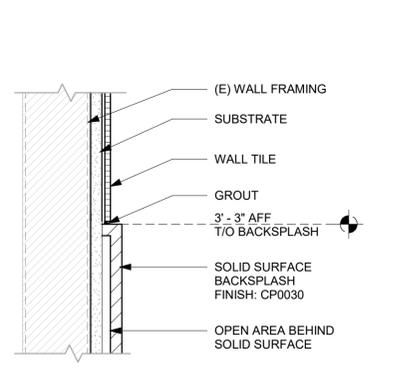


3 WALL TILE ABOVE SST BACKSPASH
Scale: 3" = 1'-0"

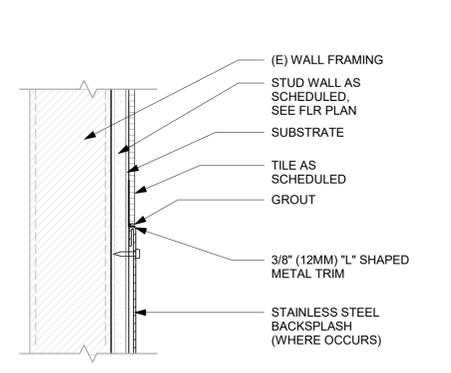


4 10829 - CORNER GUARD DETAIL
Scale: 6" = 1'-0"

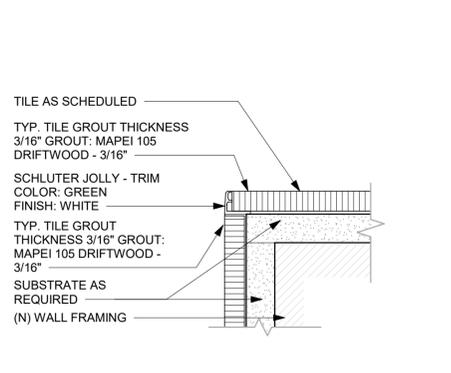


5 TILE CORNER - SCHLUTER TRIM
Scale: 6" = 1'-0"

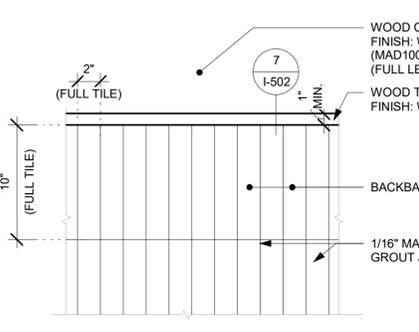


6 BACKBAR WALL TILE PATTERN
Scale: 1 1/2" = 1'-0"

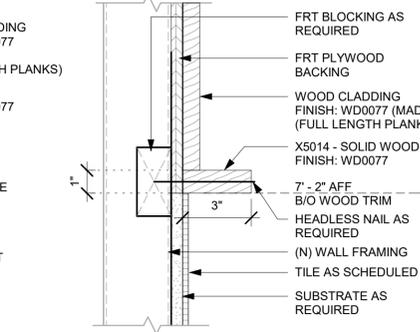


7 X5014 - WOOD TRIM DETAIL
Scale: 3" = 1'-0"

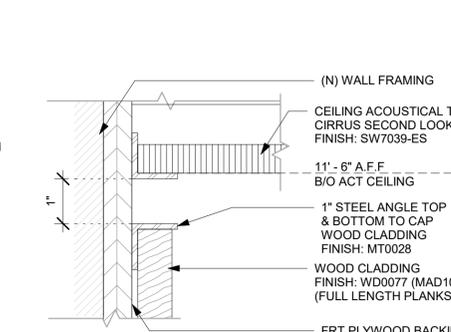


8 DETAIL AT CLADDING TOP1
Scale: 6" = 1'-0"

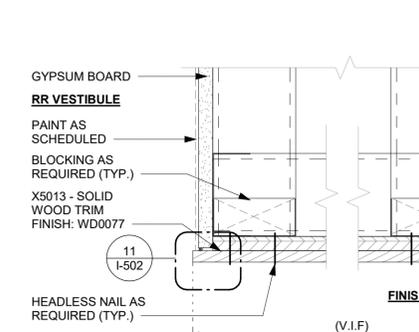


9 X5013 - FINISH EDGE AT RR VESTIBULE
Scale: 3" = 1'-0"

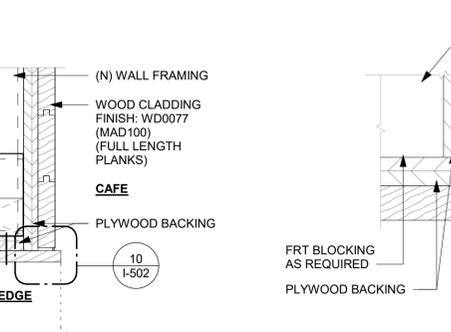


10 WOOD EDGE DETAIL
Scale: 6" = 1'-0"

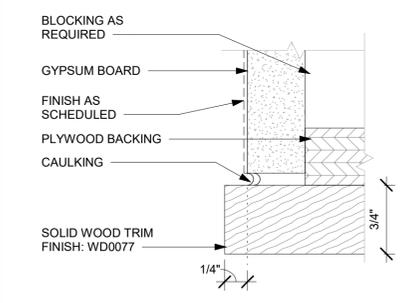


11 CAULKING DETAIL
Scale: 12" = 1'-0"

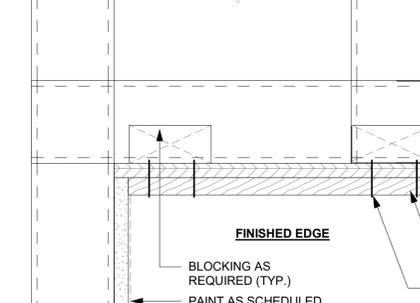


12 X5012 - FINISH EDGE AT MERCH
Scale: 3" = 1'-0"

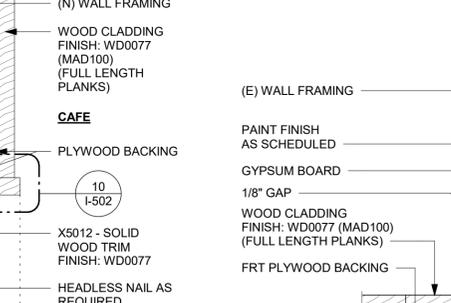


13 TRANSITION - PAINT TO WOOD
Scale: 6" = 1'-0"

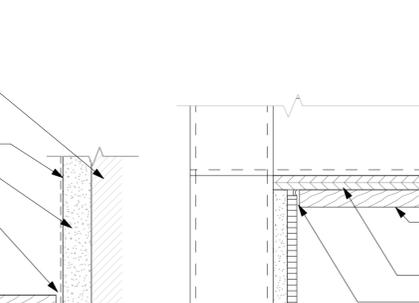


14 TRANSITION - WOOD TO TILE
Scale: 3" = 1'-0"

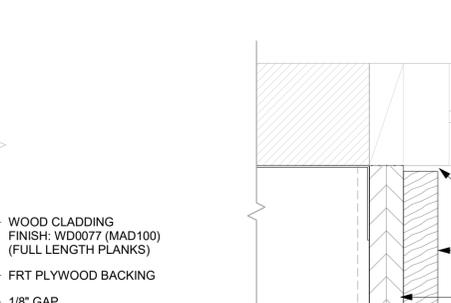


15 WOOD CLADDING END AT STOREFRONT
Scale: 6" = 1'-0"

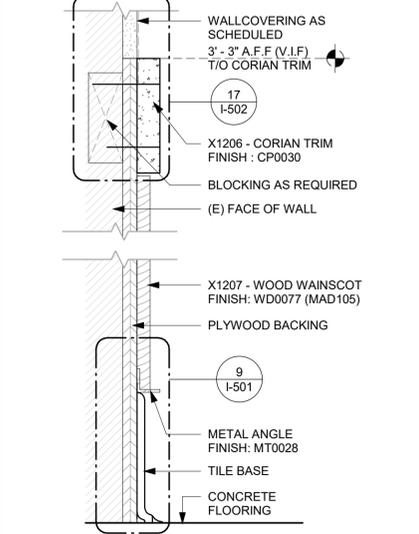


16 WOOD WAINSCOT
Scale: 3" = 1'-0"

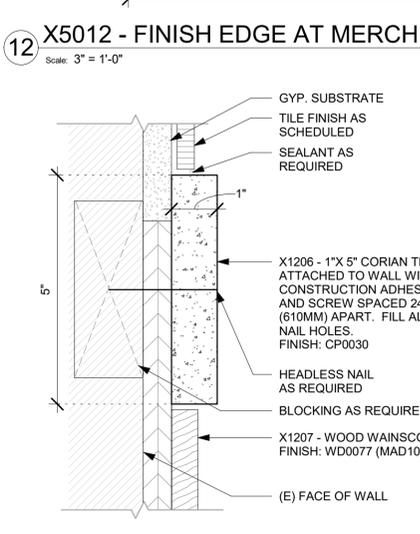


17 WOOD TRIM ATTACHMENT
Scale: 6" = 1'-0"

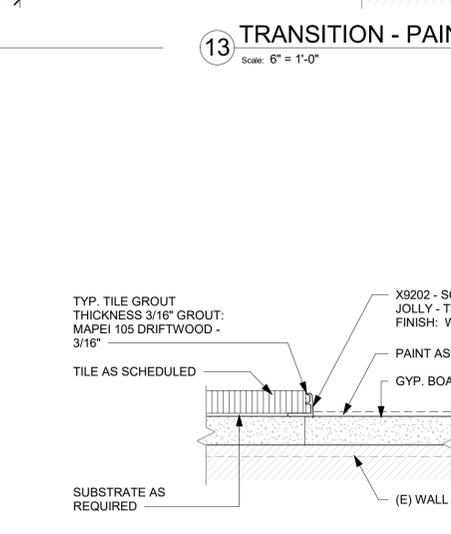

18 TRANSITION - TILE TO PAINT
Scale: 6" = 1'-0"

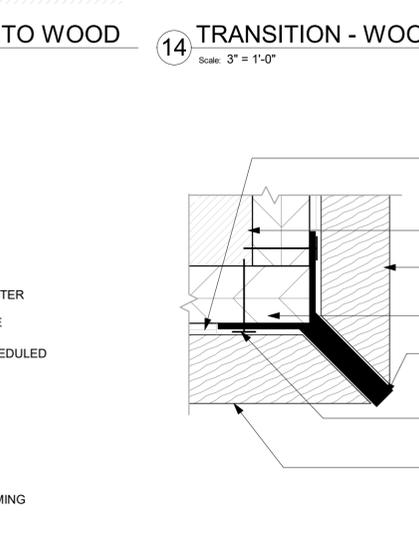

19 Y-TRIM DETAIL AT WOOD CORNER
Scale: 12" = 1'-0"

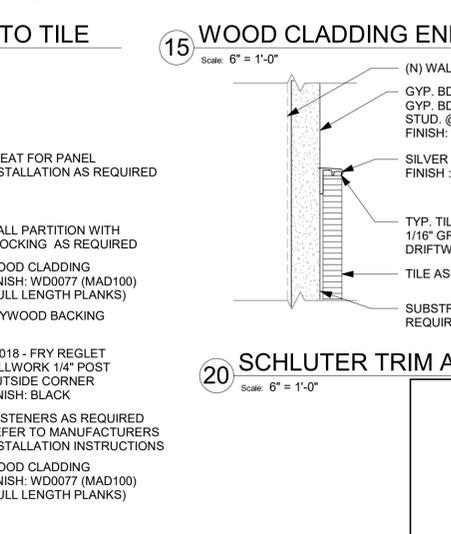

20 SCHLUTER TRIM AT TILE TOP
Scale: 6" = 1'-0"

FOR CONSTRUCTION




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PROJECT NAME:
LECANTO HWY & NORVELL BRYANT

PROJECT ADDRESS:
**3159 W NORVELL BRYANT HWY
LECANTO, FL 34461**

STORE #: 78366
PROJECT #: 97107-001
ISSUE DATE: 09/06/2023
DESIGNER: RAI MONTERO
PRODUCTION DESIGNER: ANDY MCLOUD
CHECKED BY: DONALD RETHMAN

Revision Schedule			
Rev	Date	By	Description

SHEET TITLE:
WALL FINISH DETAILS

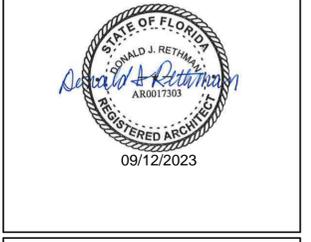SCALE: AS SHOWN

SHEET NUMBER:
I-502

BLD202323715



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FOR CONSTRUCTION

PROJECT NAME:
LECANTO HWY & NORVELL BRYANT

PROJECT ADDRESS:
**3159 W NORVELL BRYANT HWY
LECANTO, FL 34461**

STORE #: 78366
PROJECT #: 97107-001
ISSUE DATE: 09/06/2023
DESIGNER: RAI MONTERO
PRODUCTION DESIGNER: ANDY MCLLOUD
CHECKED BY: DONALD RETHMAN


Revision Schedule			
Rev	Date	By	Description

SHEET TITLE:
INTERIOR DETAILS

SCALE: 3/4" = 1'-0"


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I-503

BLD202323715

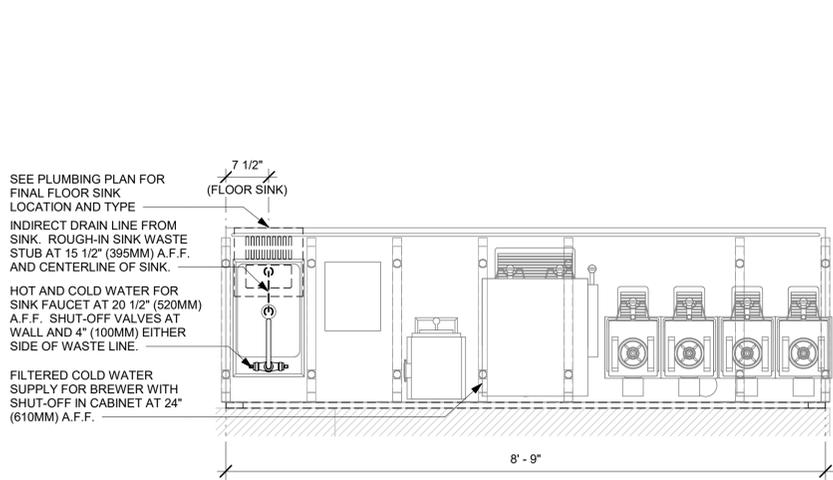


2 BREW - PLUMBING FOR REFERENCE ONLY

Scale: 3/4" = 1'-0"

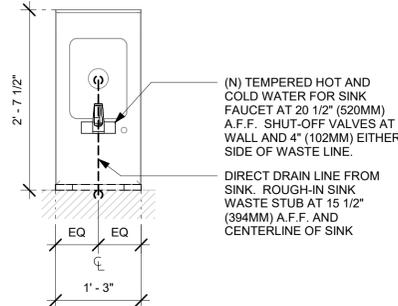


3 HAND SINK - PLUMBING FOR REFERENCE ONLY

Scale: 3/4" = 1'-0"

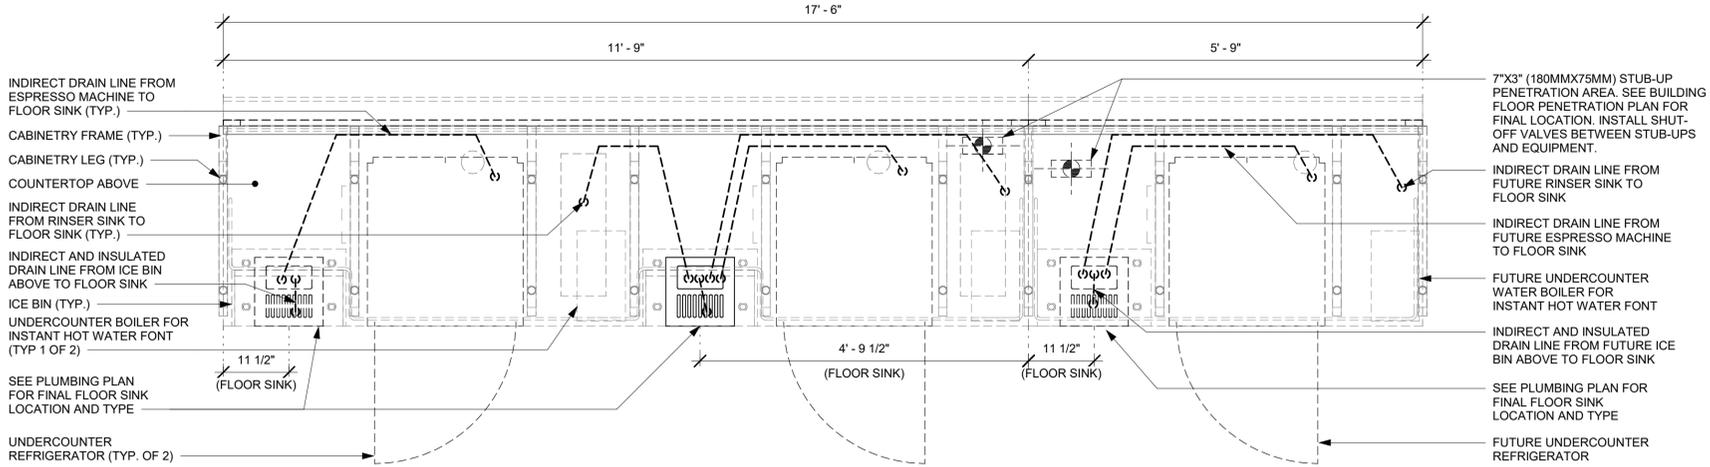

1 ESPRESSO - PLUMBING FOR REFERENCE ONLY

Scale: 3/4" = 1'-0"


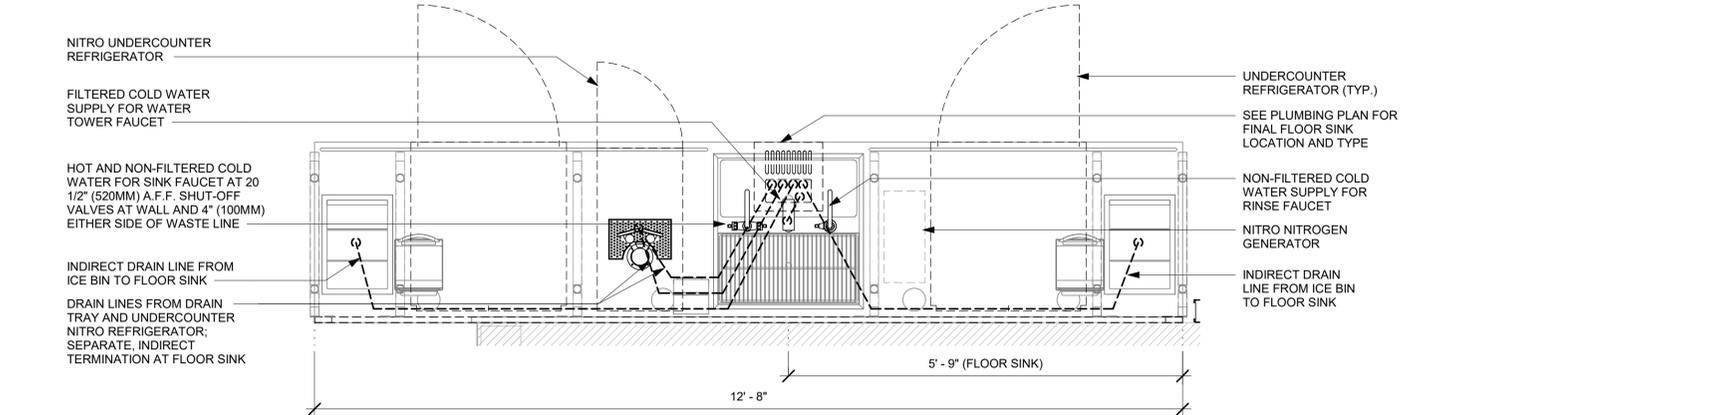


4 CBE - PLUMBING FOR REFERENCE ONLY


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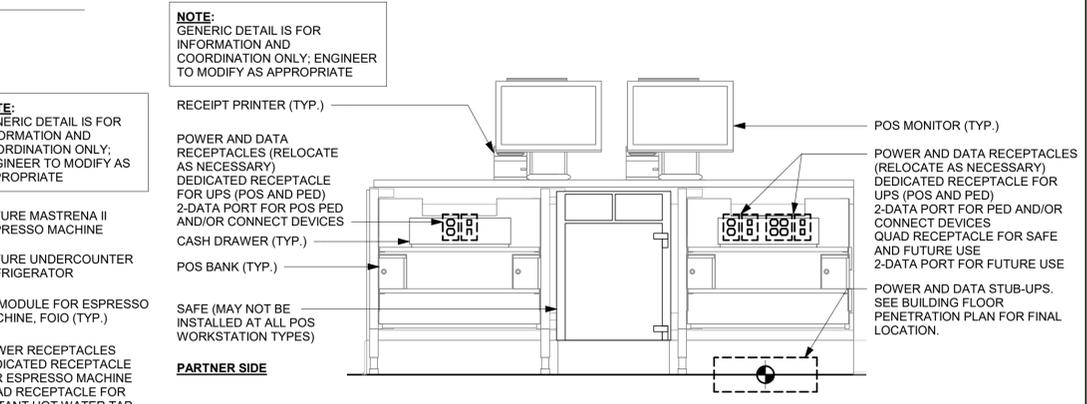
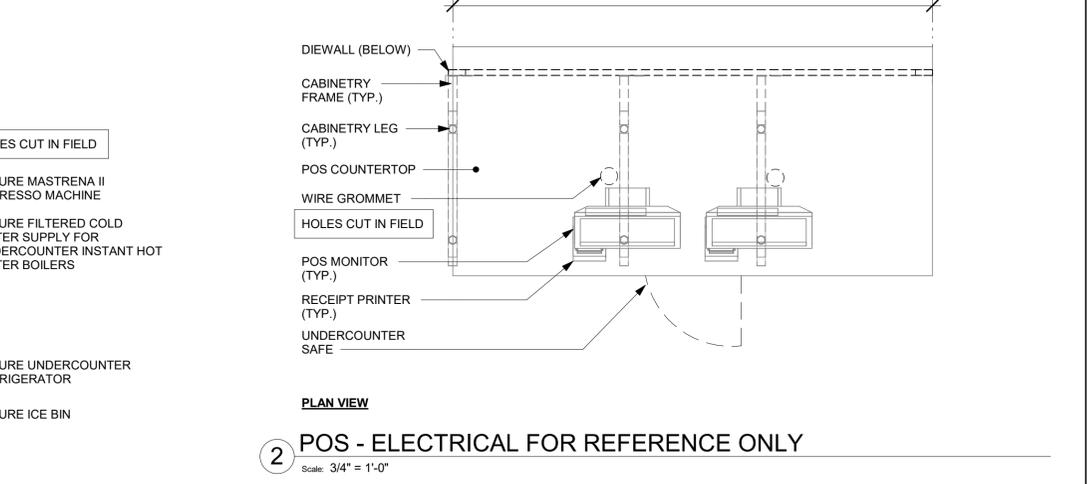
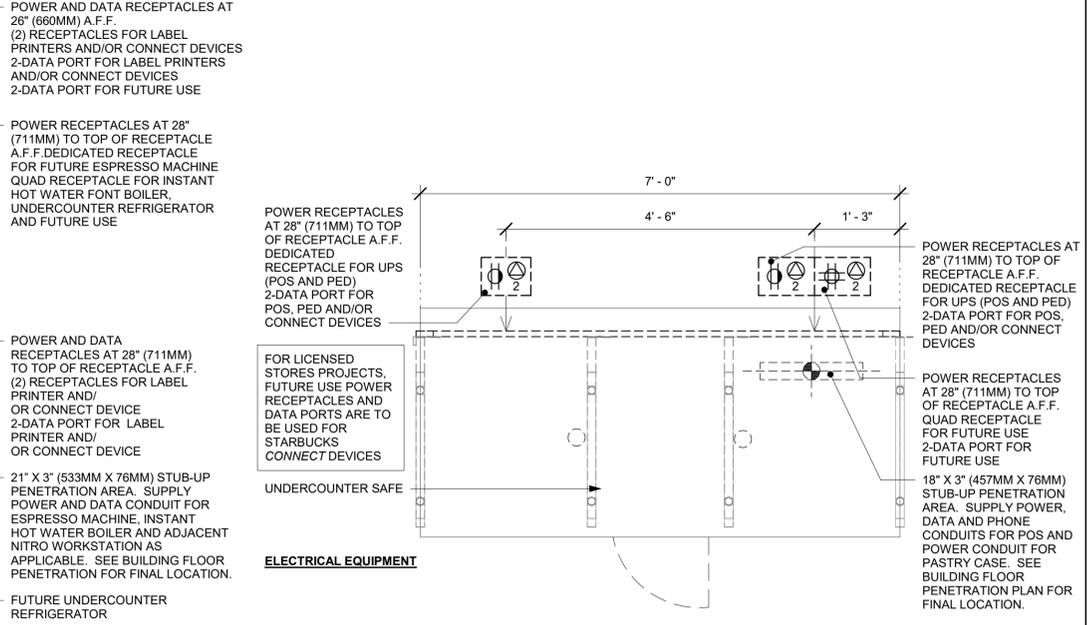
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1 ESPRESSO - ELECTRICAL FOR REFERENCE ONLY
Scale: 3/4" = 1'-0"



3 GENERIC METRO BAR MEP DIAGRAM
Scale: 3/4" = 1'-0"

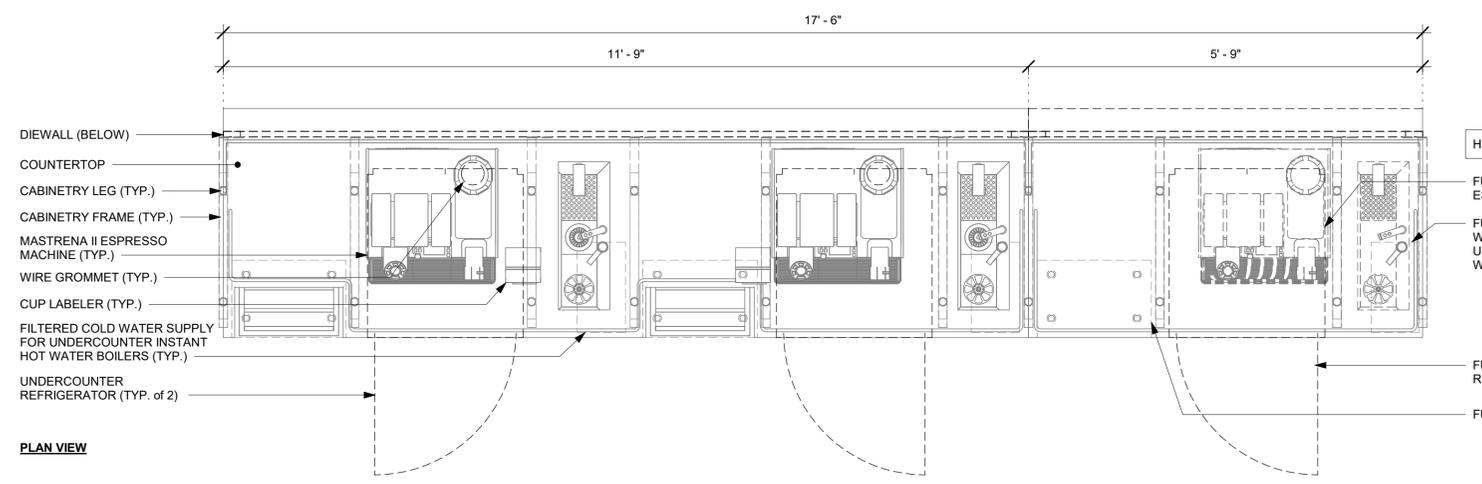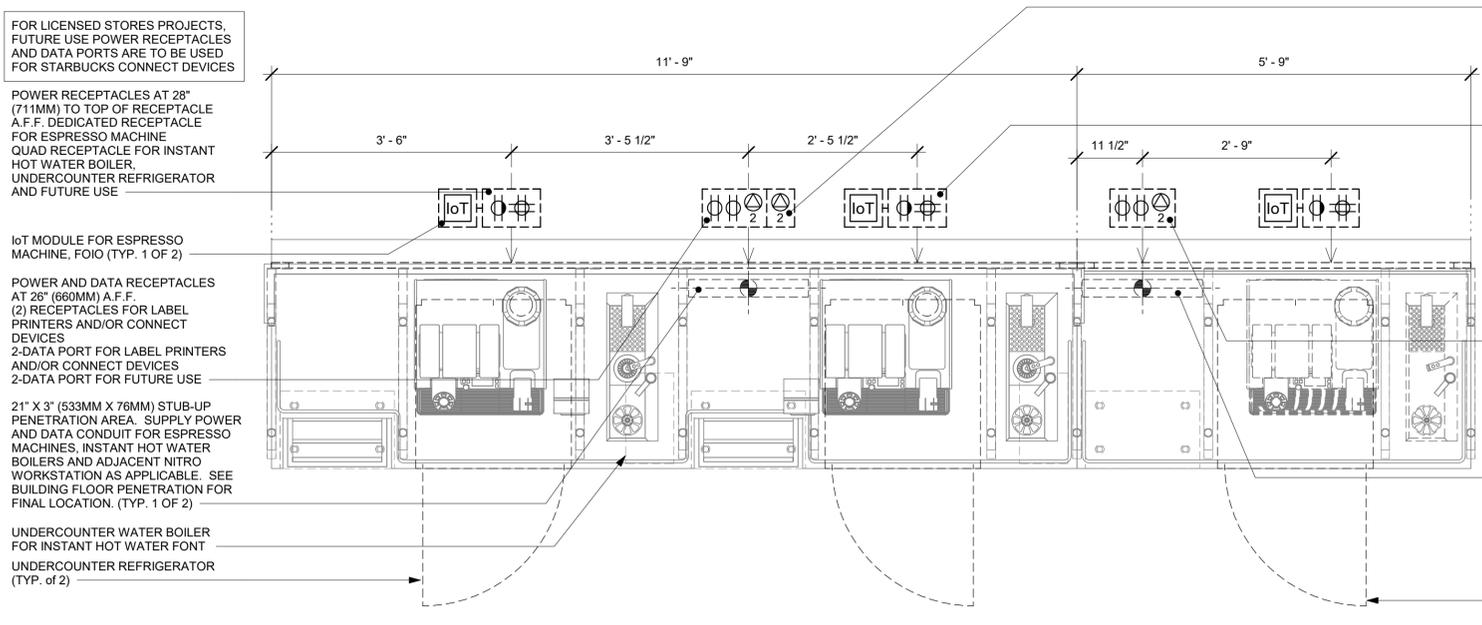

4 DOUBLE POS MEP DIAGRAM FOR REFERENCE ONLY
Scale: 3/4" = 1'-0"

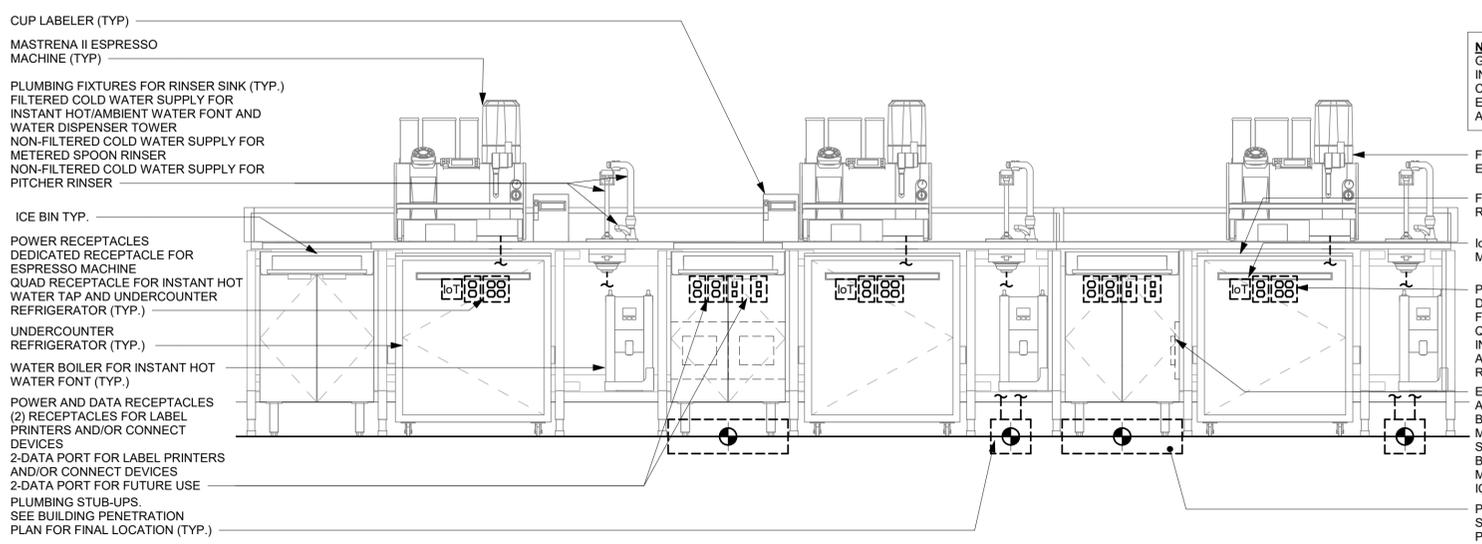

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FOR CONSTRUCTION

PROJECT NAME:
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PROJECT ADDRESS:
**3159 W NORVELL BRYANT HWY
LECANTO, FL 34461**

STORE #: 78366
PROJECT #: 97107-001
ISSUE DATE: 09/06/2023
DESIGNER: RAI MONTERO
PRODUCTION DESIGNER: ANDY MCLLOUD
CHECKED BY: DONALD RETHMAN

Revision Schedule			
Rev	Date	By	Description

SHEET TITLE:
INTERIOR DETAILS

SCALE: 3/4" = 1'-0"

SHEET NUMBER:
I-504

BLD202323715



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09/12/2023

FOR CONSTRUCTION

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PROJECT ADDRESS:
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STORE #: 78366
PROJECT #: 97107-001
ISSUE DATE: 09/06/2023
DESIGNER: RAI MONTERO
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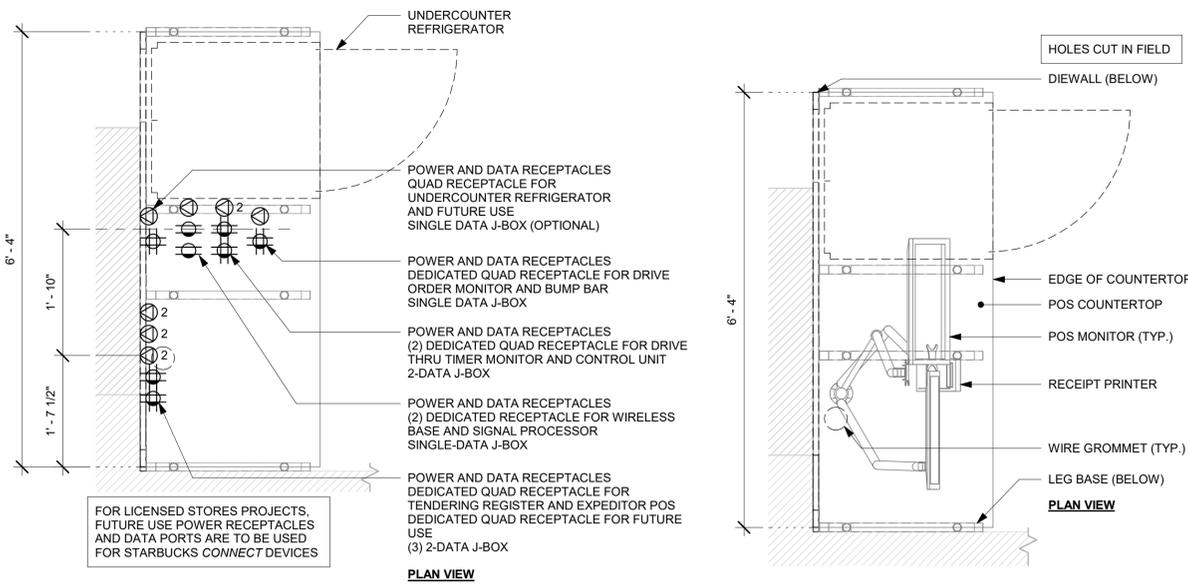
Revision Schedule			
Rev	Date	By	Description

SHEET TITLE:
INTERIOR DETAILS

SCALE: 3/4" = 1'-0"


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I-505

BLD202323715




1 DT POS - ELECTRICAL FOR REFERENCE ONLY

Scale: 3/4" = 1'-0"

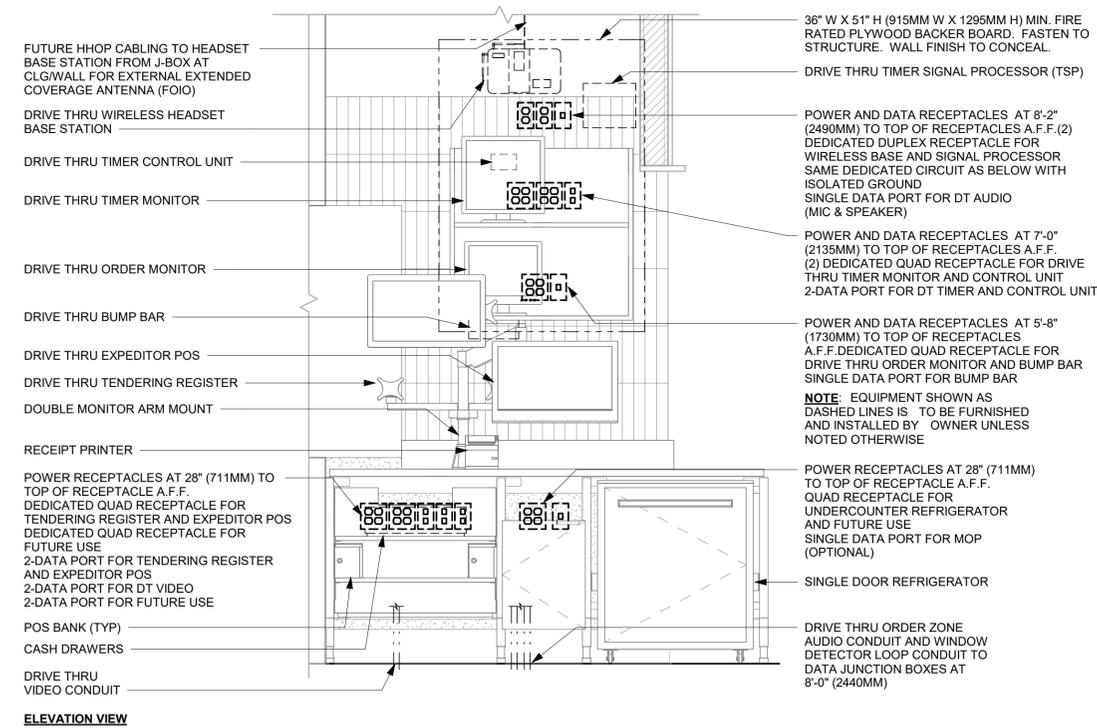


3 DRIVE - THRU POS DIAGRAM FOR REFERENCE ONLY

Scale: 3/4" = 1'-0"

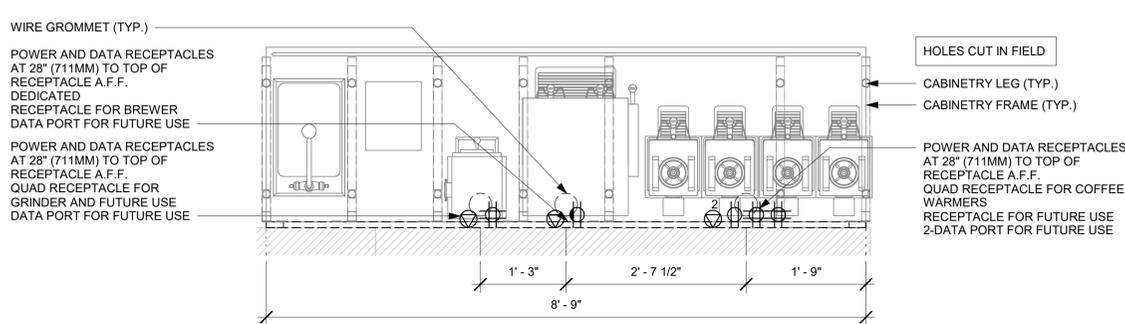


5 BREW - ELECTRICAL FOR REFERENCE ONLY

Scale: 3/4" = 1'-0"

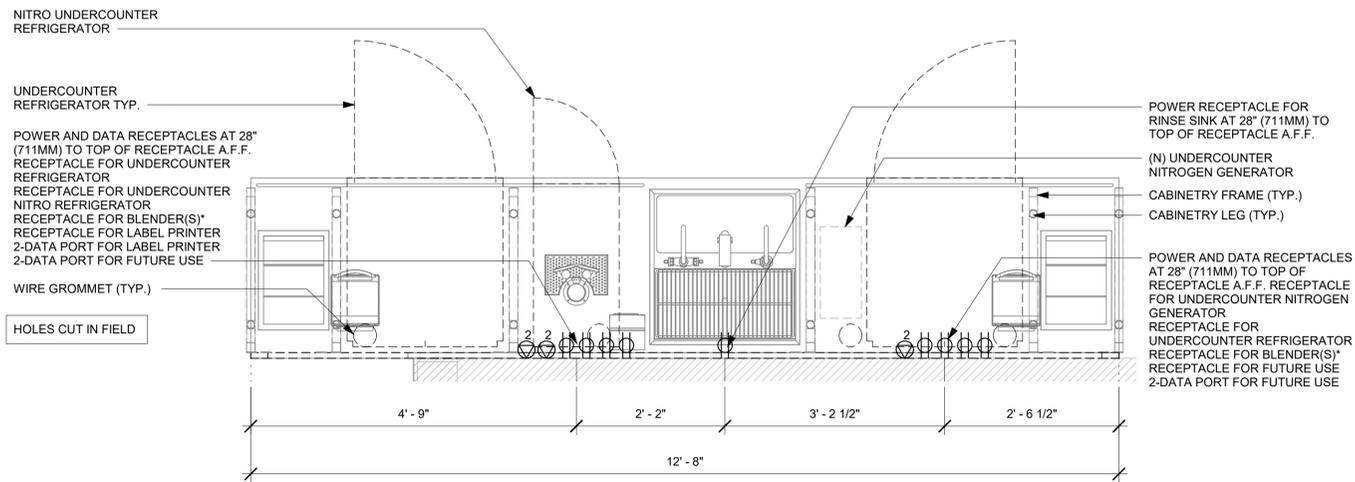


2 CBE - ELECTRICAL FOR REFERENCE ONLY

Scale: 3/4" = 1'-0"

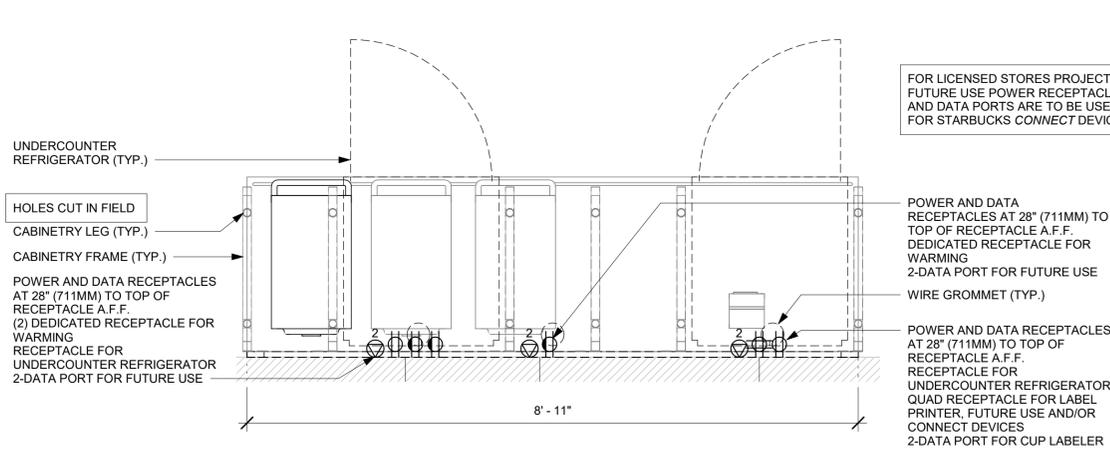

4 WARMING - ELECTRICAL FOR REFERENCE ONLY

Scale: 3/4" = 1'-0"

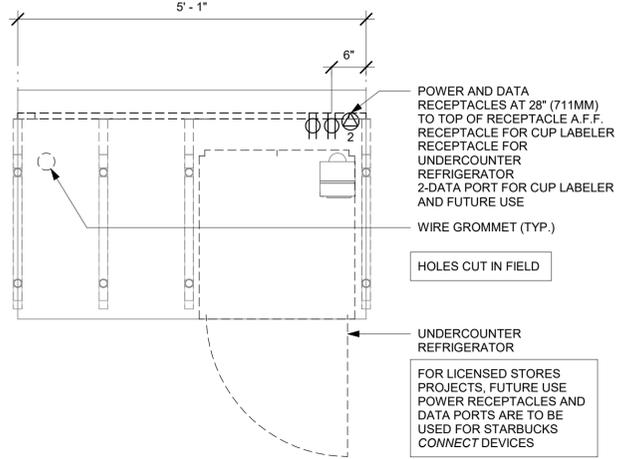

6 MOP - ELECTRICAL FOR REFERENCE ONLY

Scale: 3/4" = 1'-0"


FOR LICENSED STORES PROJECTS, FUTURE USE POWER RECEPTACLES AND DATA PORTS ARE TO BE USED FOR STARBUCKS CONNECT DEVICES

FOR LICENSED STORES PROJECTS, FUTURE USE POWER RECEPTACLES AND DATA PORTS ARE TO BE USED FOR STARBUCKS CONNECT DEVICES



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9/6/2023 11:16:36 AM

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PLAN VIEW

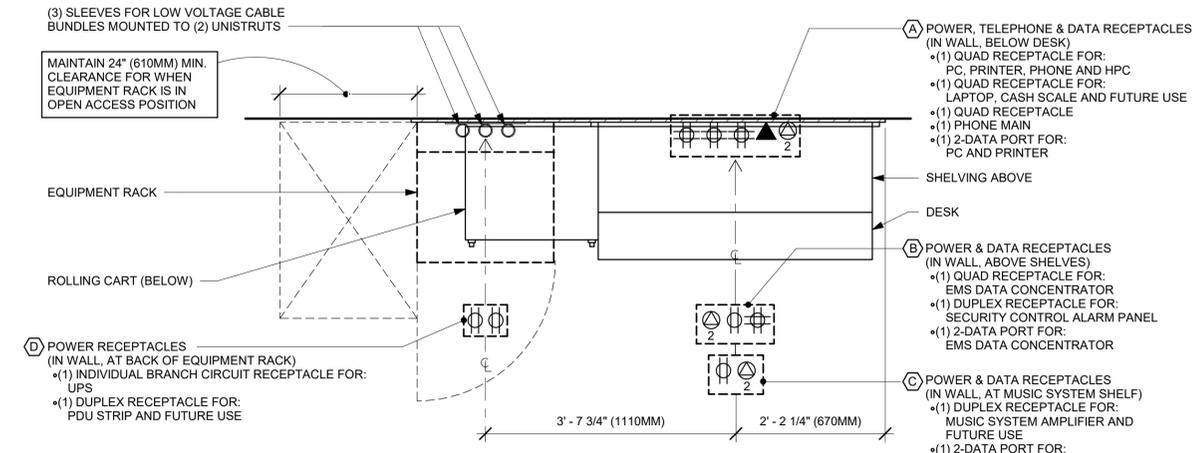


ELEVATION VIEW


NOTE: EQUIPMENT SHOWN AS DASHED LINES IS TO BE FURNISHED AND INSTALLED BY OWNER UNLESS NOTED OTHERWISE.

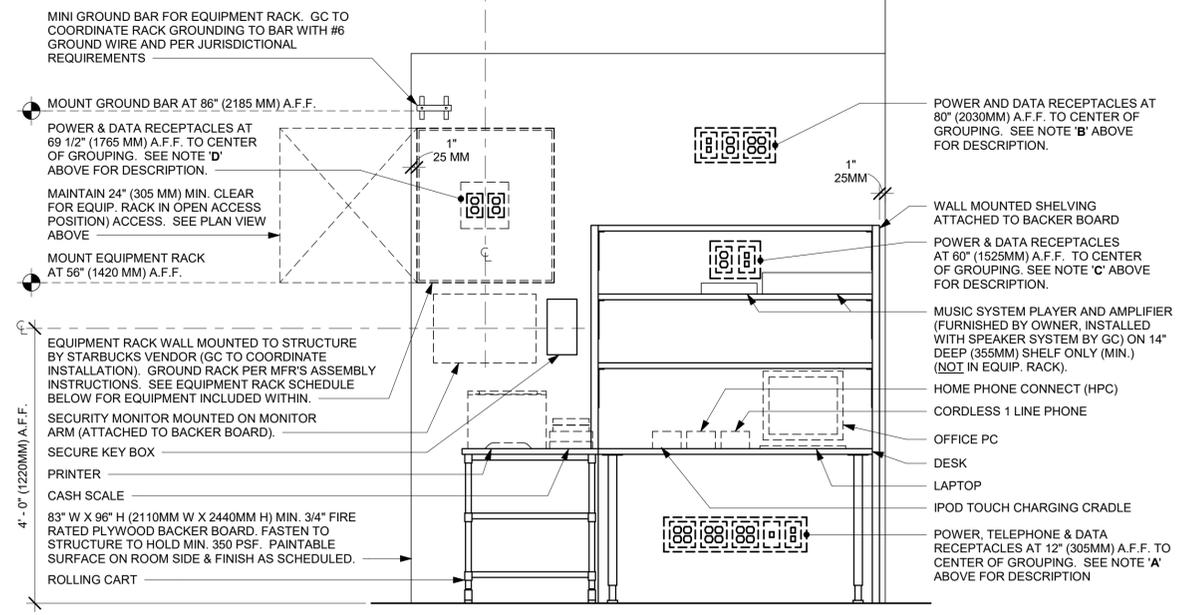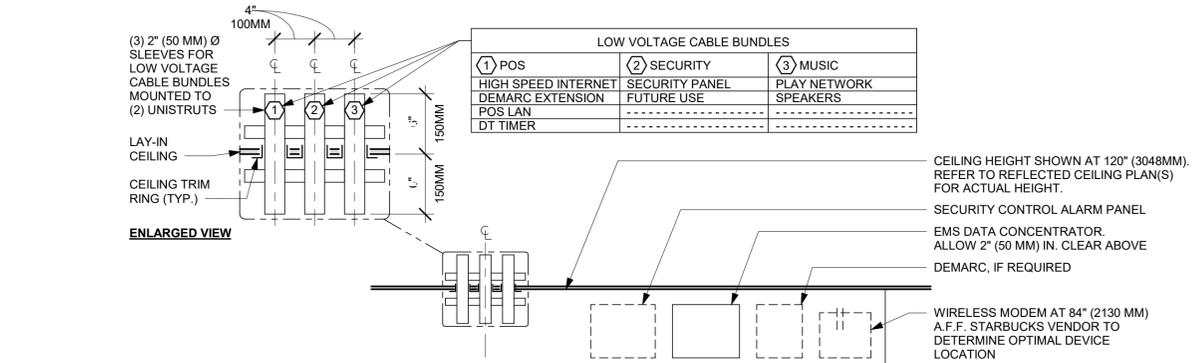EQUIPMENT RACK SCHEDULE		
UPS	NETWORK SWITCH	SECURITY RECORDER (NVR)
IPS EQUIPMENT	PATCH PANEL	SECURITY KEYBOARD
ROUTER	PRODUCTION CONTROLLER DEVICES	


1 MANAGER DESK (NEW) AND EQUIPMENT RACK LEFT - ELECTRICAL
Scale: 3/4" = 1'-0"

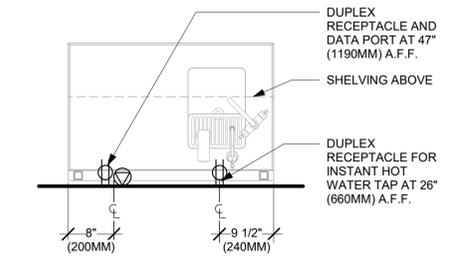


2 WATER FILLING STATION - ELECTRICAL
Scale: 3/4" = 1'-0"

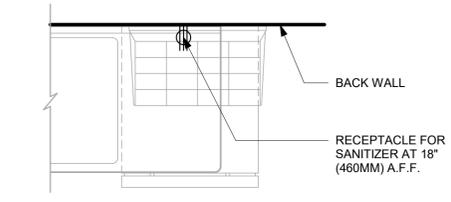


3 SANITIZING WORKSTATION - ELECTRICAL
Scale: 3/4" = 1'-0"

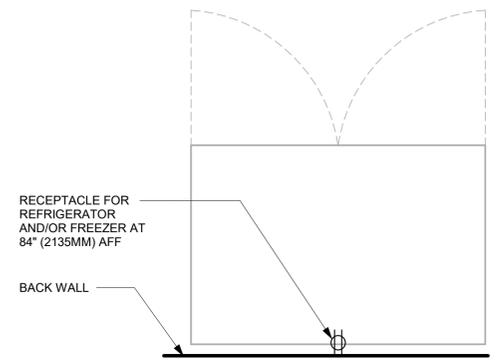

4 REFRIGERATOR/FREEZER - ELECTRICAL
Scale: 3/4" = 1'-0"

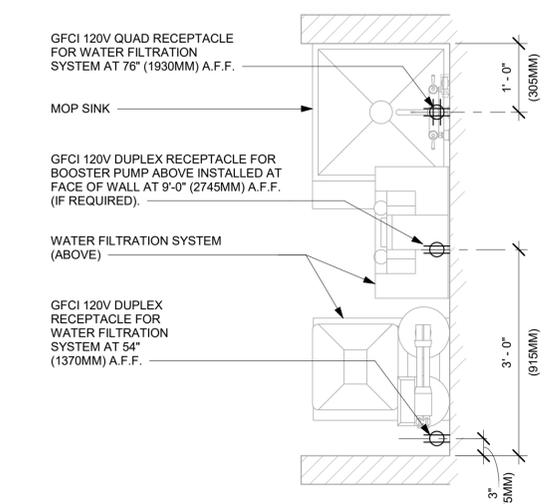

5 WATER FILTRATION - CONFIGURATION III
Scale: 3/4" = 1'-0"

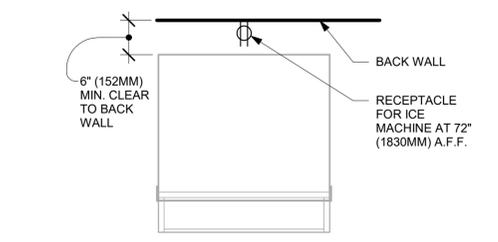

6 ICE MACHINE - ELECTRICAL
Scale: 3/4" = 1'-0"

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Timothy L. Roberding, PE
Professional Engineer
License: 62079



PROJECT NAME:
LECANTO HWY & NORVELL BRYANT

PROJECT ADDRESS:
**3159 W NORVELL BRYANT HWY
LECANTO, FL 34461**

STORE #: 78366
PROJECT #: 97107-001
ISSUE DATE: 09/06/2023
DESIGNER: RAI MONTERO
PRODUCTION DESIGNER: ANDY MCLLOUD
CHECKED BY: DONALD RETHMAN

Revision Schedule			
Rev	Date	By	Description


SHEET TITLE:
INTERIOR DETAILS

SCALE: 3/4" = 1'-0"


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I-506

BLD202323715


C:\Users\kallejennings\Documents\97107-001_78366_LECANTO HWY & NORVELL BRYANT, FL_2021_kallejennings.rvt
 9/6/2023 11:16:38 AM

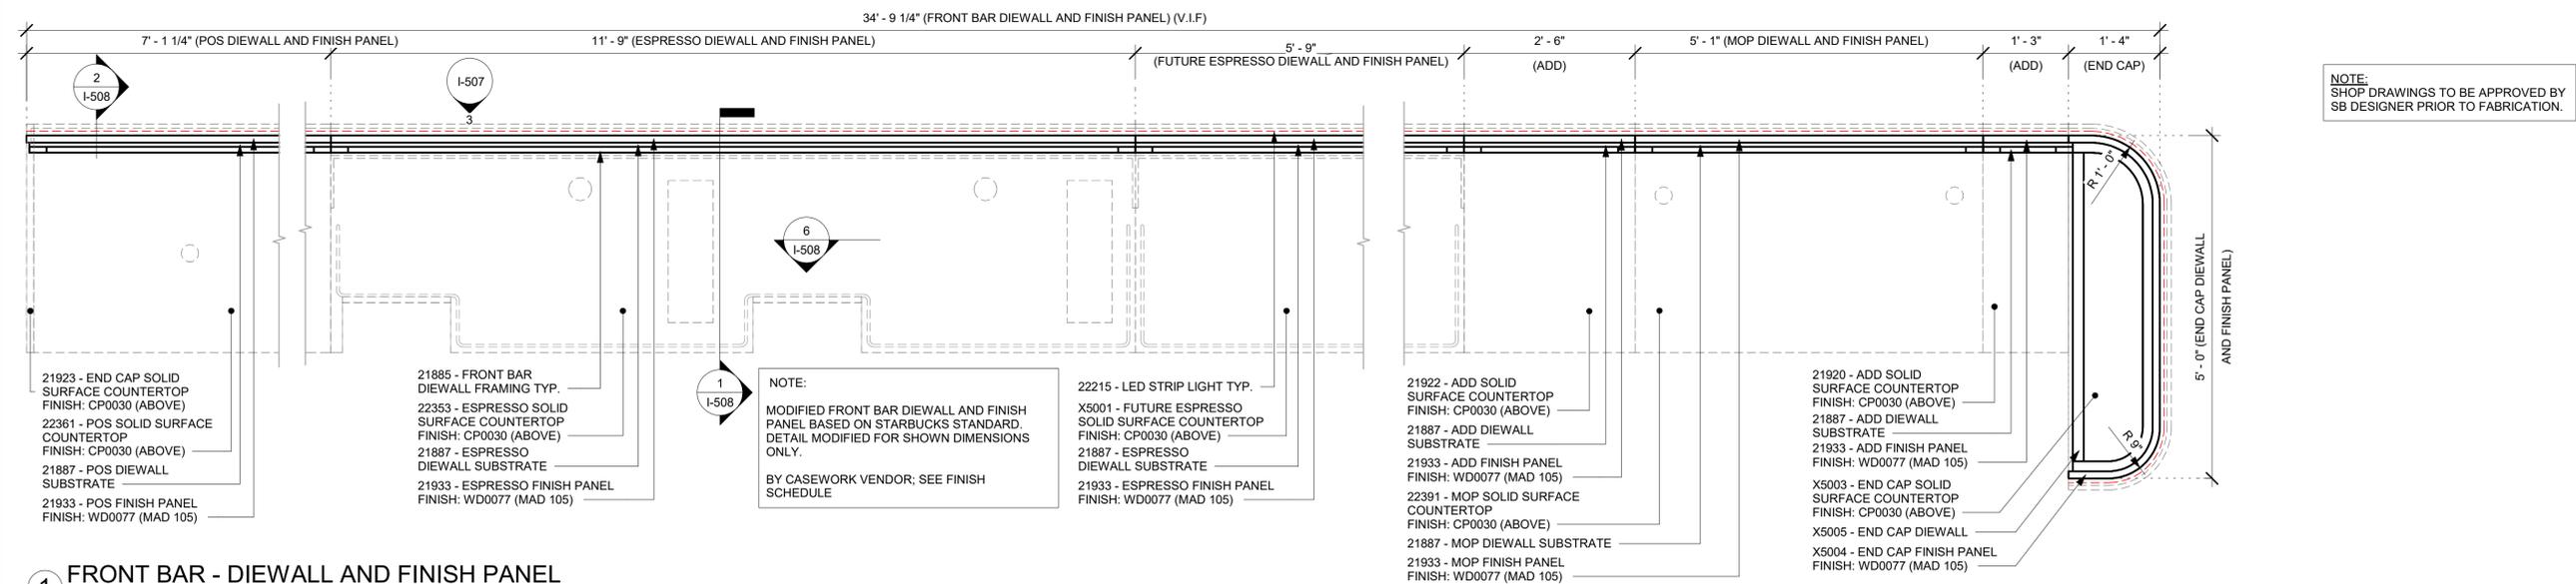

1 FRONT BAR - DIEWALL AND FINISH PANEL
 Scale: 3/4" = 1'-0"

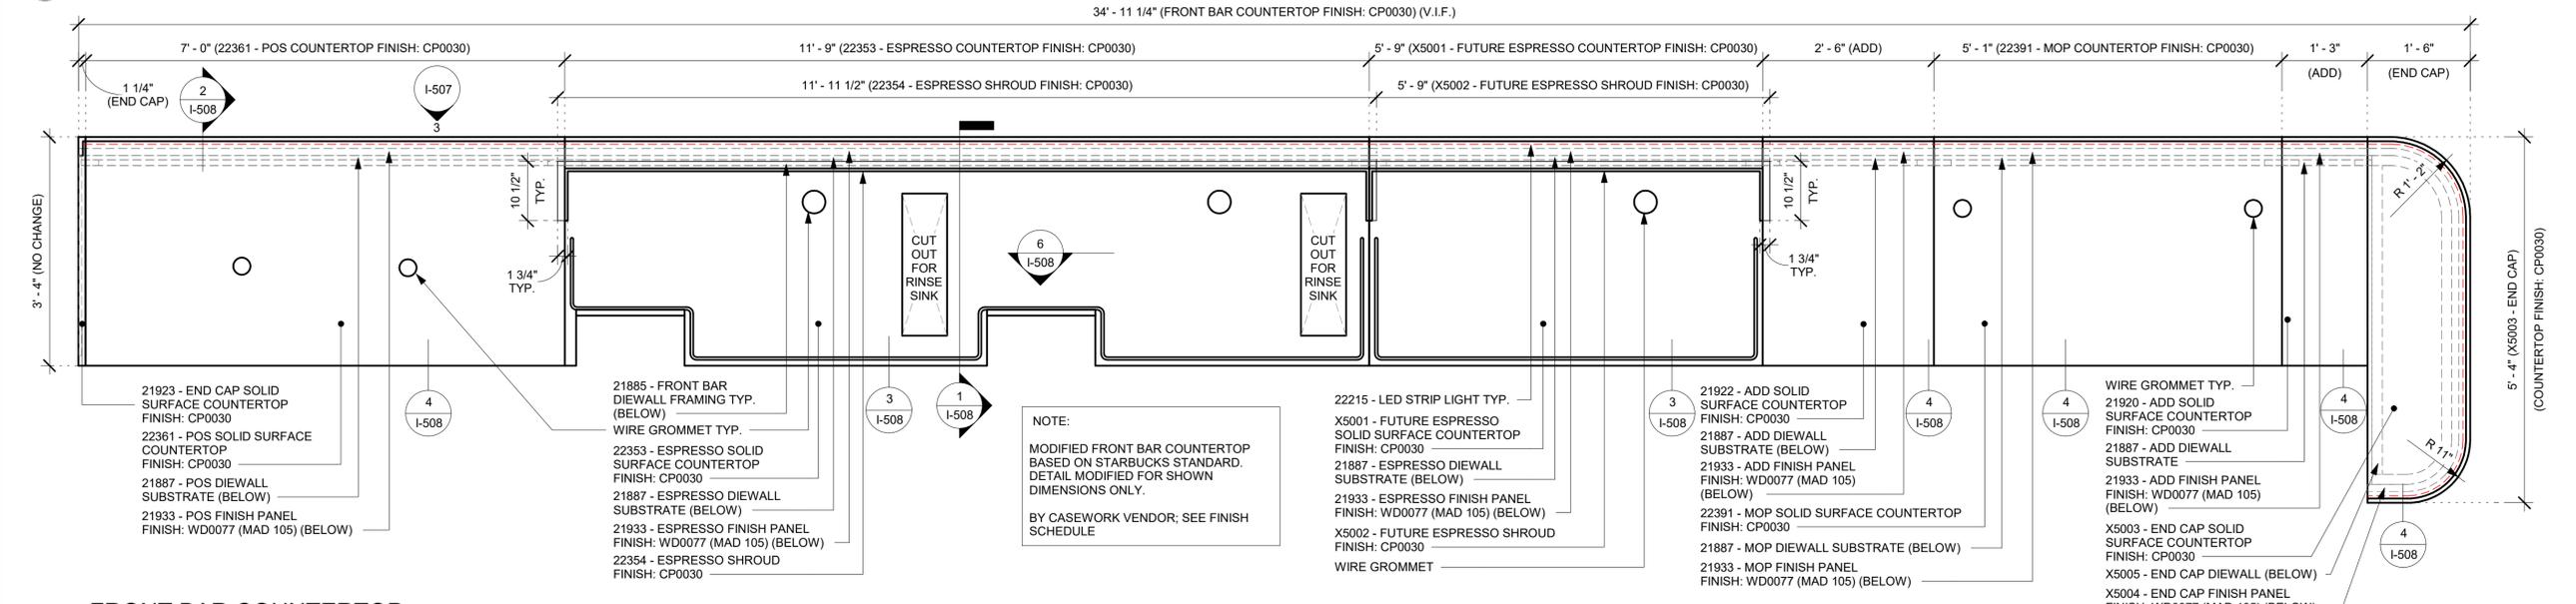

2 FRONT BAR COUNTERTOP
 Scale: 3/4" = 1'-0"

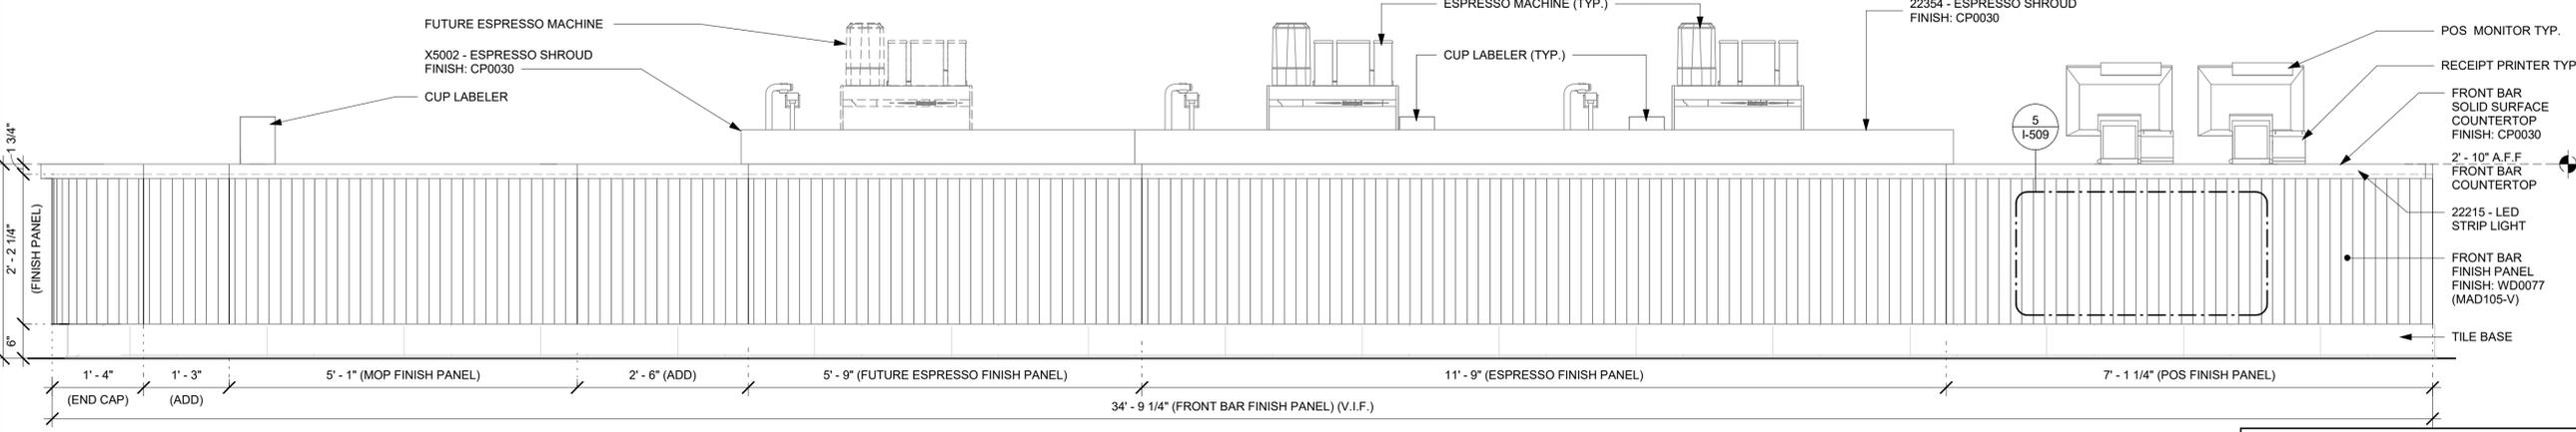

3 FRONT BAR FINISH PANEL - ELEVATION
 Scale: 3/4" = 1'-0"

NOTE:
 SHOP DRAWINGS TO BE APPROVED BY
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FOR CONSTRUCTION

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STORE #: 78366
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 ISSUE DATE: 09/06/2023
 DESIGNER: RAI MONTERO
 PRODUCTION DESIGNER: ANDY MCLLOUD
 CHECKED BY: DONALD RETHMAN

Revision Schedule			
Rev	Date	By	Description


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INTERIOR DETAILS

SCALE: 3/4" = 1'-0"

SHEET NUMBER:
I-507


BLD202323715

NOTE:
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1 DIGITAL MENU BOARD - PLAN

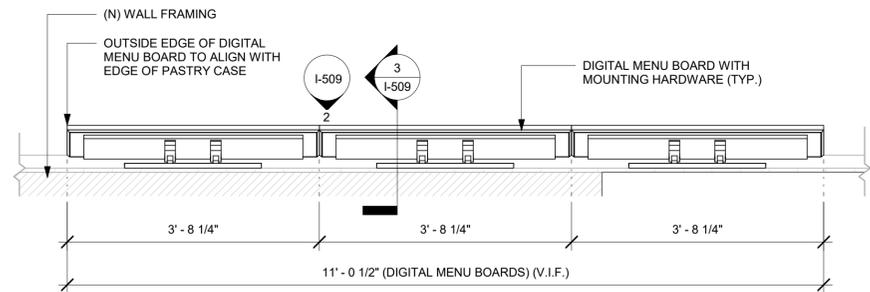
Scale: 3/4" = 1'-0"



- 1 (1) QUAD OUTLETS REQUIRED (ONE SHARED FOR 2 SCREENS), DEDICATED 15 AMP CIRCUIT FOR ALL THREE SCREENS.
- 2 (1) DUAL DATA PORTS (ONE SHARED WITH 2 DMB), ETHERNET CONNECTION TO RUN TO BOH EQUIPMENT RACK.
- 3 3/4" PLYWOOD BEHIND WALL FINISH BLOCKING SECURED TO STRUCTURE TO EXTEND .6IN FROM ALL SIDE

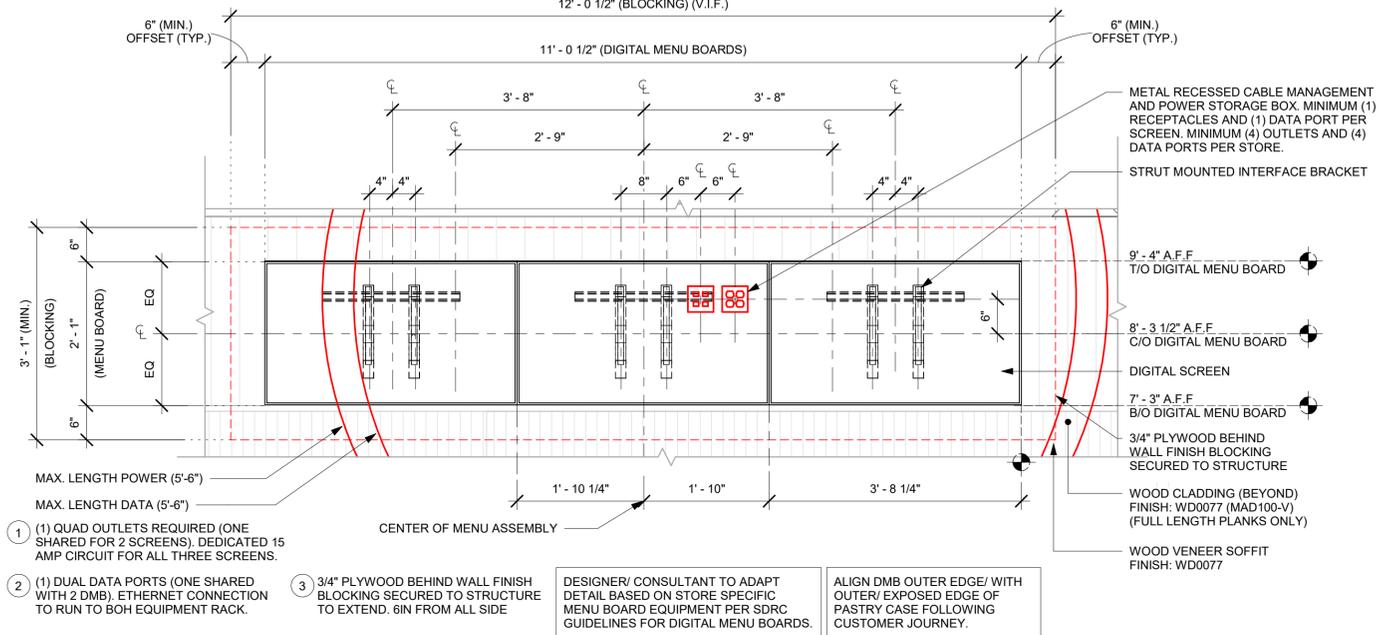DESIGNER/CONSULTANT TO ADAPT DETAIL BASED ON STORE SPECIFIC MENU BOARD EQUIPMENT PER SDRC GUIDELINES FOR DIGITAL MENU BOARDS.

ALIGN DMB OUTER EDGE/ WITH OUTER/ EXPOSED EDGE OF PASTRY CASE FOLLOWING CUSTOMER JOURNEY.

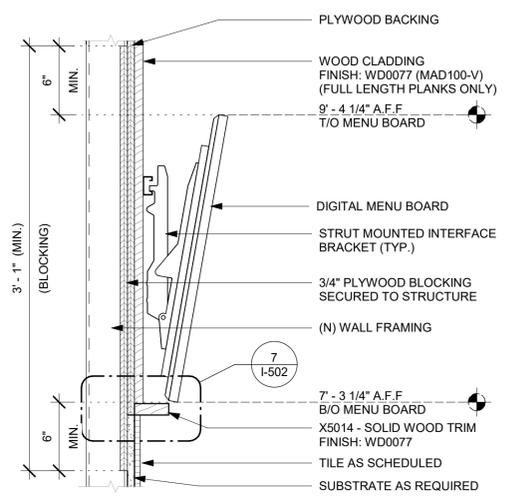


3 DIGITAL MENU BOARD - SECTION

Scale: 1 1/2" = 1'-0"

2 DIGITAL MENU BOARD - ELEVATION

Scale: 3/4" = 1'-0"

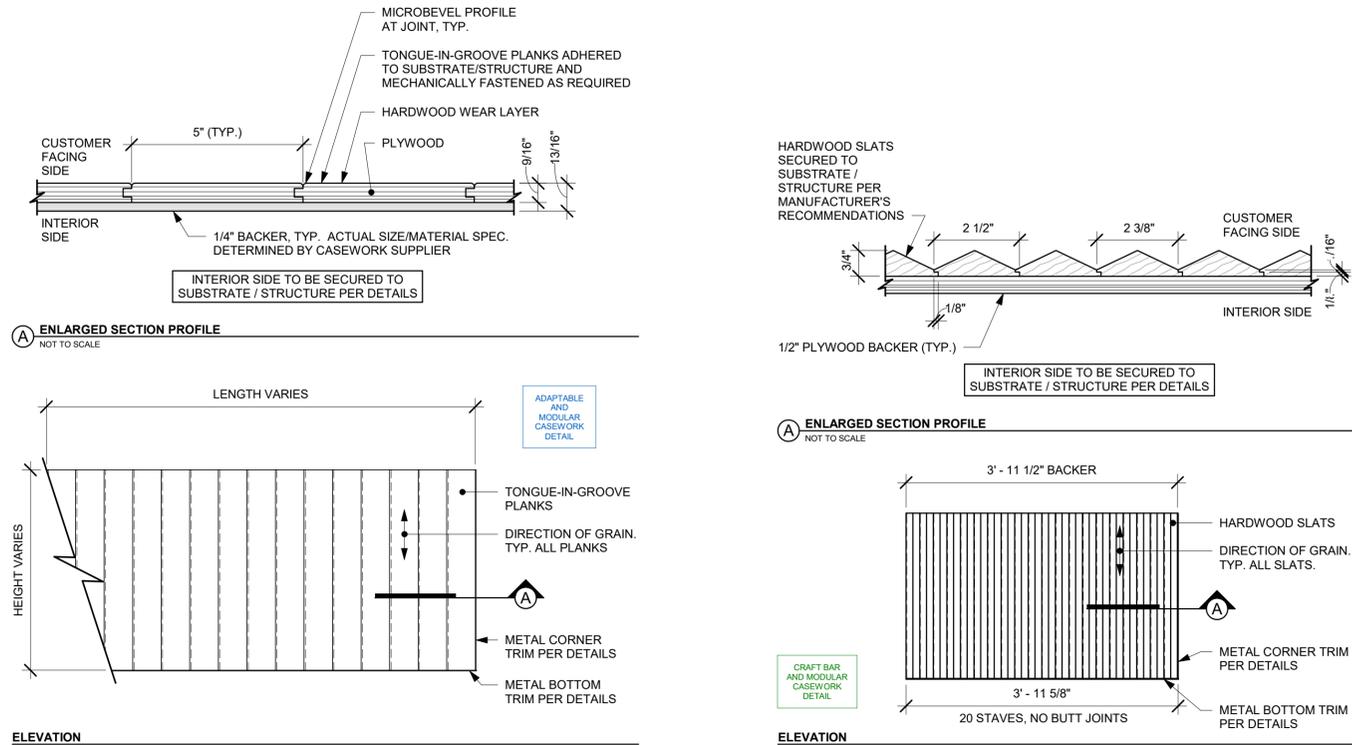

4 FINISH APPLICATION (MAD 100-V) FIXED WIDTH WIDE PLANK


Scale: 3/4" = 1'-0"

5 FINISH APPLICATION (MAD 105) SLAT - PEAKS

Scale: 3/4" = 1'-0"

6 21163 - MOP SIGNAGE - ELEVATION

Scale: 3" = 1'-0"

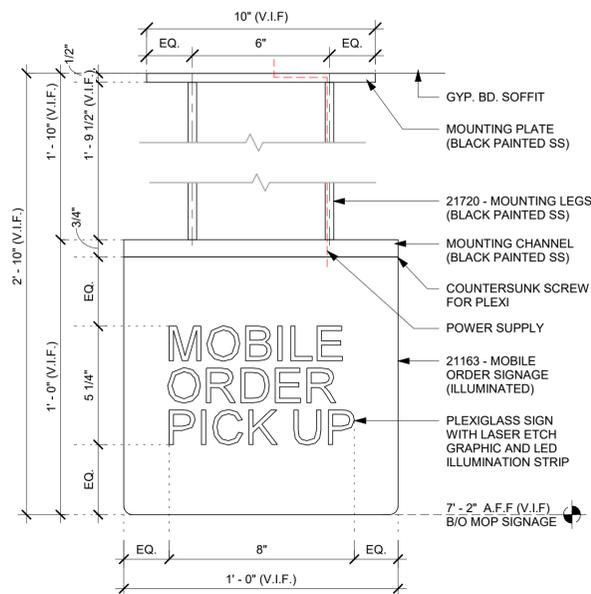

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DESIGNER: RAI MONTERO
PRODUCTION DESIGNER: ANDY MCLLOUD
CHECKED BY: DONALD RETHMAN

Revision Schedule			
Rev	Date	By	Description

SHEET TITLE:
INTERIOR DETAILS


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SHEET NUMBER:
I-509


BLD202323715

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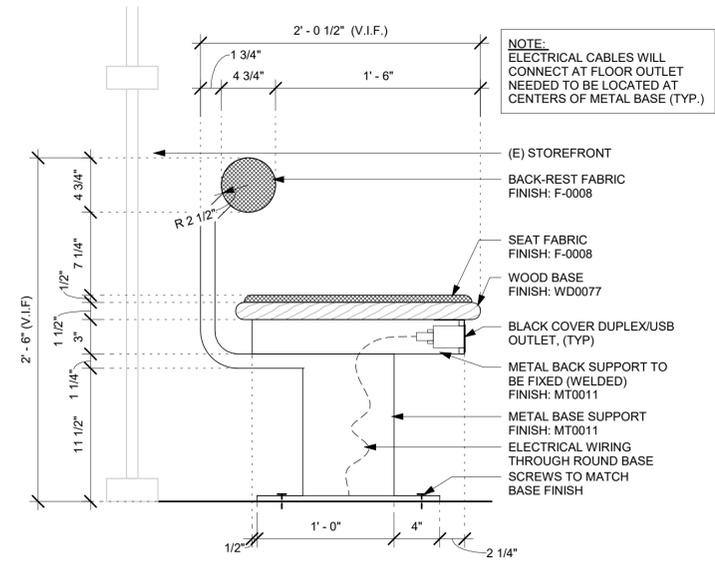
NOTE:
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SB DESIGNER PRIOR TO FABRICATION.




1 TK0001 - BANQUETTE - PLAN
Scale: 3/4" = 1'-0"

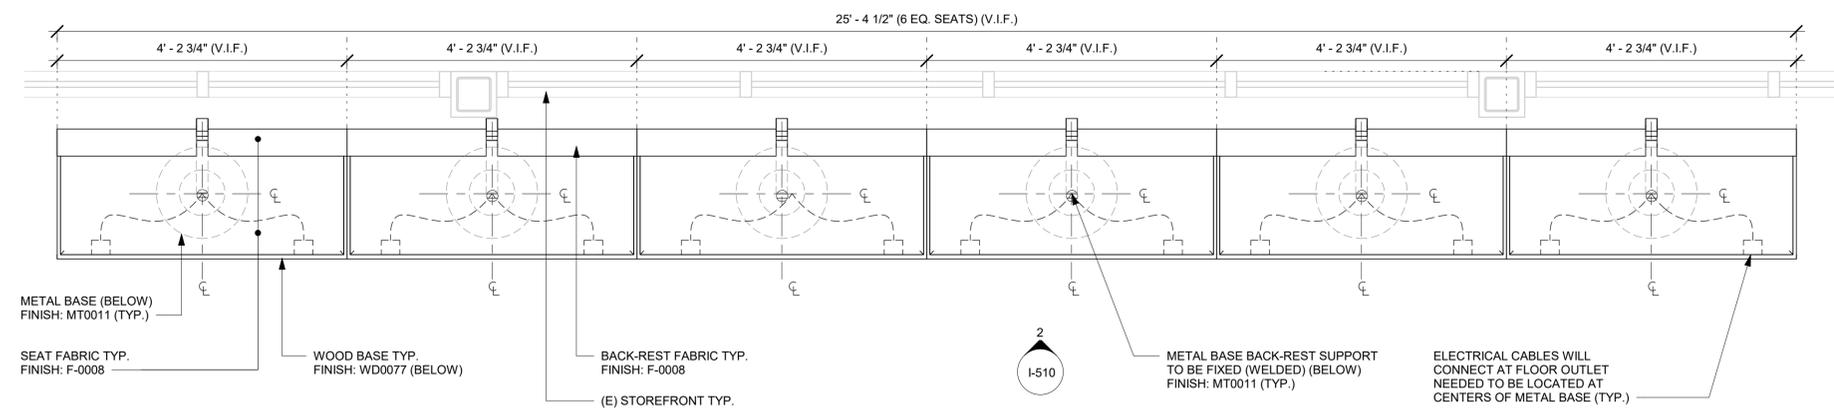

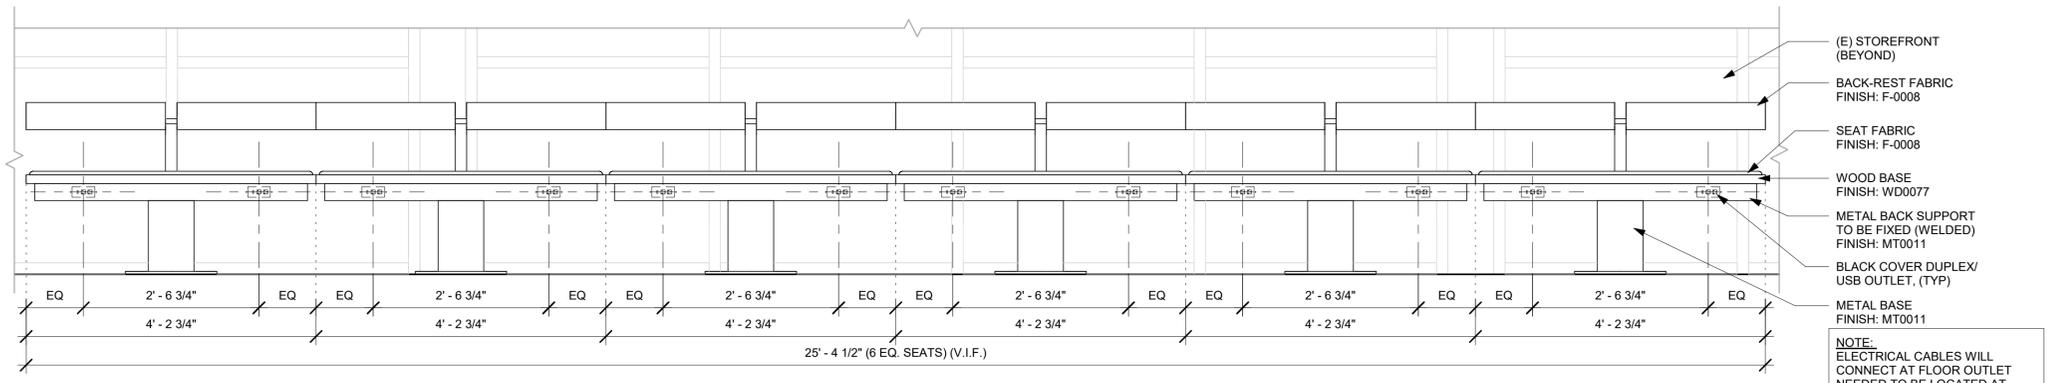
2 TK0001 - BANQUETTE - ELEVATION
Scale: 3/4" = 1'-0"




3 TK0001 - BANQUETTE - SECTION
Scale: 1 1/2" = 1'-0"

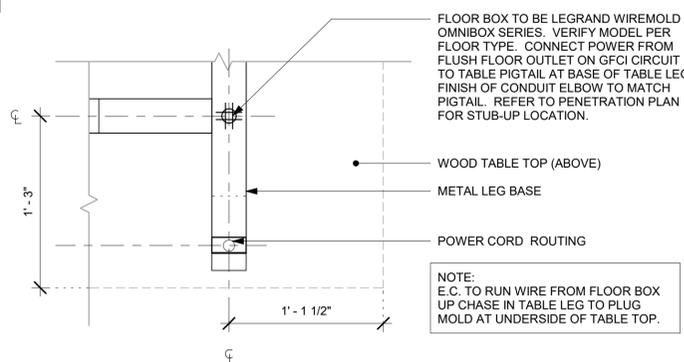

4 COMMUNITY TABLE LEG BASE PLAN
Scale: 1 1/2" = 1'-0"

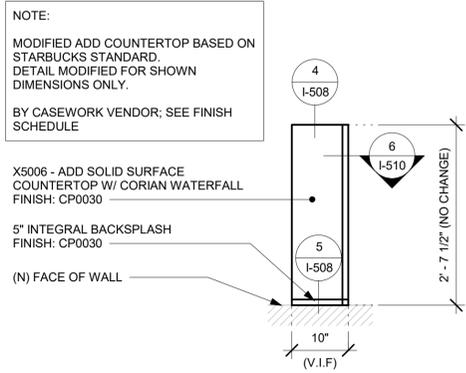

5 X5006 - ADD COUNTERTOP - PLAN
Scale: 3/4" = 1'-0"

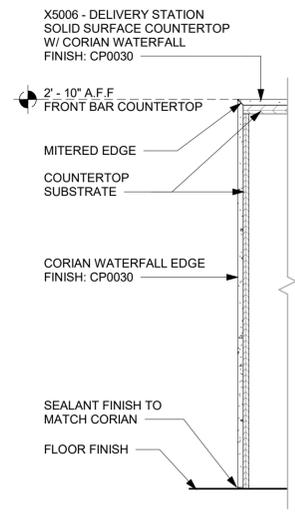

6 CORIAN WATER FALL - SECTION
Scale: 1 1/2" = 1'-0"



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FOR CONSTRUCTION

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DESIGNER: RAI MONTERO
PRODUCTION DESIGNER: ANDY MCLLOUD
CHECKED BY: DONALD RETHMAN

Revision Schedule			
Rev	Date	By	Description

SHEET TITLE:
INTERIOR DETAILS

SCALE: AS SHOWN

SHEET NUMBER:
I-510

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FOR CONSTRUCTION

PROJECT NAME:
LECANTO HWY & NORVELL BRYANT

PROJECT ADDRESS:
**3159 W NORVELL BRYANT HWY
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STORE #: 78366
PROJECT #: 97107-001
ISSUE DATE: 09/06/2023
DESIGNER: RAI MONTERO
PRODUCTION DESIGNER: ANDY MCLLOUD
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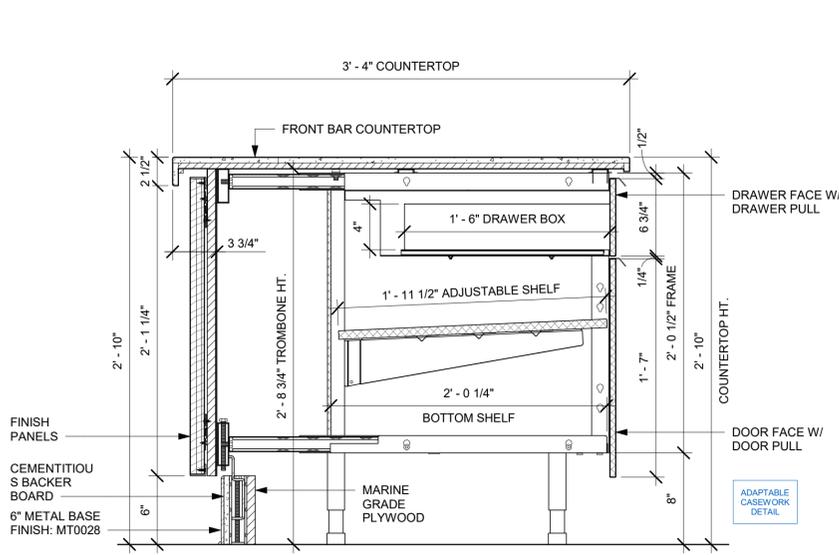
Revision Schedule			
Rev	Date	By	Description

SHEET TITLE:
INTERIOR DETAILS


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SHEET NUMBER:
I-511


NOTE:
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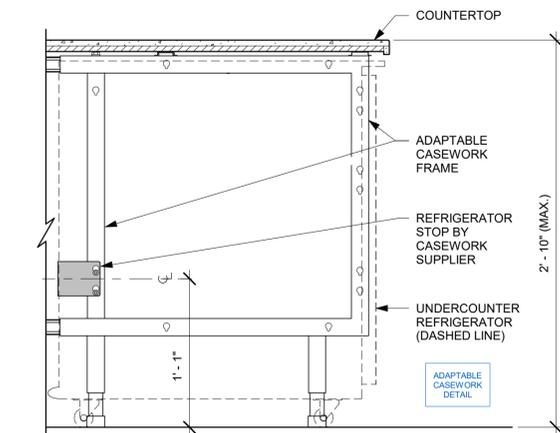
1 AC FRONT BAR DRAWER CABINET ASSEMBLY ON LEGS SECTION
Scale: 1 1/2" = 1'-0"




2 AC FRONT BAR CABINET ASSEMBLY ON LEGS SECTION
Scale: 1 1/2" = 1'-0"

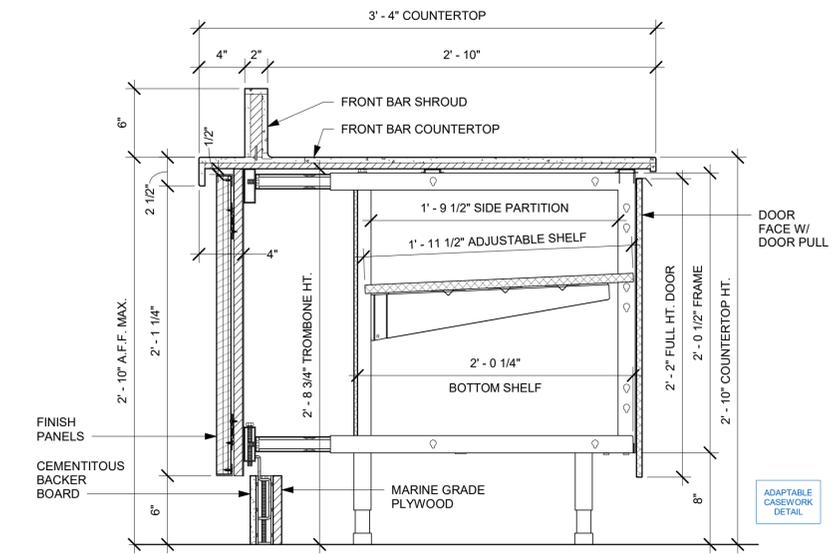


3 AC BACK BAR CABINET ASSEMBLY ON LEGS SECTION
Scale: 1 1/2" = 1'-0"

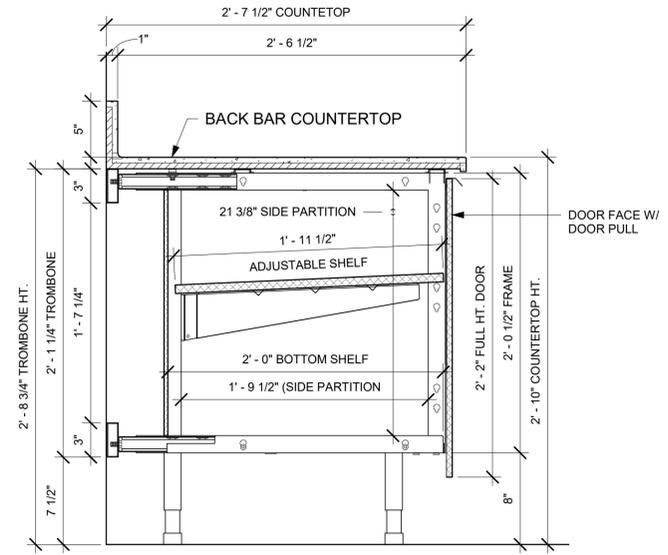


4 AC UNDERCOUNTER REFRIGERATOR SECTION
Scale: 1 1/2" = 1'-0"

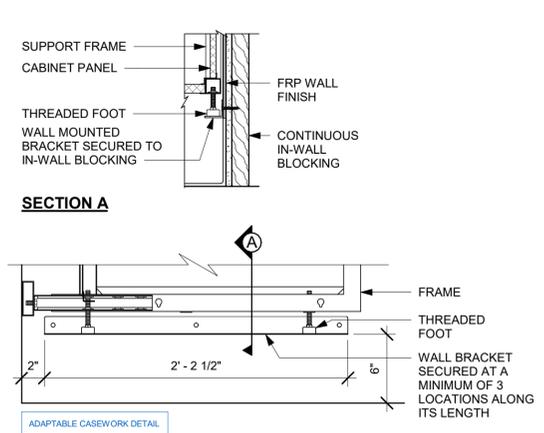



5 AC BACKLINE WALL BRACKET ASSEMBLY
Scale: 1 1/2" = 1'-0"

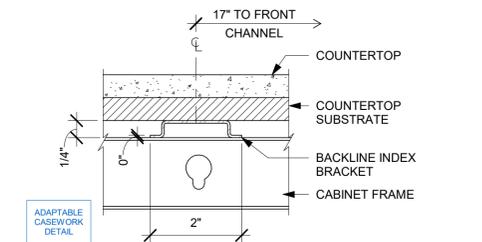

6 AC COUNTERTOP SUPPORT CHANNEL
Scale: 6" = 1'-0"

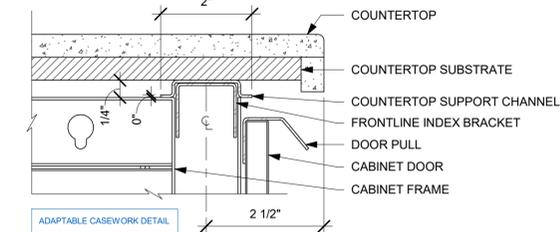

7 AC COUNTERTOP FRONT HAT SUPPORT CHANNEL
Scale: 6" = 1'-0"

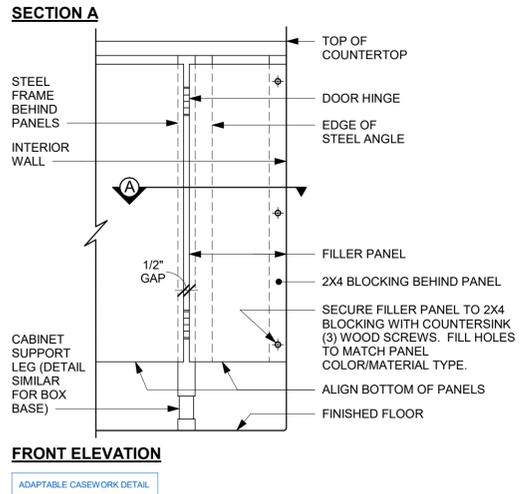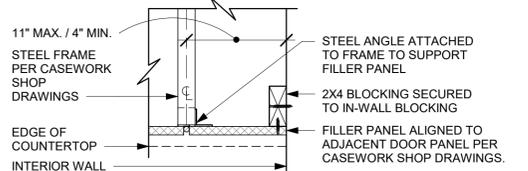

8 FILLER PANEL AT WALL
Scale: 1 1/2" = 1'-0"

BLD202323715

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DATA DEVICE SCHEDULE - "A"
DESIGN ID COUNT DESCRIPTION FURN. BY INST. BY COMMENTS
AUDIO VISUAL
10005 1 MUSIC SYSTEM SB GC

WALL BASE SCHEDULE - "B"
DESIGN ID LENGTH DESCRIPTION FURN. BY INST. BY COMMENTS
BASE TRIM
X9100 34'-6 1/2" FLOOR FRAME 16 GA 2B SS AROUND CUSTOM WALK-OFF MAT RECESSED GC GC

INTERIOR DOOR SCHEDULE - "D"
DESIGN ID COUNT DESCRIPTION FURN. BY INST. BY COMMENTS
DOOR
10086 1 DOOR - SINGLE IMPACT DOUBLE ACTING - 36IN 915MM - TYPE G SB GC

GRAPHICS AND ARTWORK SCHEDULE - "G"
DESIGN ID COUNT DESCRIPTION FURN. BY INST. BY COMMENTS
GRAPHIC - FILM
19458 12 INTERIOR WINDOW FILM FASARA - DUSTED CRYSTAL GC GC

WALL TREATMENT (AREA) SCHEDULE - "Q"
DESIGN ID AREA DESCRIPTION FURN. BY INST. BY COMMENTS
PLASTIC
11469 1655 SF FRP - WHITE GC GC

CASEWORK SCHEDULE - "C"
DESIGN ID COUNT DESCRIPTION FURN. BY INST. BY COMMENTS
CABINET
17580 2 CABINET - CBE TEA SHELF - 29IN 735MM - FLAT BLACK MT0028 SB GC

COUNTERTOP
21919 6 COUNTERTOP - FILLER BACKBAR - VARIABLE LENGTH SB GC
21920 1 COUNTERTOP - FRONTBAR - 15IN 380MM SB GC

DIEWALL
21885 17 DIEWALL - FRAMING - VARIABLE LENGTH SB GC
21886 6 DIEWALL - BASE - VARIABLE LENGTH SB GC

PAINT SCHEDULE
COLOR CODE DESCRIPTION LRV FURN. BY INST. BY COMMENTS
SW6074-ES SW - SPALDING GRAY - EGG SHELL 22 GC GC

SPECIALTY EQUIPMENT SCHEDULE - "E"
DESIGN ID COUNT DESCRIPTION FURN. BY INST. BY COMMENTS
COOLING
10267 6 FRIDGE UNDERCOUNTER 1 DOOR - 27IN 685MM SB GC

RESPONSIBILITY LEGEND
FURN. BY INST. BY
SB - FURNISHED BY STARBUCKS GC - INSTALLED BY GENERAL CONTRACTOR



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DESIGNER: RAI MONTERO
PRODUCTION DESIGNER: ANDY MCCLLOUD
CHECKED BY: DONALD RETHMAN

Revision Schedule
Rev Date By Description

SHEET TITLE: SCHEDULES
SCALE: NO SCALE

SHEET NUMBER: I-601

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FURNITURE SCHEDULE - "F"					
DESIGN ID	COUNT	DESCRIPTION	FURN. BY	INST. BY	COMMENTS
BANQUETTE					
TK0001	6	BANQUETTE - ORION - WALNUT AND CARAMEL BROWN NATURAL WD0077 F0008	SB	GC	SEE DETAIL: 1/1-510
CHAIR					
20082	12	CHAIR - CAFE PYRAMID - BLACK AND NATURAL ROPE MT0028 F0227	SB	GC	
20541	4	CHAIR - LOUNGE NEST - BLACK AND NATURAL ROPE MT0028 F0227	SB	GC	
21360	35	CHAIR - CAFE PEGGY - WALNUT WD0077	SB	GC	
21462	8	CHAIR - LOUNGE ASHER WOOD SEAT - WALNUT AND CARAMEL BROWN NATURAL WD0077 F0008	SB	GC	
TK0077	1	CHAIR - MANAGERS WORKSTATION	SB	GC	STEELCASE SERIES ONE ARMLESS
DESK					
TK0053	1	DESK - MANAGERS WORKSTATION SHELVES - 48IN 1220MM	SB	GC	
TK0076	1	DESK - MANAGERS WORKSTATION - 48X24X27IN 1220X610X685MM	SB	GC	
MIRROR					
14350	2	MIRROR - RESTROOM ANGLED- 18X36IN 455X915MM	SB	GC	INSTALLED AT CENTER OF (E) SINK, MIN. 40" A.F.F. TO B.O. MIRROR.
OTHER					
10756	2	COAT HOOK 1 PRONG SQUARE - 2IN 50MM - SST	SB	GC	
TK0051	1	COAT HOOK STRIP - 30IN 760MM	SB	GC	BLACK FINISH
STORAGE					
TK0078	1	FILE MOBILE PEDESTAL WITH CUSHION AND LOCK	SB	GC	
TK0079	1	MANAGERS DESK CART - 24X20IN 610X510MM	SB	GC	
TABLE					
17339	4	TABLE - CAFE METAL PEDESTAL BASE ROUND - 24IN 610MM - BLACK MT0028	SB	GC	
17341	2	TABLE - ACCESSIBLE METAL WITH TAPERED LEGS - 36X24IN 915X610MM - BLACK MT0028	SB	GC	
18404	1	TABLE - COMMUNITY CAFE HEIGHT ANGLE BASE - 10 SEAT NARROW - WITH POWER WALNUT WD0077	SB	GC	
20128	1	TABLE - OCCASIONAL COFFEE CAMERON - FLAT BLACK MT0028	SB	GC	
21449	12	TABLE - BASE CAFE HEIGHT BOTTLE - FLAT BLACK MT0028	SB	GC	
21453	2	TABLE - BASE ACCESSIBLE BOTTLE - FLAT BLACK MT0028	SB	GC	
21802	2	TABLE - TOP ACCESSIBLE ROUND EDGE OBLONG - 48X24IN 1220X610MM - WALNUT WD0077	SB	GC	
21841	5	TABLE - TOP ROUND EDGE ROUND - 24IN 610MM - WALNUT WD0077	SB	GC	
21844	5	TABLE - TOP ROUND EDGE ROUND - 30IN 760MM - WALNUT WD0077	SB	GC	
21847	2	TABLE - TOP ROUND EDGE SQUARE - 24IN 610MM - WALNUT WD0077	SB	GC	
22552	2	TABLE - OCCASIONAL COFFEE WING - WALNUT WD0077	SB	GC	
WINDOW TREATMENT					
22486	20	ROLLER SHADE - DARK BROWN - 5PC OPEN	SB	VD	OVERALL LENGTH REQUIRED:(VIF) (1) 6' - 0" LENGTH (9) 4' - 6 3/4" LENGTH (2) 3' - 10" LENGTH (2) 3' - 5" LENGTH (1) 3' - 2" LENGTH (2) 3' - 0" LENGTH

LIGHTING FIXTURE SCHEDULE - "L"						
DESIGN ID	COUNT	DESCRIPTION	FURN. BY	INST. BY	BULB	COMMENTS
EXIT						
19044	2	LED EXIT SIGN WITH EMERGENCY LIGHT - WHITE AND RED	SB	GC	INTEGRATED LED	
19047	3	LED EXIT SIGN WITH EMERGENCY LIGHT - BLACK AND GREEN	SB	GC	INTEGRATED LED	
19057	2	LED EMERGENCY LIGHT DOUBLE - BLACK	SB	GC	INTEGRATED LED	
RECESSED CAN						
21769	36	CAN - LED ADJUSTABLE RECESSED - 3IN 75MM - BLACK - 800LM SPOT	SB	GC	INTEGRATED LED	
21771	10	CAN - LED ADJUSTABLE RECESSED - 3IN 75MM - BLACK - 800LM FLOOD	SB	GC	INTEGRATED LED	
X7001	22	CUSTOM CAN - LED ADJUSTABLE RECESSED	SB	GC		EXTERIOR CANOPY LIGHT
SCONCE						
20748	2	SCONCE - KUZCO PLUTO TRIPLE - CHROME	SB	GC	INTEGRATED LED	
STRIP						
22215	2	STRIP - LED TAPE IN HOUSING - VARIABLE LENGTH - BLACK - 350LM PER FT	SB	GC	INTEGRATED LED	FIELD TRIMMABLE TO 0.9 IN LENGTHS V.I.F (1) 24' - 0" (1) 17' - 10"
TRACK						
12947	2	TRACK - WITH CONNECTORS - 8FT 244CM - BLACK - 1 CIRCUIT	SB	GC		
12948	6	TRACK - WITH CONNECTORS - 16FT 488CM - BLACK - 1 CIRCUIT	SB	GC		ALL BAR / CAFE TRACK LIGHTING TO BE RUN THROUGH 1A / 2A CURRENT LIMITING DEVICE #RCLF12BL-TCL2BL; SEE ELECTRICAL DRAWINGS FOR ADDITIONAL INFORMATION
12949	3	TRACK - WITH CONNECTORS - 12FT 365CM - BLACK - 1 CIRCUIT	SB	GC		ALL BAR / CAFE TRACK LIGHTING TO BE RUN THROUGH 1A / 2A CURRENT LIMITING DEVICE #RCLF12BL-TCL2BL; SEE ELECTRICAL DRAWINGS FOR ADDITIONAL INFORMATION
15058	2	TRACK - WITH CONNECTORS - 8FT 183CM - BLACK - 1 CIRCUIT	SB	GC		
15059	3	TRACK - WITH CONNECTORS - 6FT 183CM - WHITE - 1 CIRCUIT	SB	GC		
21777	29	TRACK - LED FIXTURE WITH SNOOT - 3IN 75MM - BLACK - 1100LM SPOT	SB	GC	INTEGRATED LED	ALL BAR / CAFE TRACK LIGHTING TO BE RUN THROUGH 1A / 2A CURRENT LIMITING DEVICE #RCLF12BL-TCL2BL; SEE ELECTRICAL DRAWINGS FOR ADDITIONAL INFORMATION
TROFFER						
21783	7	TROFFER - LED RECESSED - 24X48IN 600X1200MM - WHITE - 4300LM	SB	GC	INTEGRATED LED	

MECHANICAL EQUIPMENT SCHEDULE - "M"					
DESIGN ID	COUNT	DESCRIPTION	FURN. BY	INST. BY	COMMENTS
FAN					
X8001	2	CEILING FAN ALTUS - BRUSHED ALUMINUM	SB	GC	COORDINATE WITH DM
OTHER					
17797	1	ENERGY MANAGEMENT SYSTEM - HVAC ONLY	SB	GC	

PLUMBING FIXTURE SCHEDULE - "P"					
DESIGN ID	COUNT	DESCRIPTION	FURN. BY	INST. BY	COMMENTS
DRAIN					
10294	8	DRAIN - FLOOR SINK SQUARE - 12IN 305MM	SB	GC	
10594	2	DRAIN - FLOOR SINK SQUARE - 5IN 125MM	GC	GC	ZURN ZN415B
10726	8	DRAIN - GRATE HALF SQUARE - 12IN 305MM	SB	GC	
FAUCET					
10152	1	FAUCET - DOUBLE LABORATORY WITH BENT RISER SPOUT	SB	GC	
10153	4	FAUCET - WATER TOWER - 12IN 305MM	SB	GC	
10215	2	FAUCET - DOUBLE LABORATORY WITH SWING SPOUT	SB	GC	
10447	1	FAUCET - PRE RINSE SPRAYER WALL MOUNTED	SB	GC	
10597	2	FAUCET - SINGLE HANDLE	SB	GC	0.5 GPM FLOW RATE
10804	1	FAUCET - PRE RINSE SWING SPOUT	SB	GC	
10874	1	FAUCET - HOT WATER DISPENSER GOOSENECK	SB	GC	
10922	1	FAUCET - MOP SINK WALL MOUNTED	SB	GC	
10943	1	FAUCET - SINGLE LABORATORY WITH SWING SPOUT	SB	GC	
11003	2	FAUCET - METERED	SB	GC	
13588	1	FAUCET - HAND SINK WALL MOUNTED	SB	GC	
21352	2	FAUCET - RESTROOM WITH MOTION SENSOR	SB	GC	
22642	2	FAUCET - INSTANTHOT SYSTEM 2 BUTTON WITH BOILER AND BRACKET	SB	GC	KIT INCLUDES FONT, UNDERCOUNTER BOILER AND BOILER BRACKET FOR SIDE PANEL MOUNTING. BRACKET CAN BE FLOOR MOUNTED USING SET OF (4) STAINLESS STEEL LEGS, ORDERED SEPARATELY THROUGH VENDOR.
FILTER					
12501	1	FILTER - RO SYSTEM 600GPD	SB	VD	
12507	1	FILTER - RO SYSTEM STORAGE TANK RO40	SB	VD	
12896	1	FILTER - BRINE TANK	SB	VD	
12899	2	FILTER - POLY GLASS VESSEL	SB	VD	
13076	1	FILTER - PREFILTRATION SYSTEM	SB	VD	
13082	1	FILTER - WATER SOFTENER TWIN	SB	VD	
OTHER					
22224	1	WATER HEATER TANK ELECTRIC - 13.5KW	GC	GC	13.5KW BRADFORD WHITE E32-50S-3 30GAL ELECTRIC
SINK					
10116	2	SINK - RESTROOM WALL MOUNTED	SB	GC	
10549	1	SINK - RINSE DROP IN SST - 12X20IN 305X510MM	SB	GC	
10995	1	SINK - MOP - 24X24IN 610X610MM	SB	GC	
13264	1	SINK - 3 COMP WORK SST - 93IN 2350MM	SB	GC	
14688	1	SINK - HAND WITH SIDE SPLASH WALL MOUNTED SST	SB	GC	
18743	1	SINK - WATER FILLING STATION - 36X24IN 915X610MM	SB	GC	
22630	1	SINK - RINSE DROP IN - 27X26IN 685X670MM	SB	GC	
22768	2	SINK - COUNTERTOP RINSER WITH WATER TOWER - 26X9IN 660X235MM	SB	GC	
TOILET					
X8010	2	TOILET - TANK EFFICIENT SINGLE FLUSH; 1.0GPF	GC	GC	KOHLER MODEL K-3519 FINISH: WHITE #0. REQUIRES SEPARATE SEAT MODEL K-4650; 1.0 GPF

WALL TREATMENT (LENGTH) SCHEDULE - "R"					
DESIGN ID	LENGTH	DESCRIPTION	FURN. BY	INST. BY	COMMENTS
CHAIR RAIL					
X1206		CHAIR RAIL - 1"X5" - CORIAN CP0030	SB	GC	FINISH: CP0030; SEE DETAIL: 16/I502; PROVIDED BY CASEWORK VENDOR; MOUNTED AT 28IN (710MM) AFF
TRIM					
X9202	6' - 8"	SCHLUTER JOLLY TRIM	GC	GC	LOCATION: TILE TO PAINT; SEE DETAIL: 16/I-502
WOOD WAINSCOT					
X1207		WOOD WAINSCOT - WD0077 MAD105	SB	GC	FINISH: WD0077 (MAD105); SEE DETAIL: 16/I502; PROVIDED BY CASEWORK VENDOR; MOUNTED AT 28IN (710MM) AFF

EXTERIOR SIGNAGE SCHEDULE - "S"					
DESIGN ID	COUNT	DESCRIPTION	FURN. BY	INST. BY	COMMENTS
SIGNAGE - DISK					
13163	1	SIGN - DISK SF ILLUMINATED FLUSH MOUNTED EVOLVED - 48IN 1220MM	SB	VD	
13164	1	SIGN - DISK SF ILLUMINATED FLUSH MOUNTED EVOLVED - 60IN 1525MM	SB	VD	
SIGNAGE - DRIVE THRU					
14091	1	SIGN - DT DIRECTIONAL EXIT SIGN ILLUMINATED ARROW SERIES - 46IN 1170MM	SB	VD	SUPERIOR SIGNAGE; SEE DETAIL: 5 & 7/APX-104
14104	2	SIGN - DT DIRECTIONAL ILLUMINATED ARROW SERIES WITH LOGO - 46IN 1170MM	SB	VD	SEE DETAIL: 4 & 7/APX-104
14331	1	SIGN - DRIVE THRU ILLUMINATED ARROW SERIES FLUSH MOUNTED - RH - 60IN 1525MM	SB	VD	
22544	1	SIGN - DT CLEARANCE BAR SQUARE FRAME FREESTANDING - BLACK AND DARK GREEN	SB	VD	SEE DETAIL: 2 & 3/APX-104
SIGNAGE - OTHER					
21297	3	SIGN - 5 MINUTE PARKING	SB	VD	POST, IF REQUIRED, PROVIDED BY OTHERS
X0002	1	SIGN - NICE TO SEE YOU	SB	VD	ALUMINUM PANEL WITH VIYNL GRAPHICS ATTACHED TO ALUMINUM FRAME
SIGNAGE - WORDMARK					
18497	1	SIGN - WORDMARK STARBUCKS FLUSH MOUNTED - 18IN 455MM	SB	VD	

INTERIOR SIGNAGE SCHEDULE - "S"					
DESIGN ID	COUNT	DESCRIPTION	FURN. BY	INST. BY	COMMENTS
INTERIOR SIGNAGE					
21163	1	SUSPENDED MOP SIGNAGE - ILLUMINATED - CEILING MOUNTED	SB	GC	SEE DETAIL: 6/I-509; VENDOR: HILTON SIGNAGE
21720	1	MOBILE ORDER PICK UP SUSPENSION KIT	SB	GC	SHIP IN 2-6 WEEKS; VENDOR: HILTON; SEE DETAIL: 6/I-509

FLOOR TREATMENT SCHEDULE - "T"					
DESIGN ID	AREA	DESCRIPTION	FURN. BY	INST. BY	COMMENTS
CONCRETE					
11377	1290 SF	CONCRETE - NATURAL POLISHED	GC	GC	
TILE					
19795	952 SF	POLYVINYL FLOOR SHEET - ECO-GRIP - PEWTER - 60X96IN 1524X2438MM	GC	GC	
WALK OFF MAT					
19288	39 SF	WALK OFF MAT - HELIX Z1 - BLACK - 12X9IN 305X230MM	SB	GC	(1) 3' X 40"; (1) 3' X 76"; (4) 2' X 45"; PAINT CONCRETE FLOOR UNDER WALK-OFF MAT WITH BLACK PAINT

CEILING TREATMENT SCHEDULE - "U"					
DESIGN ID	AREA	DESCRIPTION	FURN. BY	INST. BY	COMMENTS
OTHER					
19734	475 SF	ACT - ULTIMA - 2X2FT 61X61CM	GC	GC	FACTORY FINISHED SW7037 BALANCED BEIGE ; FOR ORDERING CONTACT DEB PICKENS AT DPLPICKENS@ARMSTRONGCEILING.COM, PH: 480-695-9053
X9301	1023 SF	CIRRUS SECOND LOOK ILLING - 2X4FT 61X122CM LINEAR PANELS (II PANEL SCORING CREATES NOMINAL 8INX4FT)	GC	GC	PROVIDED BY: ARMSTRONG; FACTORY FINISHED BY MANUFACTURER TO MATCH SW7039-ES

WINDOW SCHEDULE - "W"					
DESIGN ID	COUNT	DESCRIPTION	FURN. BY	INST. BY	COMMENTS
WINDOW					
10118	1	WINDOW - DT HURRICANE RATED - 48X44IN 1205X1105MM - ALUMINUM	EXIST	EXIST	LL TO SPECIFY IMPACT GLASS OR NON-IMPACT GLASS AS REQUIRED. CONTACT DAN RADEK AT dan@ready-access.com 1-800-621-5045

SITE SCHEDULE - "Y"					
DESIGN ID	COUNT	DESCRIPTION	FURN. BY	INST. BY	COMMENTS
X4002	1	CUSTOM MONUMENT SIGN			
EXTERIOR MENU					
22540	1	MENU BOARD - DT 5 PANEL SQUARE FRAME FREESTANDING - 95X62IN 2415X1575MM - BLACK	SB	VD	SEE DETAIL: 1B/APX-103
22542	1	MENU BOARD - DT PRE MENU SQUARE FRAME FREESTANDING - 29X61IN 735X1550MM - BLACK	SB	VD	SEE DETAIL: 2B/APX-103
22546	1	MENU BOARD - DT DIGITAL ORDER SCREEN WITH POST - BLACK	SB	VD	SEE DETAIL: 1/APX-103.2
OTHER					
10042	2	BIKE RACK HOOP	EXIST.	EXIST.	SEE DETAIL: 10 & 11/APX-104
10163	1	DT WINDOW SHELF - 56IN OBSIDIAN PAPERSTONE	EXIST	EXIST	SEE DETAIL: 4/APX-103.1
14095	1	DT WAYFINDING GRAPHIC EXIT ARROW - WHITE	EXIST.	EXIST.	SEE DETAIL: 9/APX-104
14101	1	DT WAYFINDING GRAPHIC ENTRY ARROW - GREEN	EXIST.	EXIST.	SEE DETAIL: 8/APX-104
14323	5	DT WAYFINDING GRAPHIC DIRECTIONAL DOUBLE ARROW - GREEN			REFERENCE PAINT 20512 FOR SPECIFICATIONS; SEE DETAIL: 7/APX-104
14324	1	DT WAYFINDING GRAPHIC DIRECTIONAL DOUBLE ARROW - WHITE	EXIST.	EXIST.	REFERENCE PAINT 20511 FOR SPECIFICATIONS; SEE DETAIL: 7/APX-104
X4001	25	CIRCULAR BOLLARD - 6" DIA	EXIST.	EXIST.	SEE DETAIL: 1/APX-104
X4002	4	FLEXSTAKE DELINEATOR POST, 48" HIGN PERFORMANCE LEVEL	SB	VD	POST, IF REQUIRED, PROVIDED BY OTHERS
X4003	1	PATIO RAILING	EXIST	EXIST	SEE DETAIL: 2/APX-105

RESPONSIBILITY LEGEND

FURN. BY	INST. BY
SB - FURNISHED BY STARBUCKS	GC - INSTALLED BY GENERAL CONTRACTOR
GC - FURNISHED BY GENERAL CONTRACTOR	SB - INSTALLED BY STARBUCKS
VD - FURNISHED BY VENDOR	VD - INSTALLED BY VENDOR

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Revision Schedule			
Rev	Date	By	Description